


NOTES:

- DEMOLITION KEY NOTES:**
- 1 REMOVE EXISTING ASPHALT SHINGLE ROOFING SYSTEM. ALL ROOF RELATED FLASHING (INCLUDING VALLEY SHEATHING, AND UNDERLAYMENTS OVER ENTIRE EXISTING ROOF TO EXPOSE EXISTING SHEATHING. PREPARE FOR NEW CONSTRUCTION. SEE GENERAL NOTES #21 AND #22.
 - 2 REMOVE EXISTING EPDM ROOFING SYSTEM. ALL ROOF RELATED FLASHING, AND UNDERLAYMENTS OVER PORTION OF EXISTING ROOF AS NOTED TO EXPOSE EXISTING SHEATHING. REMOVE EXISTING LOCALIZED CRACKED OVERBUILT. PREPARE FOR NEW CONSTRUCTION.
 - 3 REMOVE EXISTING HOPPERED BERBERG ROOFING SYSTEM. ALL ROOF RELATED FLASHING AND UNDERLAYMENTS OVER ENTIRE EXISTING ROOF TO EXPOSE EXISTING SHEATHING. PREPARE FOR NEW CONSTRUCTION.
 - 4 REMOVE ALL EXISTING PRE-FINISHED EVESTROUGH AND RAIN WATER LEADERS.
 - 5 REMOVE ALL EXISTING PRE-FINISHED FASCIA AND PRE-FINISHED VENTED SOFFIT INCLUDING TRIMS. PREPARE FOR NEW CONSTRUCTION. COORDINATE REMOVAL WITH SOFFIT RECESSED LUMINAIRES (AT BUILDING ENTRY POINTS) WHICH ARE TO REMAIN.
 - 6 REMOVE ALL EXISTING PRE-FINISHED FIRE WALL CAP FLASHING ASSEMBLY. PREPARE FOR NEW CONSTRUCTION.
 - 7 EXISTING PLUMBING VENT LOCATION TO REMAIN. CUT EXIST PLUMBING VENT PIPE BELOW ROOF LINE TO PREPARE FOR NEW PIPE EXTENSION THROUGH ROOF LINE. SEE DET. 3A-5.
 - 8 EXISTING PLUMBING VENT LOCATION TO BE REMOVED AND RELOCATED. PREPARE FOR NEW CONSTRUCTION. SEE DETAIL 3A-5.
 - 9 EXISTING MECHANICAL FLUE LOCATION (TYPE B VENT) TO REMAIN. REMOVE EXISTING BASE FLASHING AND PREPARE FOR NEW CONSTRUCTION. SEE DETAIL 2A-5.
 - 10 EXISTING METAL AIR INTAKE / PENNHOUSE TO BE REMOVED TO PREPARE FOR NEW CONSTRUCTION. SAVE EXISTING AIR INTAKE / PENNHOUSE ASSEMBLY FOR REUSE IN NEW CONSTRUCTION AS NOTED. SEE DETAIL 6A-5.
 - 11 EXISTING ATTIC VENT ROOF LOUVER LOCATION TO BE REMOVED. PREPARE FOR NEW CONSTRUCTION. IN-FILL LOCATIONS NOT BEING REUSED WITH SHEATHING TO MATCH EXIST.
 - 12 EXISTING ROOF CAP LOCATION TO BE REMOVED. SAVE EXISTING ROOF CAP ASSEMBLY FOR REUSE IN NEW CONSTRUCTION AS NOTED. SEE GENERAL NOTE 31.
 - 13 EXISTING EXHAUST FAN ON PRE-FABRICATED METAL CURB TO BE REMOVED TO PREPARE FOR NEW CONSTRUCTION. SAVE EXISTING EXHAUST FAN ASSEMBLY. CURB CONSTRUCTION AND EXISTING DUCT FOR REUSE IN NEW CONSTRUCTION AS NOTED.
 - 14 REMOVE EXISTING SHEET METAL FINISH FROM EXISTING 12" PLYWOOD / 2X4 FRAMED BOX OUT UNDER EXISTING EAVE. PREPARE FOR NEW CONSTRUCTION AS NOTED.

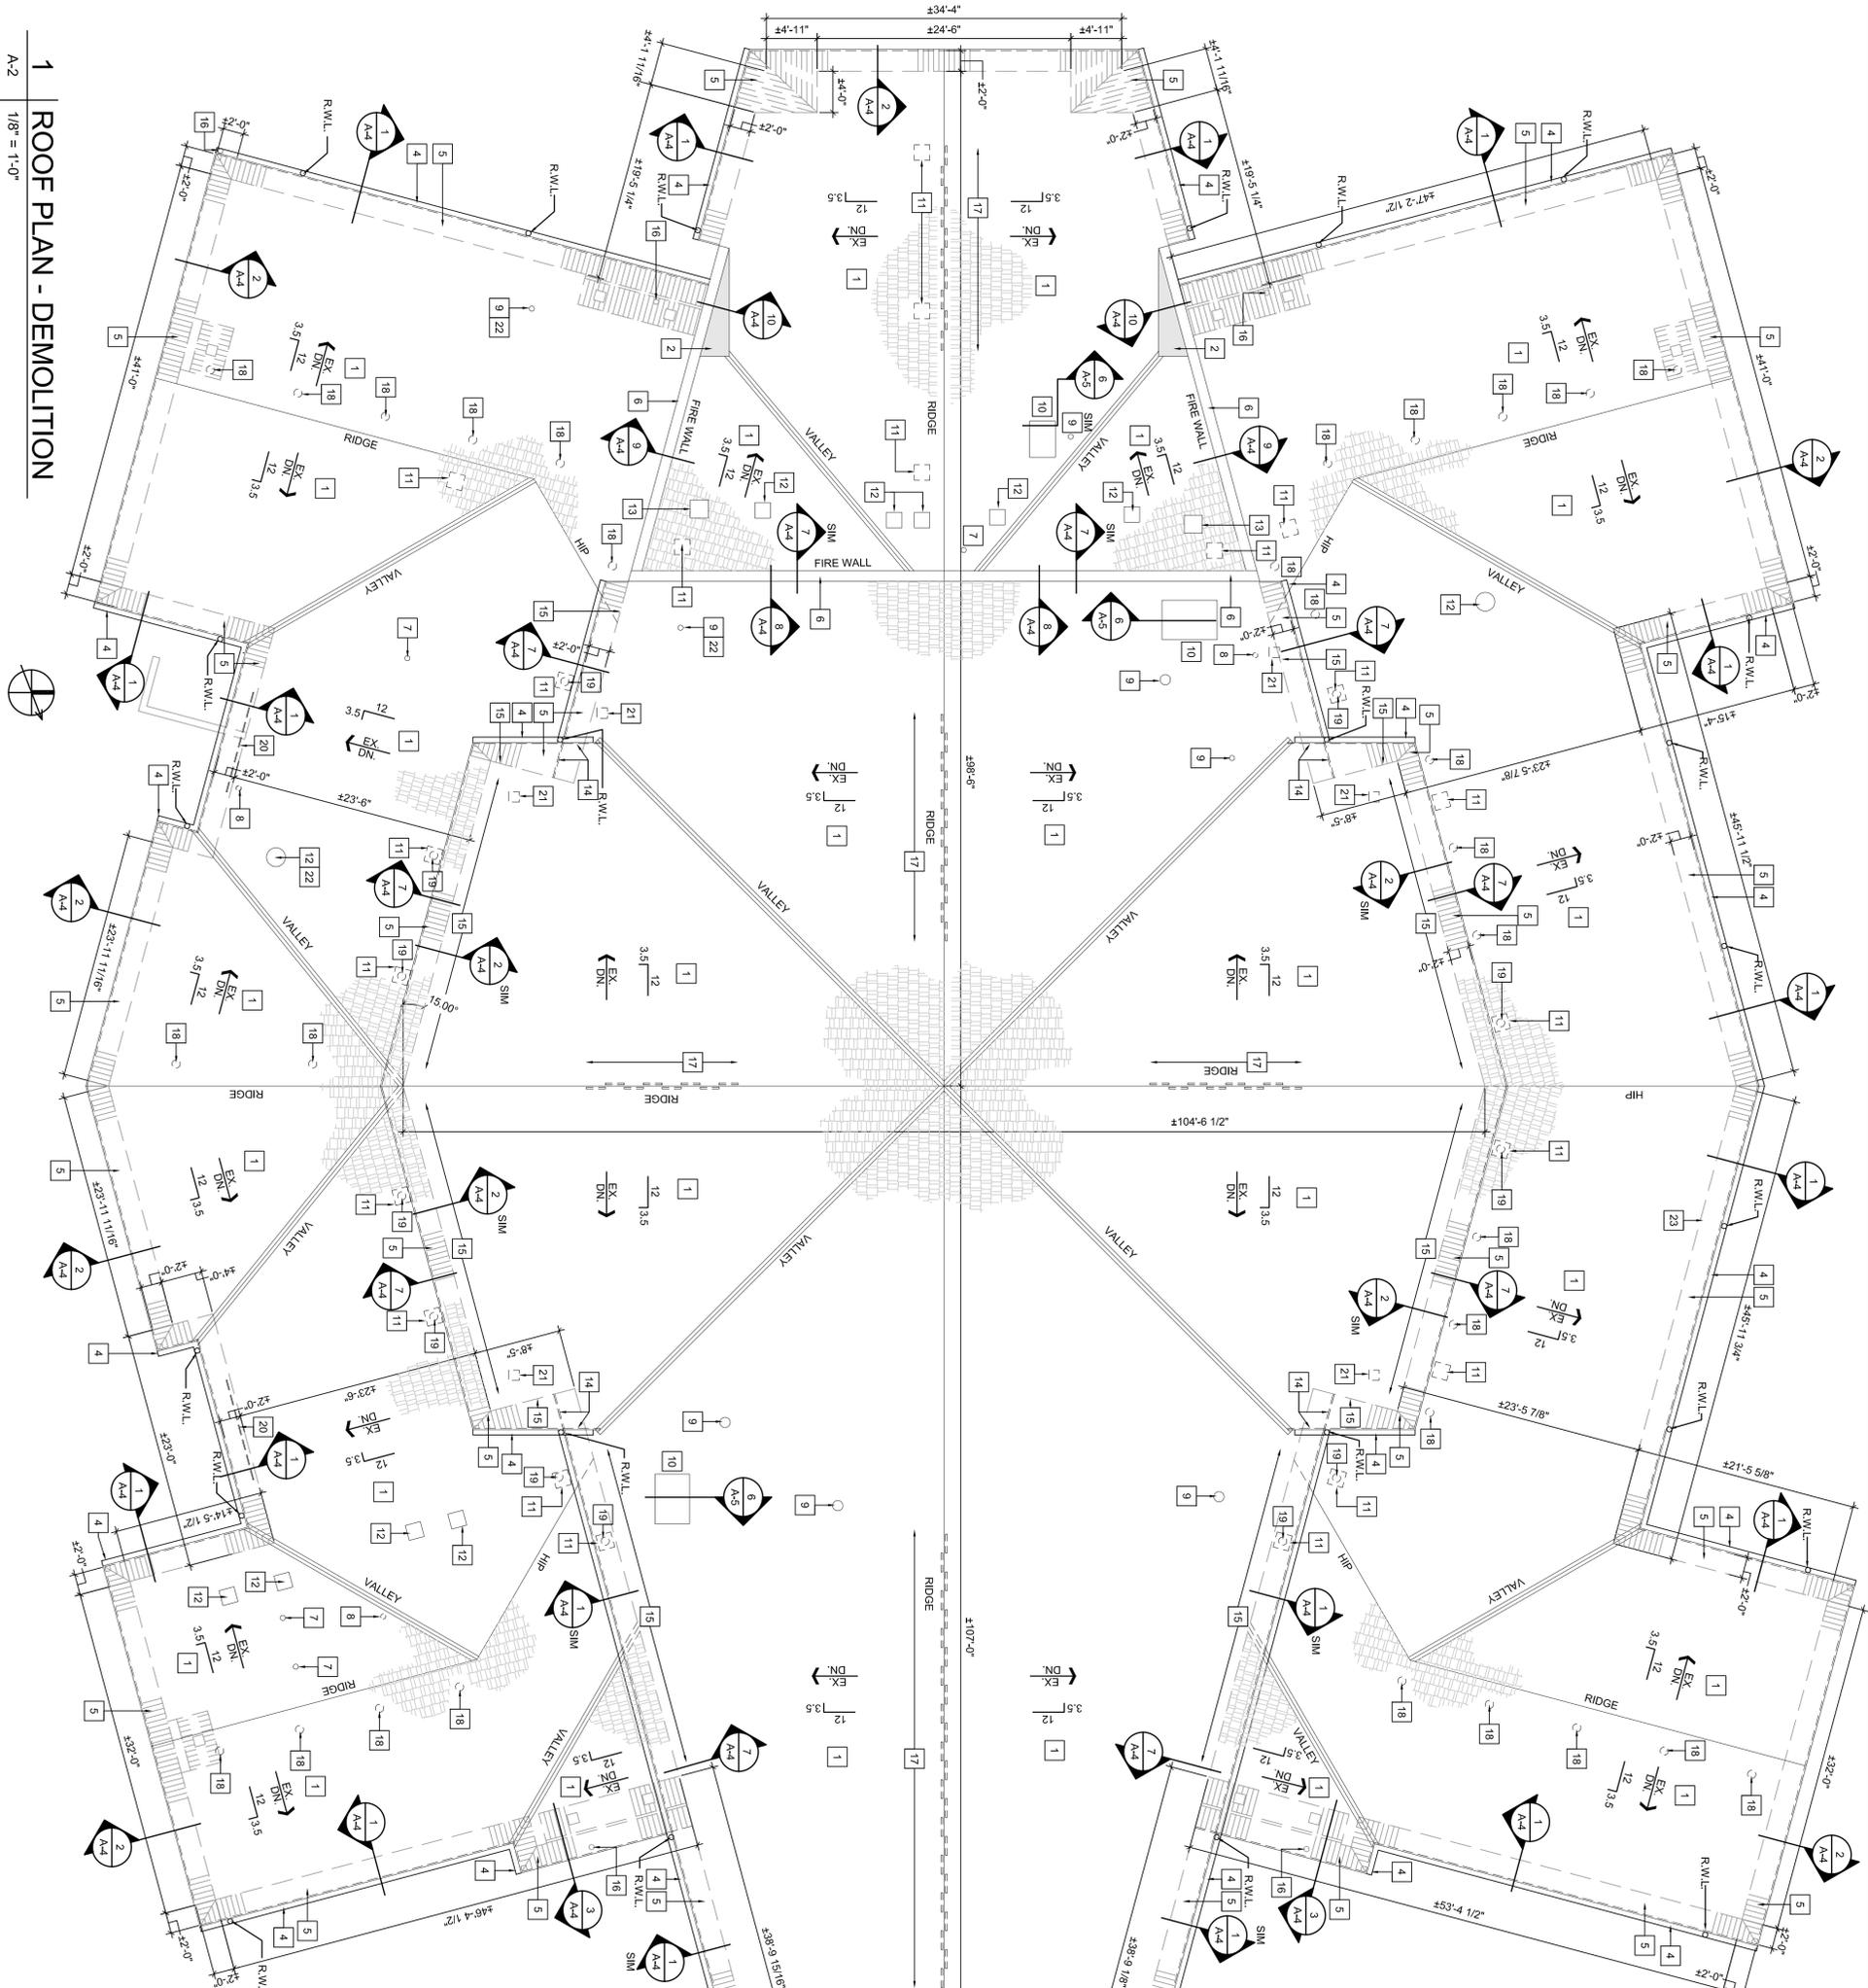


1 | ROOF PLAN - DEMOLITION

A-2 1/8" = 1'-0"

2 | SHED - DEMO

A-2 1/8" = 1'-0"

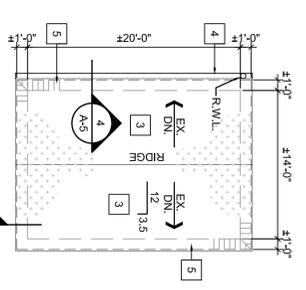

- 15 AT EXISTING ROOF / BRICK WALL INTERFACE. REMOVE EXISTING METAL FLASHING IN REGLET. CALLING / SEALANT AND EXISTING METAL COUNTER FLASHING. PREPARE FOR NEW CONSTRUCTION AS NOTED. SEE DETAIL 7A-4.
- 16 EXISTING FASCIA AND/OR SOFFIT MOUNTED SENSORS TO BE REMOVED TO ALLOW NEW CONSTRUCTION. PROTECT AND SAVE FOR REINSTALLATION AT EXISTING PREVIOUS LOCATION.
- 17 SAWCUT VENT STRIP OPENINGS INTO EXISTING PLYWOOD ROOF SHEATHING TO SUIT NEW ATTIC RIDGE VENT. SEE NEW ROOF PLAN AND DETAILS.
- 18 SAWCUT VENT OPENING INTO EXISTING PLYWOOD ROOF SHEATHING TO SUIT NEW ATTIC VENT. SEE NEW ROOF PLAN AND DETAILS. REFER TO MANUFACTURER REQUIREMENTS.
- 19 SAWCUT VENT OPENING INTO EXISTING PLYWOOD ROOF SHEATHING TO SUIT NEW ATTIC VENT. MODIFY AND/OR CLOSE OFF EXISTING OPENING TO ALLOW NEW OPENING TO BE COORDINATED WITH NEW ATTIC VENT. SEE NEW ROOF PLAN AND DETAILS. REFER TO MANUFACTURER REQUIREMENTS.
- 20 SAWCUT VENT OPENING INTO EXISTING PLYWOOD ROOF SHEATHING TO SUIT NEW ATTIC (INTAKE) VENT. REFER TO MANUFACTURER REQUIREMENTS.
- 21 SAWCUT VENT OPENING INTO EXISTING PLYWOOD ROOF SHEATHING TO SUIT NEW ATTIC (INTAKE) VENTILATOR. SEE NEW ROOF PLAN AND DETAIL. REFER TO MANUFACTURER REQUIREMENTS.
- 22 REMOVE EXISTING VENT CAP DUE TO DAMAGE. PREPARE FOR REPLACEMENT CAP MATCHING EXISTING DIMENSIONS AND MATERIAL.
- 23 REMOVE RWL / CONDUIT / REFRIGERATION SHROUD. PREPARE FOR REPLACEMENT SHROUD. SEE NEW ROOF PLAN.

PROJECT FOR:
THE CHURCH OF JESUS CHRIST OF LATTER-DAY SAINTS

PROJECT NAME:
VICTORIA 2, 3 ROOF
VICTORIA BRITISH COLUMBIA STAKE

PROJECT ADDRESS:
1919 10th Avenue SW
VICTORIA, BC V8S 2E6

ROOF RESTORATION

DRAWING DESCRIPTION:
ROOF PLAN - DEMOLITION

PROJECT DESIGNATION:
5162500210-0101

WORK ORDER NO.:
5162500210-0101

PROPERTY NO.:
5162500210-0101

PROJECT TYPE:
5162500210-0101

DATE ISSUED:
JUNE 2021

REVIEWED BY:
EZH

DRAWING NO.:
A-2

ISSUED FOR:	NO.	DATE	DESCRIPTION

SEAL:

PROJECT ARCHITECTURE INC. PROJ. NO.:
2114

SEAL:


DRAWINGS ARE NOT TO BE SCALED. Confirm all dimensions on site. Any discrepancies in the drawings or field should be reported immediately to the design office. The client is responsible for the accuracy of the information provided.

NOTES:


- 1 NEW ASPHALT SHINGLES AND UNDERLAYMENTS AS DETAILLED AND SPECIFIED OVER EXISTING ROOF. PRIOR TO INSTALLING NEW UNDERLAYMENTS, INSPECT EXISTING ROOF AND REMOVE ALL DETRIMENTAL ROOF SHEATHING IN AREAS SUCH AS BUT NOT LIMITED TO VALLEYS AROUND PERIMETER AND AT VERTICAL WALL INTERSECTIONS. ASSUME SUPPLY AND INSTALL PER SHEETS 12, 13, 14, 999, 1000.
- 2 NEW EPDM ROOF ASSEMBLY AS DETAILLED AND SPECIFIED OVER NEW / MODIFIED LOCALIZED CRACKLET ROOF. PRIOR TO INSTALLING NEW EPDM ASSEMBLY, ASSUME SUPPLY AND INSTALL OF 4 SHEETS (4' X 8') OF 58" PLYWOOD SHEATHING IN BID PRICE WILL BE REMOVED AND REPACKED. VAL NEW SHEATHING W/ 3" NAILS AT 7" O.C. ALONG EDGES AND 12" O.C. IN FIELD. SEE SPECIFICATIONS FOR ROOF SYSTEM. SEE DETAIL 14/A-4.
- 3 NEW VALLEY FLASHING. SEE DETAIL 11/A-5. SEE SPECIFICATION.
- 4 NEW PRE-FINISHED 6" K-STYLE EAVESSTROUGH CW NEW PRE-FINISHED METAL SPLASH DIVERTERS AT VALLEY 7' EAVESSTROUGH INTERSECTIONS AND 3/4" PRE-FINISHED METAL RAIN WATER LEADERS. SEE DETAIL 19/A-6. SEE SPECIFICATION.
- 5 NEW PRE-FINISHED METAL FASCIA AND PRE-FINISHED METAL VENTED SOFFIT INCLUDING TRIMS. SEE DETAILS AND SPECIFICATION. COORDINATE NEW SOFFIT W/ EXISTING SOFFIT RECESSED LUMINAIRE / TRIM KIT (AT BUILDING ENTRY POINTS) WHICH ARE TO REMAIN. COORDINATE SOFFIT AND TRIM W/ MASONRY WALL PROFILE WHICH VARIES.
- 6 NEW PRE-FINISHED FIRE WALL CAP FLASHING ASSEMBLY. SEE DETAILS AND SPEC.
- 7 EXIST PLUMBING VENT LOCATION TO REMAIN. CUT EXIST PLUMBING VENT PIPE BELOW ROOF LINE TO PREPARE FOR NEW PIPE EXTENSION THROUGH ROOF LINE. SEE DET. 3/A-5.
- 8 EXISTING PLUMBING VENT LOCATION REMOVED / RELOCATED TO NEW LOCATION. SEE DETAIL 3/A-5. PATCH REPAIR AND MILL OLD PENETRATION LOCATION W/ SHEATHING TO MATCH EXISTING ADJACENT PRIOR TO APPLICATION OF NEW ROOFING ASSEMBLY.
- 9 EXISTING MECHANICAL FLUE (TYPE B VENT) TO REMAIN. PROVIDE NEW JACK FLASHING W/ STAINLESS STEEL COLLAR AND PROVIDE NEW UNDERLAYMENT (SHIRAZ STYLED) TO PROMOTE WATERPROOFING FROM BUILDING ENVELOPE. REMOVE DENTS, SAND AND PAINT TO MATCH PRE-FINISHED WEATHERED COPPER COLOR. SEE DETAIL 2/A-5.
- 10 EXISTING METAL AIR INTAKE / PENHOUSE MODIFIED TO ALLOW HIGHER CURB STRUCTURE AND ROOF CRACKLET. REMOVE DENTS, SAND AND PAINT TO MATCH PRE-FINISHED WEATHERED COPPER COLOR. SEE DETAIL 10/A-5.

NEW CONSTRUCTION KEY NOTES:


- 11 NEW ATTIC VENT ROOF LOUVER EXHAUST LOCATION (70 SQ. IN. NET FREE AREA REQUIRED PER VENT - LOMANCO 710. SEE SPECIFICATION REGARDING COLOR). VENT LOCATIONS THAT ARE OBTAINED BY THE UPPER ROOF OVERHANG. THESE LOCATIONS ARE TO BE SHIFTED TOWARDS THE MASONRY EXTERIOR WALL (TOP OF ROOF ATTIC VOLUME). LOCATIONS ON DRAWING ARE SHOWN AS IS FOR CLARITY. AT ALL ROOF LOUVER LOCATIONS, ENSURE OPENING HOLE IN ROOF SHEATHING WHEN NEW OR ROUGHED MEETS THE OPENING REQUIREMENTS AS SET BY THE LOUVER MANUFACTURER. SEE SPECIFICATION.
- 12 NEW ATTIC VENT ROOF LOUVER EXHAUST LOCATION (60 SQ. IN. NET FREE AREA REQUIRED PER VENT - LOMANCO 720. SEE SPECIFICATION REGARDING COLOR).
- 13 NEW ATTIC EXHAUST RIDGE VENT LOCATION. SEE DETAILS ON DWG A-6. SEE SPEC.
- 14 NEW ATTIC GRANITE INTAKE VENTILATOR LOCATION (THROAT 14.0 SQ. IN. NET FREE AREA REQUIRED PER VENTILATOR - CAROLINE MODEL 910). SEE DETAIL 11/A-6.
- 15 NEW ATTIC VENT ROOF DECK INTAKE LOCATION - OFF ROOF EDGE INSTALL CW TAPERED TERMINATION (68 SQ. IN. NET FREE AREA REQD. PER 4" D.I.M. LENGTH OF VENT - LOMANCO DECK-4IN. D/A-4).
- 16 EXIST ROOF CAP TO BE REMOVED TO ALLOW FOR NEW ASPHALT ROOF SHINGLES AND UNDERLAYMENTS. SAVE EXIST. ROOF CAP FOR REUSE (LUMESSE NOTED OTHERWISE DUE TO EXCESSIVE DAMAGE). REMOVE DENTS, SAND & PAINT TO MATCH PRE-FINISHED WEATHERED COPPER COLOR PRIOR TO REINSTALLATION.
- 17 EXISTING EXHAUST FAN ON PRE-FABRICATED METAL CURB TO BE REMOVED TO ALLOW FOR NEW ASPHALT ROOF SHINGLES AND UNDERLAYMENTS. SAVE EXISTING EXHAUST FAN ASSEMBLY. CURB CONSTRUCTION AND EXISTING DUCT FOR REUSE. REMOVE DENTS, SAND AND PAINT TO MATCH PRE-FINISHED WEATHERED COPPER COLOR PRIOR TO REINSTALL.
- 18 NEW PRE-FINISHED METAL CLADDING (WEATHERED COPPER) OVER NEW GEL AND STICK MEMBRANE. REMOVE EXISTING CLADDING AND REUSE. COORDINATE WITH STEP 19 TO PROMOTE WATER SHED AWAY FROM BLDG. ENVELOPE. COORDINATE WITH STEP 19 FLASHING INSTALL TO PROMOTE WATER SHED AWAY FROM BLDG. ENVELOPE. SEE DET 7/A-5 AT EXISTING ROOF / BRICK WALL INTERFACE. PROVIDE NEW METAL FLASHING IN REGLET. REMOVE EXISTING COPPER FLASHING. COORDINATE WITH STEP 19.
- 19 NEW PRE-FINISHED SPLASH DIVERTER AT VALLEY INTERSECTION W/ NEW EAVESSTROUGH. AT OLD ROOF PENETRATION LOCATION, MILL HOLE W/ NEW SHEATHING PATCH WATCHING EXIST ADJACENT SHEATHING THICKNESS PRIOR TO APPLICATION OF NEW UNDERLAYMENT. REINSTALL EXISTING SENSOR IN PREVIOUS EXIST LOCATION. COORDINATE W/ NEW WORK ADJACENT TO SIDEWALK ENTRY POINTS. SEE DET. 15/A-6.
- 20 AT EXISTING CONDUIT / REFRIGERATION LINE PENETRATIONS THROUGH NEW SOFFIT, HOLE IN SOFFIT IS TO BE FINISHED OUT. DO NOT LEAVE BARK CUT EDGE OF SOFFIT.
- 21 NEW REPLACEMENT CAP MATCHING EXIST. DIMENSIONS, EXIST. MATERIAL AND NEW COLOR.

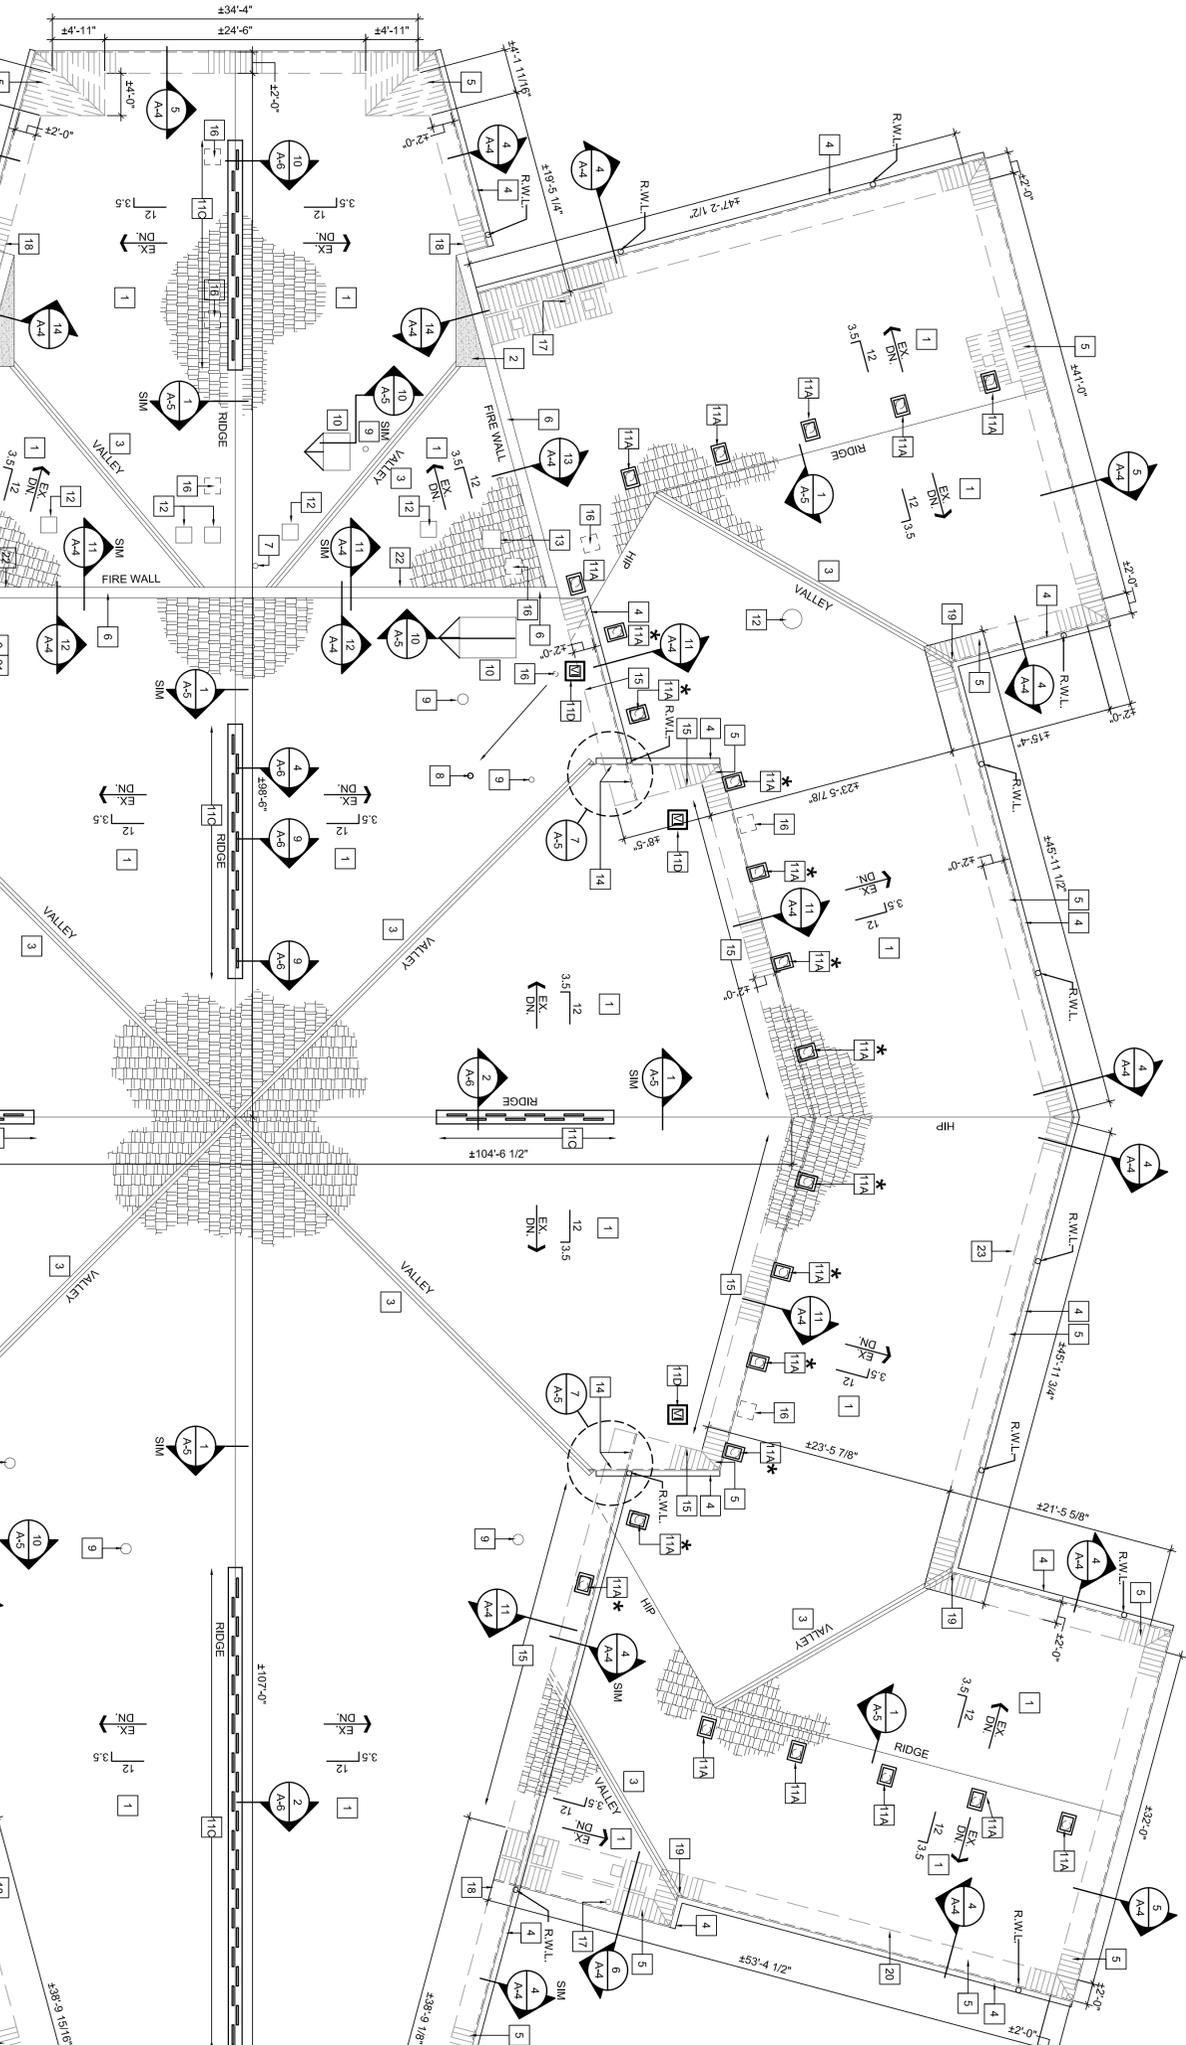

2 SHED - NEW

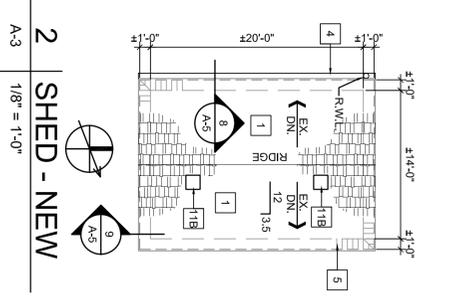

1 ROOF PLAN - NEW

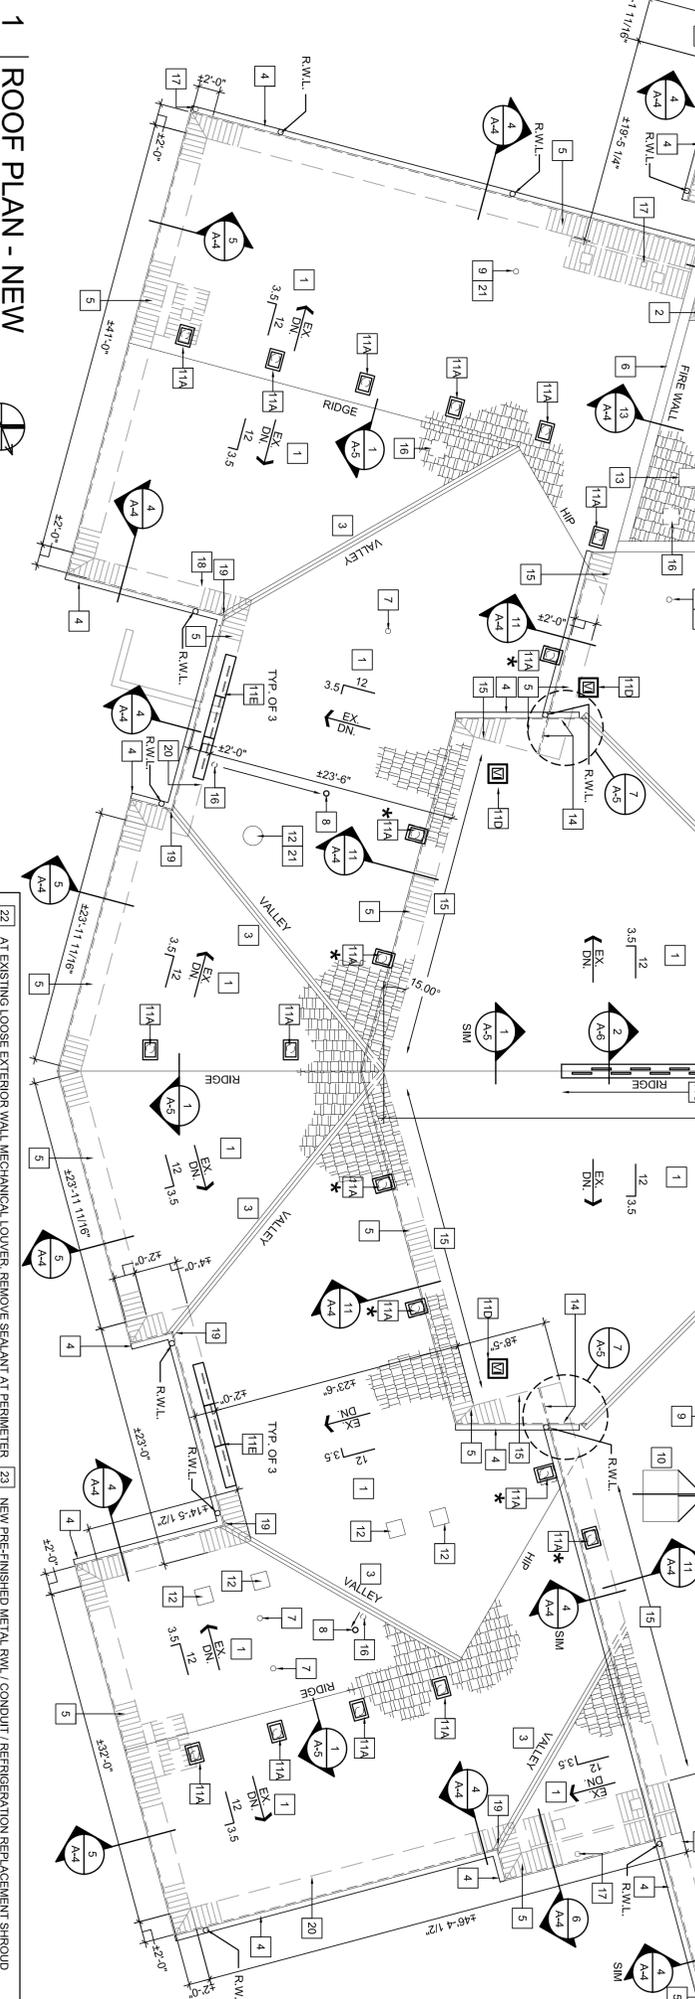

A-3
1/8" = 1'-0"

- 22 AT EXISTING LOOSE EXTERIOR WALL MECHANICAL LOUVER, REMOVE SEALANT AT PERIMETER AND WALL ANCHORS. PROVIDE NEW PERIMETER SEALANT AT MASONRY / LOUVER INTERFACE IN A NEAT WORKMANLIKE MANNER CW NEW 1/4" DIA. X 3 1/4" MASONRY SCREW ANCHORS. FOUR GASKETED WASHERS (SEE GENERAL NOTE 22). AT LARGE LOUVER LOCATION PROVIDE FOUR ANCHORS. AT SMALL LOUVER LOCATION, PROVIDE TWO ANCHORS.
- 23 NEW PRE-FINISHED METAL CONDUIT / REFRIGERATION REPLACEMENT SHROUD (WEATHERED COPPER) TO ACCEPT LARGER R/W DIMENSION AND EXIST. ADJACENT ITEMS VERIFY NEW SIZE REQUIRED ON SITE AND PROVIDE NEW 1/4" DIA. X 1 1/4" MASONRY SCREW ANCHORS CW GASKETED WASHER (SEE GENERAL NOTE 23) TO ATTACH TO WALL.

PROJECT FOR:
THE CHURCH OF JESUS CHRIST OF LATTER-DAY SAINTS

PROJECT NAME:
VICTORIA 2, 3 ROOF
VICTORIA BRITISH COLUMBIA STAKE

PROJECT ADDRESS:
1000 MAIN STREET
VICTORIA, BC V8V 2E8

PROJECT DESCRIPTION:
ROOF RESTORATION

PROJECT DESIGNER:
516-5162-10-0101

WORK ORDER NO.:
516-5169

PROPERTY NO.:
516-5169

PROJECT TYPE:
RESTORATION

DATE ISSUED: JUNE 2021

REVIEWER:
EZH

DRAWING NO.:
A-3

SCALE:
1/8" = 1'-0"

PROJECT NO.:
A-3



VICTORIA 2, 3 ROOF

VICTORIA BRITISH COLUMBIA STAKE

701 MANN AVENUE
VICTORIA, BC, V8Z 6E7

ROOF RESTORATION

THE CHURCH OF
JESUS CHRIST
OF LATTER-DAY SAINTS

BID SET

JUNE 2021

FACTION
ARCHITECTURE
1919 10th Avenue S.W.
Calgary, Alberta,
T3C 0K3
(403) 523-7943

DRAWING LIST	
PAGE NO.	DRAWING TITLE
1	ACS
2	COVER SHEET AND DRAWING LIST
3	VENTILATION PLAN, LEGEND AND GENERAL NOTES
4	ROOF PLAN - DEMOLITION
5	ROOF PLAN - NEW CONSTRUCTION
6	DETAILS
7	DETAILS

NOTE: CONTRACTOR AND TRADES TO REFER TO ENTIRE SET OF DRAWINGS AND SPECIFICATIONS FOR SCOPE OF WORK. DUE TO RENOVATION, NOTES AND DETAILS ARE NOTED THROUGHOUT THE SET.

FACTION ARCHITECTURE INC. FILE NUMBER: 21104
PROJECT NUMBER: 515-5169-2101-0101

SET NUMBER