

Healthcare . Commercial . Residential . Interior Design

TENDER ADDENDUM

Project: UHNBC Fluoroscopy Replacement -

Phase 2 - General Fluoro

University Hospital of Northern British

Columbia

1475 Edmonton Street,

Prince George, BC V2M 1S2

To: **All Bidders**

Tender Addendum #:

DCTYA Project #: 2009

NHA Project #: N662150007

Issued By: **Douglas Cheung**

Issue Date: July 26, 2021

Copies To: Leah Joseph / Northern Health Authority

The following information supplements and/or supersedes the "Issued for Tender" drawings issued for the above project dated June 4, 2021.

This Addendum forms part of the contract documents and is to be read, interpreted, and co-ordinated with all other parts. The cost of all contained herein is to be included in the contract sum. The following revisions supersede the information contained in the original drawings and specifications issued for the above-named project to the extent referenced and shall become part thereof.

> **DWGS OR PAGES ATTACHED**

05

ITEM: DESCRIPTIONS

1. Architectural:

1.1.

The additional scope of work has been incorporated into Phase 2A and includes (1) the demolition/renovation of part of the existing X-Ray control room so that it meets new DAP requirements; (2) the minor demolition/renovation of the existing Rad Office to make room for more storage in the corridor; and (3) the demolition/renovation of part of the existing reception area to make way for a new room for the relocated Porters.

> The following Architectural Drawings (Issued for Addendum 5, dated July 26, 2021) have been added and/or revised to include additional scope of work.

A1.01 - Location Plan & General Notes

Revision: Key Plan, Location Plan, Drawing List, and Project Infor & Analysis

The following drawings have been divided into an A & B drawing (A drawings represent Phase 2A scope and B drawings include Phase 2B/C scope).

A2.01 - Level 1 - Demolition Plan Revision: Demolition Key Notes A2.02 - Level 1 - Framing Plan

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Revision: Construction Key Notes

A2.03 - Level 1 - Finishes & Fixture Plan Revision: Millwork Legend has been added.

A2.04 - Level 1 - Furniture & Equipment Plan

A3.01 - Level 1 - Demolition RCP

A3.02 - Level 1 - RCP

Revision: Ceiling Construction Notes

A5.02 - Door & Window Schedules

Revision: Door & Frame Schedule

A5.03 - Room, Finishes & Fixtures Schedules

Revision: Finishes & Fixture Schedule and Room Finish Schedule

A6.03 - Millwork Plans & Elevations

Revision: Millworks 8, 9, 10 have been added.

A6.04 - Millwork Plans & Elevations

Revision: Millworks 11 has been added.

A6.05 - Millwork Sections


Revision: Drawing # has been revised from A6.04 to A6.05 due to the addition of millwork in the plans & elevations drawings.

- 1.2. See attached Medical Storage Cabinet quote prepared by InnerSpace, dated July 20, 2021. Contractor to supply and install. Please note that this quote will supersede the instruction to provide a cash allowance of \$15,000 in Tender Addendum 1, item 1.1.
- 2. Structural:
- 2.1. See attached Structural Addendum 1 for details.
- 3. Mechanical:
- 3.1. See attached Mechanical Addendum 2 for details.
- 4. Electrical:
- 4.1. See attached Electrical Dwg A2.03 for additional scope.

Attachments:

- Dwg A1.01 Location Plan & General Notes
- b. Dwg A2.01A – Level 1 – Demolition Plan
- Dwg A2.01B Level 1 Demolition Plan C.
- Dwg A2.02A Level 1 Framing Plan d.
- Dwg A2.02B Level 1 Framing Plan ρ
- Dwg A2.03A Level 1 Finishes & Fixture Plan f.
- Dwg A2.03B Level 1 Finishes & Fixture Plan q.
- Dwg A2.04A Level 1 Furniture & Equipment Plan h.
- i. Dwg A2.04B – Level 1 – Furniture & Equipment Plan
- Dwg A3.01A Level 1 Demolition RCP j.

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k.	Dwg A3.01B – Level 1 – Demolition RCP	
I.	Dwg A3.02A – Level 1 – RCP	
m.	Dwg A3.02B – Level 1 – RCP	
n.	Dwg A5.02 – Door & Window Schedules	
Ο.	Dwg A5.03 – Room, Finishes & Fixtures Schedules	
p.	Dwg A6.03 – Millwork Plans & Elevations	
q.	Dwg A6.04 – Millwork Plans & Elevations	
r.	Dwg A6.05 – Millwork Sections	
S.	InnerSpace – Medical Storage Cabinet quote, dated July 20, 2021	2 pages
t.	Structural Addendum 1 (Dwg S26 – Control Room, Rad Office and Porter Room)	1 drawing
u.	Mechanical Addendum 2	1 page & 4
V.	Electrical Dwg E2.03 – Additional Scope	drawings 1 drawing

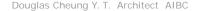END




UHNBC FLUOROSCOPY REPLACEMENT

PHASE 2 - GENERAL FLUORO

1475 EDMONTON STREET, PRINCE GEORGE, BC V2M 1S2

ISSUED FOR TENDER JUNE 4, 2021

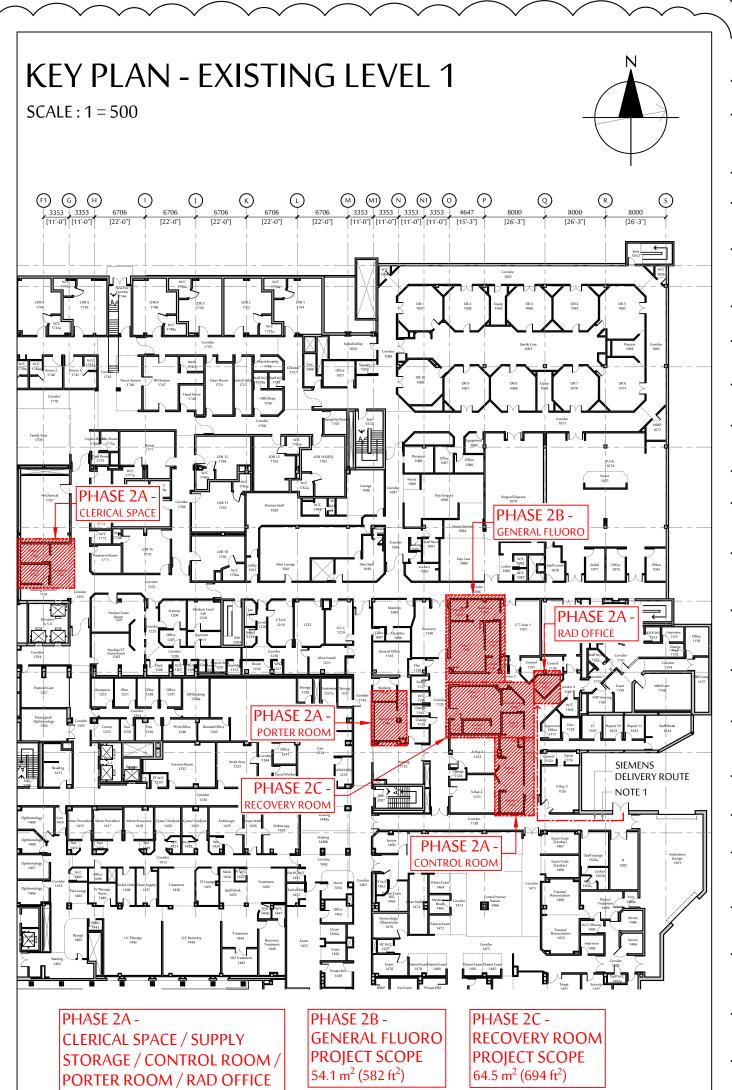

LOCATION PLAN SEEKEY PLAN UNIVERSITY HOSPITAL OF NORTHERN BRITISH COLUMBIA **EDMONTON STREET**

INFECTION CONTROL REQUIREMENTS

- FOR ALL CONSTRUCTION WORK WITHIN THE HOSPITAL, CONTRACTORS MUST FOLLOW INFECTION CONTROL PROCEDURES AS REQUIRED BY:
- . CSA STANDARDS Z317.13.12 "FUNDAMENTALS FOR INFECTION CONTROL DURING CONSTRUCTION, RENOVATION AND MAINTENANCE OF HEALTH CARE FACILITIES"
- b. NORTHERN HEALTH AUTHORITY CLINICAL PRACTICE STANDARD "INFECTION CONTROL DURING CONSTRUCTION, RENOVATIONS, AND MAINTENANCE OF HEALTH CARE FACILITIES"
- THIS PROJECT IS CLASSIFIED AS PHASE 2A - CLERICAL SPACE / RAD OFFICE / PORTER ROOM POPULATION RISK GROUP = 1 (OFFICE AREA - NON-CLINICAL)
- CONSTRUCTION ACTIVITY TYPES = **D** GUIDELINES FOR INFECTION CONTROL MEASURES = CLASS III / IV PHASE 2A/2B/2C - X-RAY CONTROL ROOM / GEN FLUORO / RECOVERY ROOM POPULATION RISK GROUP = 3 (DIAGNOSTIC IMAGING)
- CONSTRUCTION ACTIVITY TYPES = **D** GUIDELINES FOR INFECTION CONTROL MEASURES = CLASS IV
- WITH THE HOSPITAL TO REVIEW AND OBTAIN APPROVAL FOR THE PROPOSED INFECTION CONTROL MEASURES.
- MEASURES CONSTRUCTION REPORT" TO NORTHERN HEALTH AUTHORITY FOR APPROVAL CONTRACTORS TO OBSERVE THE FOLLOWING INFECTION CONTROL PRECAUTIONS FOR WORKING AT THE

). CONTRACTOR TO COORDINATE WITH NHA AND THE HOSPITAL AND SUBMIT A "RISK REDUCTION

- DISCHARGE OPENINGS OF ROOFTOP EXHAUST DUCTS. INFECTION CONTROL REQUIRES THAT WORKERS MUST BE MADE AWARE OF THE FACT THAT HOSPITAL EXHAUST DUCTS MAY CARRY DUST AND SPORE PARTICLES, HOWEVER, NOT ACTIVE TB. DUST AND SPORES, RESIDING IN THESE DUCTS, MAY BE DISCHARGED TO THE EXTERIOR WITH THE AIR MASS CREATED WITHIN THESE DUCTS
- . ALTHOUGH THE LEVEL OF RISK FOR POTENTIAL CONTAMINATION IS LOW, IT IS ADVISABLE THAT CONSTRUCTION WORKER'S, ESPECIALLY THOSE WHO ARE SENSITIVE TO RESPIRATORY ILLNESSES, WEAR APPROPRIATE DUST MASKS CAPABLE OF FILTERING FINE PARTICULATES.

GUIDANCE TO CONSTRUCTION SITES **OPERATING DURING COVID-19**

AS THE CHALLENGES CAUSED BY THE CORONAVIRUS OUTBREAK CONTINUE TO SHIFT, THE B.C. GOVERNMENT AND B.C.'S PROVINCIAL HEALTH OFFICER, DR. BONNIE HENRY, ARE TAKING UNPRECEDENTED MEASURES TO SLOW THE TRANSMISSION OF

RECENTLY, DR. HENRY ISSUED AN ORDER UNDER THE BC'S PUBLIC HEALTH ACT PROHIBITING THE GATHERING OF PEOPLE IN EXCESS OF 50 PEOPLE AT A PLACE OF WHICH YOU ARE THE OWNER. OCCUPIER OR OPERATOR, OR FOR WHICH YOU ARE OTHERWISE RESPONSIBLE. WE UNDERSTAND THAT EMPLOYERS IN THE CONSTRUCTION INDUSTRY ARE ASKING FOR CLARITY ABOUT WHAT THIS MEANS FOR THEM

WHILE THIS ORDER DOES NOT APPLY TO CONSTRUCTION SITES AS A WHOLE, WE ARE DIRECTING EMPLOYERS TO TAKE AL NECESSARY PRECAUTIONS TO MINIMIZE THE RISKS OF COVID 19 TRANSMISSION AND ILLNESS TO YOU AND YOUR EMPLOYEES.

- THERE SHOULD BE NO MORE THAN 50 PEOPLE IN THE SAME SPACE IN ANY CIRCUMSTANCES WHERE POSSIBLE EMPLOYEES SHOULD MAINTAIN A DISTANCE OF 2 METRES APART FROM EACH OTHER POST SIGNAGE THAT LIMITS THE NUMBER OF OCCUPANTS IN ANY ELEVATOR TO FOUR PEOPLE AT A TIME.
- REDUCE IN-PERSON MEETINGS AND OTHER GATHERINGS AND HOLD SITE MEETINGS IN OPEN SPACES OR OUTSIDE INCREASE THE NUMBER OF HANDWASHING STATIONS AND POST SIGNAGE THAT IDENTIFIES THEIR LOCATION. MAINTAIN A LIST OF EMPLOYEES THAT ARE CURRENTLY WORKING ON SITES AND UPDATE THIS LIST DAILY. ALL COMMON AREAS AND SURFACES SHOULD BE CLEANED AT THE END OF EACH DAY, EXAMPLES INCLUDE
- WASHROOMS, SHARED OFFICES, COMMON TABLES, DESKS, LIGHT SWITCHES, AND DOOR HANDLES. ANYONE WITH COVID-19 LIKE SYMPTOMS SUCH AS SORE THROAT, FEVER, SNEEZING, OR COUGHING MUST SELF-ISOLATE AT HOME FOR 14 DAYS.

SECTION 4.85 OF THE OCCUPATIONAL HEALTH AND SAFETY REGULATION DOES PROVIDE FOR A MINIMUM STANDARD AROUND THE PROVISION OF WASHROOMS AND HAND WASHING FACILITIES. WHERE PLUMBED FACILITIES ARE IMPRACTICABLE, EMPLOYERS MUST PROVIDE ACCESS TO PORTABLE WASHROOM AND HAND-WASHING FACILITIES, THOSE FACILITIES MUST BE MAINTAINED IN GOOD WORKING ORDER, AND MUST BE PROVIDED WITH THE SUPPLIES NECESSARY FOR THEIR USE. EMPLOYERS SHOULD REASSESS THEIR WORK ENVIRONMENT EVERY DAY AND KEEP UPDATED WITH THE INFORMATION POSTED ON THE PROVINCE'S WEBSITE:

https://www2.gov.bc.ca/gov/content/safety/emergencypreparedness-response-recovery/covid-19-provincial-support

DRAWING LIST ARCHITECTURAL

PROJECT SCOPE

 $89.3 \text{ m}^2 (961 \text{ ft}^2)$

- A1.01 LOCATION PLAN & GENERAL NOTES
- A2.01A PHASE 2A DEMOLITION PLAN A5.04 TYPICAL DETAILS A2.01B PHASE 2B/C - DEMOLITION PLAN A2.02A PHASE 2A - FRAMING PLAN
- A2.02B PHASE 2B/C FRAMING PLAN A2.03A PHASE 2A - FINISHES & FIXT. PLAN A2.03B PHASE 2B/C - FINISHES & FIXT. PLAN
- A2.04A PHASE 2A FURNITURE & EQUIP. PLAN A2.04B PHASE 2B/C - FURNITURE & EQUIP. PLAN A2.05 LEVEL 1 - SCOPE OF WORK
- A2.06 LEVEL 0 SCOPE OF WORK A2.07 ROOF PLAN A3.01A PHASE 2A - DEMOLITION RCP A3.01B PHASE 2B/C - DEMOLITION RCP

A3.02A PHASE 2A - RCP

- A3.02B PHASE 2B/C RCP A4.01 SECTIONS
- S21 GENERAL NOTES & KEY PLAN A4.02 INTERIOR ELEVATIONS S22 TYPICAL DETAILS A5.01 WALL SCHEDULES S23 LEVEL 1 RCP & GEN FLUORO & RECOVERY A5.02 DOOR & WINDOW SCHEDULES ROOM
- A5.03 ROOM, FINISHES & FIXT. SCHED. A5.05 FURNITURE & EQUIP. SCHEDULES S25 SECTIONS & DETAILS A6.01 MILLWORK PLANS & ELEV.
- A6.02 MILLWORK PLANS & ELEV. (CONT) A6.03 MILLWORK PLANS & ELEV. (CONT) A6.04 MILLWORK PLANS & ELEV. (CONT) A6.05 MILLWORK SECTIONS
- A7.01 SPECIFICATIONS GENERAL CONDITIONS A7.02 SPECIFICATIONS - MATERIALS &

A7.03 SPECIFICATIONS - MATERIALS &

FINISHES (CONT.)

M1.100 LEVEL 0 EXIST. SANITARY DEMO PLAN LEVEL 1 EXIST. PLUMBING DEMO PLAN M5.201 LEVEL 1 EXIST. MEDIC. GAS DEMO PLAN M5.202 SPECIFICATIONS M1.102 LEVEL 1 EXIST. MECH. DEMO PLAN LEVEL 1 EXISTING MECHANICAL PLAN

STRUCTURAL

- M1.300
- DEMO PLAN LEVEL 1 EXISTING FIRE SUPPRESSION E1.01 M2.100 LEVEL O SANITARY PLAN LEVEL 1 PLUMBING PLAN M2.101 S24 LEVEL 1 RCP CLERICAL WORK SPACE & ROOF LEVEL 1 MEDICAL GAS PLAN M2.200 LEVEL 1 MECHANICAL PLAN M2.201 LEVEL 1 MECHANICAL PLAN S26 CONTROL ROOM, RAD OFFICE AND PORTER ROOF MECHANICAL PLAN M2.202 LEVEL 1 FIRE SUPPRESSION PLAN M2.300
 - M2.301 LEVEL 1 FIRE SUPPRESSION PLAN M4.200 DFTAILS M4.201 DETAILS **SCHEDULES** M5.200 **SPECIFICATIONS SPECIFICATIONS**
- LEVEL 1 EXIST. FIRE SUPPRESSION ELECTRICAL **ELECTRICAL DEMOLITION** LEVEL 1 CONSTRUCTION PLAN E2.02 LEVEL 1 RCP LEVEL 1 ADDITIONAL SCOPE E2.03 **ELECTRICAL DETAILS** E3.01

E3.02

REFERENCE DRAWINGS SIEMENS AXIOM ARTIS ZEE MP INSTALL DWGS (4 PAGES)

GULDMANN PATIENT LIFT DWGS (6 PAGES)

ELECTRICAL SPEC'S - KEY PLANS

NORTHERN HEALTH AUTHORITY SUITE 600 - 299 VICTORIA ST PRINCE GEORGE, BC V2L 5B8

PROJECT TEAM

ARCHITECTURAL CONSULTANT: **DCYT ARCHITECTURE**

E - dc@dcytarchitecture.ca

PROJECT INFO & CODE ANALYSIS

LOT 4 DL343, PLAN 34806

DIVISION A, PARTS 1, 2 AND 3

DIVISION B, PARTS 1, 7, 8 AND 10

DIVISION B, PARTS 3, 4, 5 AND 6

DIVISION C, PARTS 1 & 2

PROPOSED - NO CHANGE

EXISTING - NOT APPLICABLE

TREATMENT

PROPOSED - NOT APPLICABLE

CLERICAL SPACE

PHASE 2B OCCUPANT LOAD

PHASE 2C OCCUPANT LOAD

PROPOSED - NO CHANGE

EXISTING - NO CHANGE

EXISTING - NO CHANGE

MIN 2 EXCEPT 1 REQUIRED IF:

SPRINKLERED THROUGHOUT

FLOOR AREA < 200 SM (2,153 SF)

TRAVEL DISTANCE < 25 M (82 FT)

REQUIRED

NOT APPLICABLE

MIN 2 REQUIRED

REQUIREMENTS

TO BE VERIFIED

REQUIREMENTS

TO BE VERIFIED

NOT APPLICABLE

MIN 800mm (31.5") CLEAR

MIN 1050mm (42") CLEAR

TO MOVE PATIENT BEDS

¹ DIAGONAL OF FLOOR AREA BUT

NOT LESS THAN 9 M (29.5 FT)

ROOF - NO RATING REQUIRED

EXISTING BUILDING HEIGHT: 5-STOREY

MAX BUILDING AREA ALLOWED: ANY AREA

EXISTING - SPRINKLERED THROUGHOUT

EXISTING - 2 HOUR F.R.R. CONC. SLAB

EXISTING - CONC. SLAB CONSTRUCTION

EXISTING BUILDING AREA: 13,503 SM (145,350 SF)

REQUIRED - NONCOMBUSTIBLE CONSTRUCTION

EXISTING - NONCOMBUSTIBLE CONSTRUCTION

PROPOSED - NONCOMBUSTIBLE CONSTRUCTION

EXISTING - 2 HOUR F.R.R. CONC. CONSTRUCTION

PHASE 2A: 89.3 SM

PHASE 2B: 54.1 SM PHASE 2C: 64.5 SM

TOTAL: 207.9 SM

LEGAL DESCRIPTION: PROJECT AREA:

CODE ANALYSIS:

CODE REFERENCE:

CODE APPLICATIONS

MAJOR OCCUPANCIES:

SEPARATION OF MAJOR

OCCUPANCIES:

BUILDING SIZE:

FIRE SUPPRESSION:

CONSTRUCTION TYPE:

FIRE RESISTANCE RATING

SEPARATION OF SUITES

FROM ROOM OR SUITES

DISTANCE BETWEEN

EGRESS DOORWAYS:

NO. OF EXITS FROM

DISTANCE BETWEEN EXITS:

TRAVEL DISTANCE TO EXITS: MAX 45 M (148 FT)

EXIT WIDTH FOR DOORWAYS: MIN 6.1mm X OCCUP. LOAD

CORRIDOR (AGGREGATE) MIN 1100mm (43.3") WIDE

DOORWAY (AGGREGATE) MIN 800mm (31.50") WIDE

FLOOR AREAS

FIRE SEPARATION

ABOVE:

OF EXITS FROM FLOOR

WASHROOM PROVISION

HANDICAPPED PROVISION

ACCESSIBLE WASHROOM

PARKING PROVISION:

EGRESS DOORWAY WIDTH:

PUBLIC CORRIDOR

SEPARATIONS:

OCCUPANT LOAD:

1475 EDMONTON STREET, PRINCE GEORGE, BC V2M 1S2

EXISTING - GROUP B, DIVISION 2 (TREATMENT - HOSPITAL)

GROUP B, DIVISION 2, ANY HEIGHT, ANY AREA, SPRINKLERED

REQUIRED - BUILDING TO BE SPRINKLERED THROUGHOUT

REQUIRED (FLOOR) - 2 HOUR F.R.R. NONCOMBUSTIBLE CONST.

COLUMN & LOADBEARING WALL - SAME AS SUPPORTED ASSEMBLY REQUIRED

PROVIDED

2 (1 REQUIRED)

YES - PHASE 2A: 35.9 SM

YES - PHASE 2B: 54.1 SM

YES - PHASE 2C: 64.5 SM

YES - PHASE 2B: 10.5 SM

YES - PHASE 2C: 7.5 SM

MIN 1118 mm (44") WIDE

EXISTING - NO CHANGE

NOT APPLICABLE

MIN 2 HOUR

MIN 2 HR (AS REQ'D UNDER 3.2.2) EXISTING - NO CHANGE

NOT APPLICABLE

NOT APPLICABLE

YES - PHASE 2A: 6.5 SM

BRITISH COLUMBIA BUILDING CODE 2018 (INCLUDING LATEST AMENDMENTS)

= 10.0 SM PER PERSON

 $= 35.9 \, \text{SM} / 10.0 \, \text{SM} = 4$

 $= 54.1 \, \text{SM} / 10.0 \, \text{SM} = 5$

 $= 64.5 \, \text{SM} / 10.0 \, \text{SM} = 6$

PHASE 2A OCCUPANT LOAD

1.3.2.1

1.3.3.1

1.3.3.2

1.3.4.1

3.1.2.1

3.1.3.1

3.1.17.1

3.2.2.38

3.2.2.38

3.2.2.38

3.3.1.1

3.3.1.4

3.3.1.5

3.3.1.5(2)

3.3.1.13

3.3.3.4(2)

3.4.2.1

3.4.2.3

3.4.2.5 (1)c

3.4.3.2

3.4.3.2 (1)a

3.7.2.2 (9)

3.8.2.3(2) &

3.8.2.26

3022 CAMBIE STREET VANCOUVER, BC V5Z 2V9 T - 778 233 9001

C. Y. LOH ASSOCIATES 1863 POWELL ST VANCOUVER, BC V5L 1H8 T - 604 254 0868

E - kmarcakis@cyla.ca

STRUCTURAL CONSULTANT: MECHANICAL CONSULTANT 312 MAIN ST

IMPACT ENGINEERING VANCOUVER, BC V6A 2T2 T - 604 992 5920 T - 250 562 0551 E - steve@nrsengineering.ca E - jle@impacteng.ca

FIRE SERVICES

ELECTRICAL CONSULTANT: NRS ENGINEERING SUITE 212 - 556 N NECHAKO ST PRINCE GEORGE, BC V2K 1A1

IMAGING EQUIPMENT: SIEMENS HEALTHCARE LTD 1577 NORTH SERVICE RD E OAKVILLE, ON L6H 0H6

E - lee.boon@siemens-healthineers.ca

T - 236 984 5339

ARCHITECT:



WWW.DCYTARCHITECTURE.CA

WORK OUTSIDE PROJECT AREA **GENERAL NOTES**

- 1. OBTAIN AUTHORIZATION FROM **HOSPITAL** TO PERFORM WORK OUTSIDE PROJECT AREA PRIOR TO COMMENCEMENT OF WORK
- 2. ALL WORK OUTSIDE PROJECT AREA AND HOARDING
- AREA TO BE PERFORMED AFTER REGULAR HOURS.
- UNLESS AUTHORIZED BY **HOSPITAL** OTHERWISE
- 3. SEE M&E DWGS FOR M&E SCOPE OF WORK
- 4. REMOVE AND REINSTALL CLNG TILES AND GRID AS REQ'D TO PERFORM M&E WORK.
- 5. REPLACE CLNG TILES WITH NEW TO MATCH EX IF DAMAGED DURING CONSTRUCTION.
- 6. PERFORM SCANNING OF CONC SLAB TO VERIFY EXISTING M&E SERVICES & REBAR INSIDE SLAB BEFORE CORING OF SLAB
- 7. PROVIDE FIRE STOPPING TO MAINTAIN FIRE SEPARATION REQ'D FOR ALL NEW FLOOR AND WALL
- 8. REMOVE, REPAIR & REFINISH WALL AND FLOOR IF
- REQ'D FOR M&E WORK 9. REMOVE AND REPAIR EX UNDERSLAB THERMAL
- INSULATION IF REQ'D FOR INSTALLATION OF NEW M&E SERVICES - SEE M&E DWGS FOR EXTENT OF WORK 10. FOR M&E WORK EXTENDING BELOW THE PROJECT AREA, CONTRACTOR TO REMOVE, REPAIR & REFINISH
- EXISTING CEILING AS REQ'D. 11. PROTECT EXISTING FLOOR FINISHES ALONG PATH OF TRAVEL FROM ELEVATOR LOBBY TO PROJECT AREA.
- NOTE 1-FOR DELIVERY OF GENERAL FLUOROSCOPY **EOUIPMENT:**
- A. CONTRACTOR TO COORDINATE WITH HOSPITAL 72 HOURS IN ADVANCE FOR DELIVERY OF EQUIPMENT.
- B. CONTRACTOR TO MAKE GOOD EXTERIOR AND INTERIOR WALLS, FLOORS AND CEILING, IF DAMAGED DURING EQUIPMENT DELIVERY.
- C. CONTRACTOR TO PROVIDE PROTECTIVE COVERING. FOR WALL, FLOOR AND CEILING AS REQUIRED BY HOSPITAL ALONG THE DELIVERY ROUTE.

ABBREVIATIONS

GENERAL NOTES

CONTRACT DOCUMENTS.

THE CONSTRUCTION PERIOD.

INSTALLATION IF SPECIFIED.

DURING COVID-19"

UP OF ELECTRICAL APPLIANCES.

1.1 DO NOT SCALE THESE DRAWINGS. SEEK ARCHITECT FOR CLARIFICATION ON ANY MISSING DIMENSIONS

IMMEDIATELY TO THE ARCHITECT PRIOR TO COMMENCEMENT OF WORK.

REPORTED TO THE ARCHITECT BEFORE WORK IN THAT AREA CAN COMMENCE.

INTERIOR PARTITIONS, UNLESS NOTED OTHERWISE.

NOTED AS EXISTING ON CONSTRUCTION DOCUMENTS.

SHALL ANY EXISTING EXIT ROUTE BE OBSTRUCTED.

SUCH AFTER HOUR WORK WILL BE PART OF THIS CONTRACT.

HOURS THROUGH SERVICE CORRIDORS AS PERMITTED BY THE HOSPITAL.

OTHER CODES BY-LAWS, AND REGULATIONS HAVING JURISDICTION.

WORKMANSHIP AS ACCEPTED IN THEIR OWN TRADE OR TRADE ASSOCIATION.

1.2 VERIFY ALL DIMENSIONS AND SITE CONDITIONS ON SITE. ANY DISCREPANCIES FOUND ARE TO BE REPORTED

1.3 ALL DIMENSIONS ARE GIVEN IN METRIC MEASURE EXCEPT NOTED OTHERWISE. FRAME CONSTRUCTION

1.4 ALL DRAWINGS AND NOTES SHALL BE READ IN CONJUNCTION WITH THE SPECIFICATIONS AND DRAWINGS OF

DIMENSIONS ARE FROM THE OUTSIDE FACE OF FINISH OF EXTERIOR WALLS, AND FROM THE FINISHED FACE OF

OTHER CONSULTANTS. ANY DISCREPANCIES, ERRORS OR OMISSIONS IN THE DOCUMENTS SHALL BE

PROJECT AREA IN DASHED LINES DENOTES APPROXIMATE LIMITS FOR THE WORK IN PLAN. WORK IS NOT

NECESSARILY LIMITED TO THE AREA ENCLOSED - ALSO REFER TO M&E DWGS FOR WORK OUTSIDE PROJECT

1.6 ALL WORK SHOWN WITHIN PROJECT AREA IS CONSIDERED AS NEW AND BE INCLUDED IN CONTRACT EXCEPT

1.7 ALL CONSTRUCTION AND INSTALLATION IS TO BE QUOTED AND PERFORMED IN ACCORDANCE WITH THE

1.8 ALL WORK PERFORMED BY TRADES AND SUB-TRADES SHALL MEET THE MINIMUM REQUIREMENTS OF

1.9 ALL MATERIALS, FIXTURES AND EQUIPMENT MUST BE INSTALLED IN ACCORDANCE WITH MANUFACTURERS'

1.10 Contractor to supply all new materials and perform all work to fulfill the intent of the

1.12 NO STRUCTURAL ITEMS TO BE REMOVED, CUT OR ALTERED OTHER THAN THOSE SHOWN ON STRUCTURAL

1.13 CONTRACTOR TO ENSURE ALL CONSTRUCTION AND STORAGE OF MATERIALS AND EQUIPMENT TO BE

1.14 CONTRACTOR TO POST ALL NECESSARY SAFETY AND EXIT SIGNS AT AND AMEND AS REQUIRED TO MAINTAIN

1.15 Contractor to maintain proper means of egress from project area at all times throughou1

.16 CONTRACTOR TO NOTIFY, COORDINATE AND SEEK APPROVAL FROM HOSPITAL & SECURITY DEPT. 72 HOURS

.17 DELIVERY OF MATERIALS AND DISPOSAL OF GARBAGE MUST BE CARRIED OUT IN SEALED BINS AFTER REGULAR

1.18 SUPPLY, DELIVERY AND ASSEMBLY OF FURNITURE AND FIXTURES INDICATED AS BY OWNER ARE NOT PART OF

1.19 $\,$ Supply and delivery of electrical appliances are by owner. Contractor is responsible for hook

THIS CONTRACT. CONTRACTOR IS RESPONSIBLE ONLY FOR COORDINATION OF THE ABOVE, PLUS

1.20 FOLLOW ALL RULES AS RECOMMENDED UNDER "GUIDANCE TO CONSTRUCTION SITES OPERATING

SERVICES AND MEDICAL GASES SHUT OFF. IF SUCH WORK NEEDS TO BE PERFORMED AFTER REGULAR HOURS

AND SO THAT ANY INTERRUPTION OF THE NORMAL OPERATION OF THE SPACES OUTSIDE THE PROJECT AREA,

IN ADVANCE PRIOR TO ANY WORK OUTSIDE PROJECT AREA AS WELL AS ANY MECH, ELEC, PLUMB, FIRE

CONFINED WITHIN THE PROJECT AREA THROUGHOUT CONSTRUCTION PERIOD. IN NO CIRCUMSTANCES

A SAFE ENVIRONMENT WITHIN AND IN THE VICINITY OF THE SITE THROUGHOUT THE CONSTRUCTION PERIOD.

1.11 CONTRACTOR TO PROVIDE ALL NECESSARY COORDINATION AND SUPERVISION OF ALL SUB-TRADES.

CURRENT ISSUE OF THE BRITISH COLUMBIA BUILDING CODE 2018 AND ITS AMENDMENTS, AS WELL AS ALL

GENERAL

)	AT / EACH AT				
/C	AIR CONDITIONER	GA	GAUGE	R/A	RETURN AIR
BHR	ALCOHOL BASE HAND RUB	GB	GRAB BAR	REF	REFERENCE
COUST	ACOUSTICAL	GWB	GYPSUM WALL BOARD	REFL	REFLECTED
DJ	ADJUSTABLE	Н	HIGH	REQ'D	REQUIRED
FF	ABOVE FINISHED FLOOR	HC	HANDICAPPED	RM	ROOM
LUM	ALUMINUM	HD	HAND DRYER	RO	ROUGH OPENING
TC	ACOUSTIC TILE CEILING	HGT	HEIGHT	S/A	SUPPLY AIR
LDG	BUILDING	HM	HOLLOW METAL	SCH	SCHEDULE
LK	BLOCK	HMI	HANDICAPPED MIRROR	SD	SOAP DISPENSER
/S	BOTH SIDES	HORIZ	HORIZONTAL	SIM	SIMILAR
TWN	BETWEEN	HW	HARD WOOD	SND	SANITARY NAPKIN
G	CORNER GUARD	INCL	INCLUDING	SIND	DISPOSAL
Н	CLOTHES HOOK	INSUL	INSULATION	SPEC	SPECIFICATION
L	CENTER LINE	INT	INTERIOR	SS	STAINLESS STEEL
LNG	CEILING	JB	JUNCTION BOX	STL	STEEL
MU	CONCRETE MASONRY UNIT	L	LENGTH	STRUCT	STRUCTURAL
ONC	CONCRETE	LAD	LINEAR AIR DIFFUSER	SUSP	SUSPENDED
ONSTR	CONSTRUCTION	LAM	LAMINATE	T&B	TOP & BOTTOM
ONT	CONTINUOUS	LRA	LINEAR R/A DIFFUSER	T&G	TONGUE & GROO
OORD	COORDINATE	LSA	LINEAR S/A DIFFUSER	THK	THICK
Т	CERAMIC TILE	M&E	MECH & ELEC	TOC	TOP OF CONCRET
EMO	DEMOLITION / DEMOLISH	MIXL		TPD	TOILET PAPER
IA	DIAMETER	N 4 A N II IE	(INCL PLUMB & FS)	IFD	DISPENSER
R	DOOR	MANUF	MANUFACTURER	TYP	TYPICAL
Ν	DOWN	MAX	MAXIMUM	U/C	
WG(S)	Drawing(s)	MECH	MECHANICAL		UNDER COUNTER
/A	EXHAUST AIR	MI	MIRROR	U/S	UNDERSIDE
4	EACH	MTD	MOUNTED	UNO	UNLESS NOTED
_ / ELEV	ELEVATION	MTL	METAL	VCT	OTHERWISE
-ÉC	ELECTRICAL	N NIC	NEW NOT IN CONTRACT	VCT	VINYL COMPOSITI
Q	EQUAL	NTS		VEDT	TILE
(EXIST		NOT TO SCALE	VERT	VERTICAL
ΚP	EXPOSED	NUM/#	NUMBER	VEST	VESTIBULE
ΚT	EXTERIOR	OD	OUTSIDE DIAMETER	VIF	VERIFIED IN FIELD
)	FLOOR DRAIN	PL	PROPERTY LINE	W	WIDE
ON	FOUNDATION	PLAS	PLASTIC	W/	WITH
_	FIRE EXTINGUISHER	PLUMB	PLUMBING	WC	WATER CLOSET
Ν	FINISH	PLYWD	PLYWOOD	WD	WOOD
XT	FIXTURE	PREFIN	PRE-FINISHED	WP	WALL PROTECTION
_R	FLOOR	PTD	PAINTED	WR	WASTE RECEPTACI
)	FILLER PANEL	PTH	PAPER TOWEL HOLDER	WT	WEIGHT
2	FIRE RATED	PTN	PARTITION		

10 TENDER ADDENDUM 5 JULY 26, 2021 RC NOT ISSUED TENDER ADDENDUM JUNE 10, 2021 RC I ISSUED FOR TENDER JUNE 4, 2021 ISSUED FOR 80% CD MAY 21, 2021 RC ISSUED FOR BP SUBMISSION MAY 7, 2021 I NOT ISSUED NOTISSUED NOT ISSUED

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NOT ISSUED

No. REVISION

UHNBC **FLUOROSCOPY REPLACEMENT**


1475 EDMONTON STREET, PRINCE GEORGE BC V2M 1S2


PHASE 2 - GEN FLUORO **LOCATION PLAN & GENERAL NOTES**

AS NOTED OCTOBER 2020 RC


PHASE 2

CHECKED DC JOB No.: DCYT2009

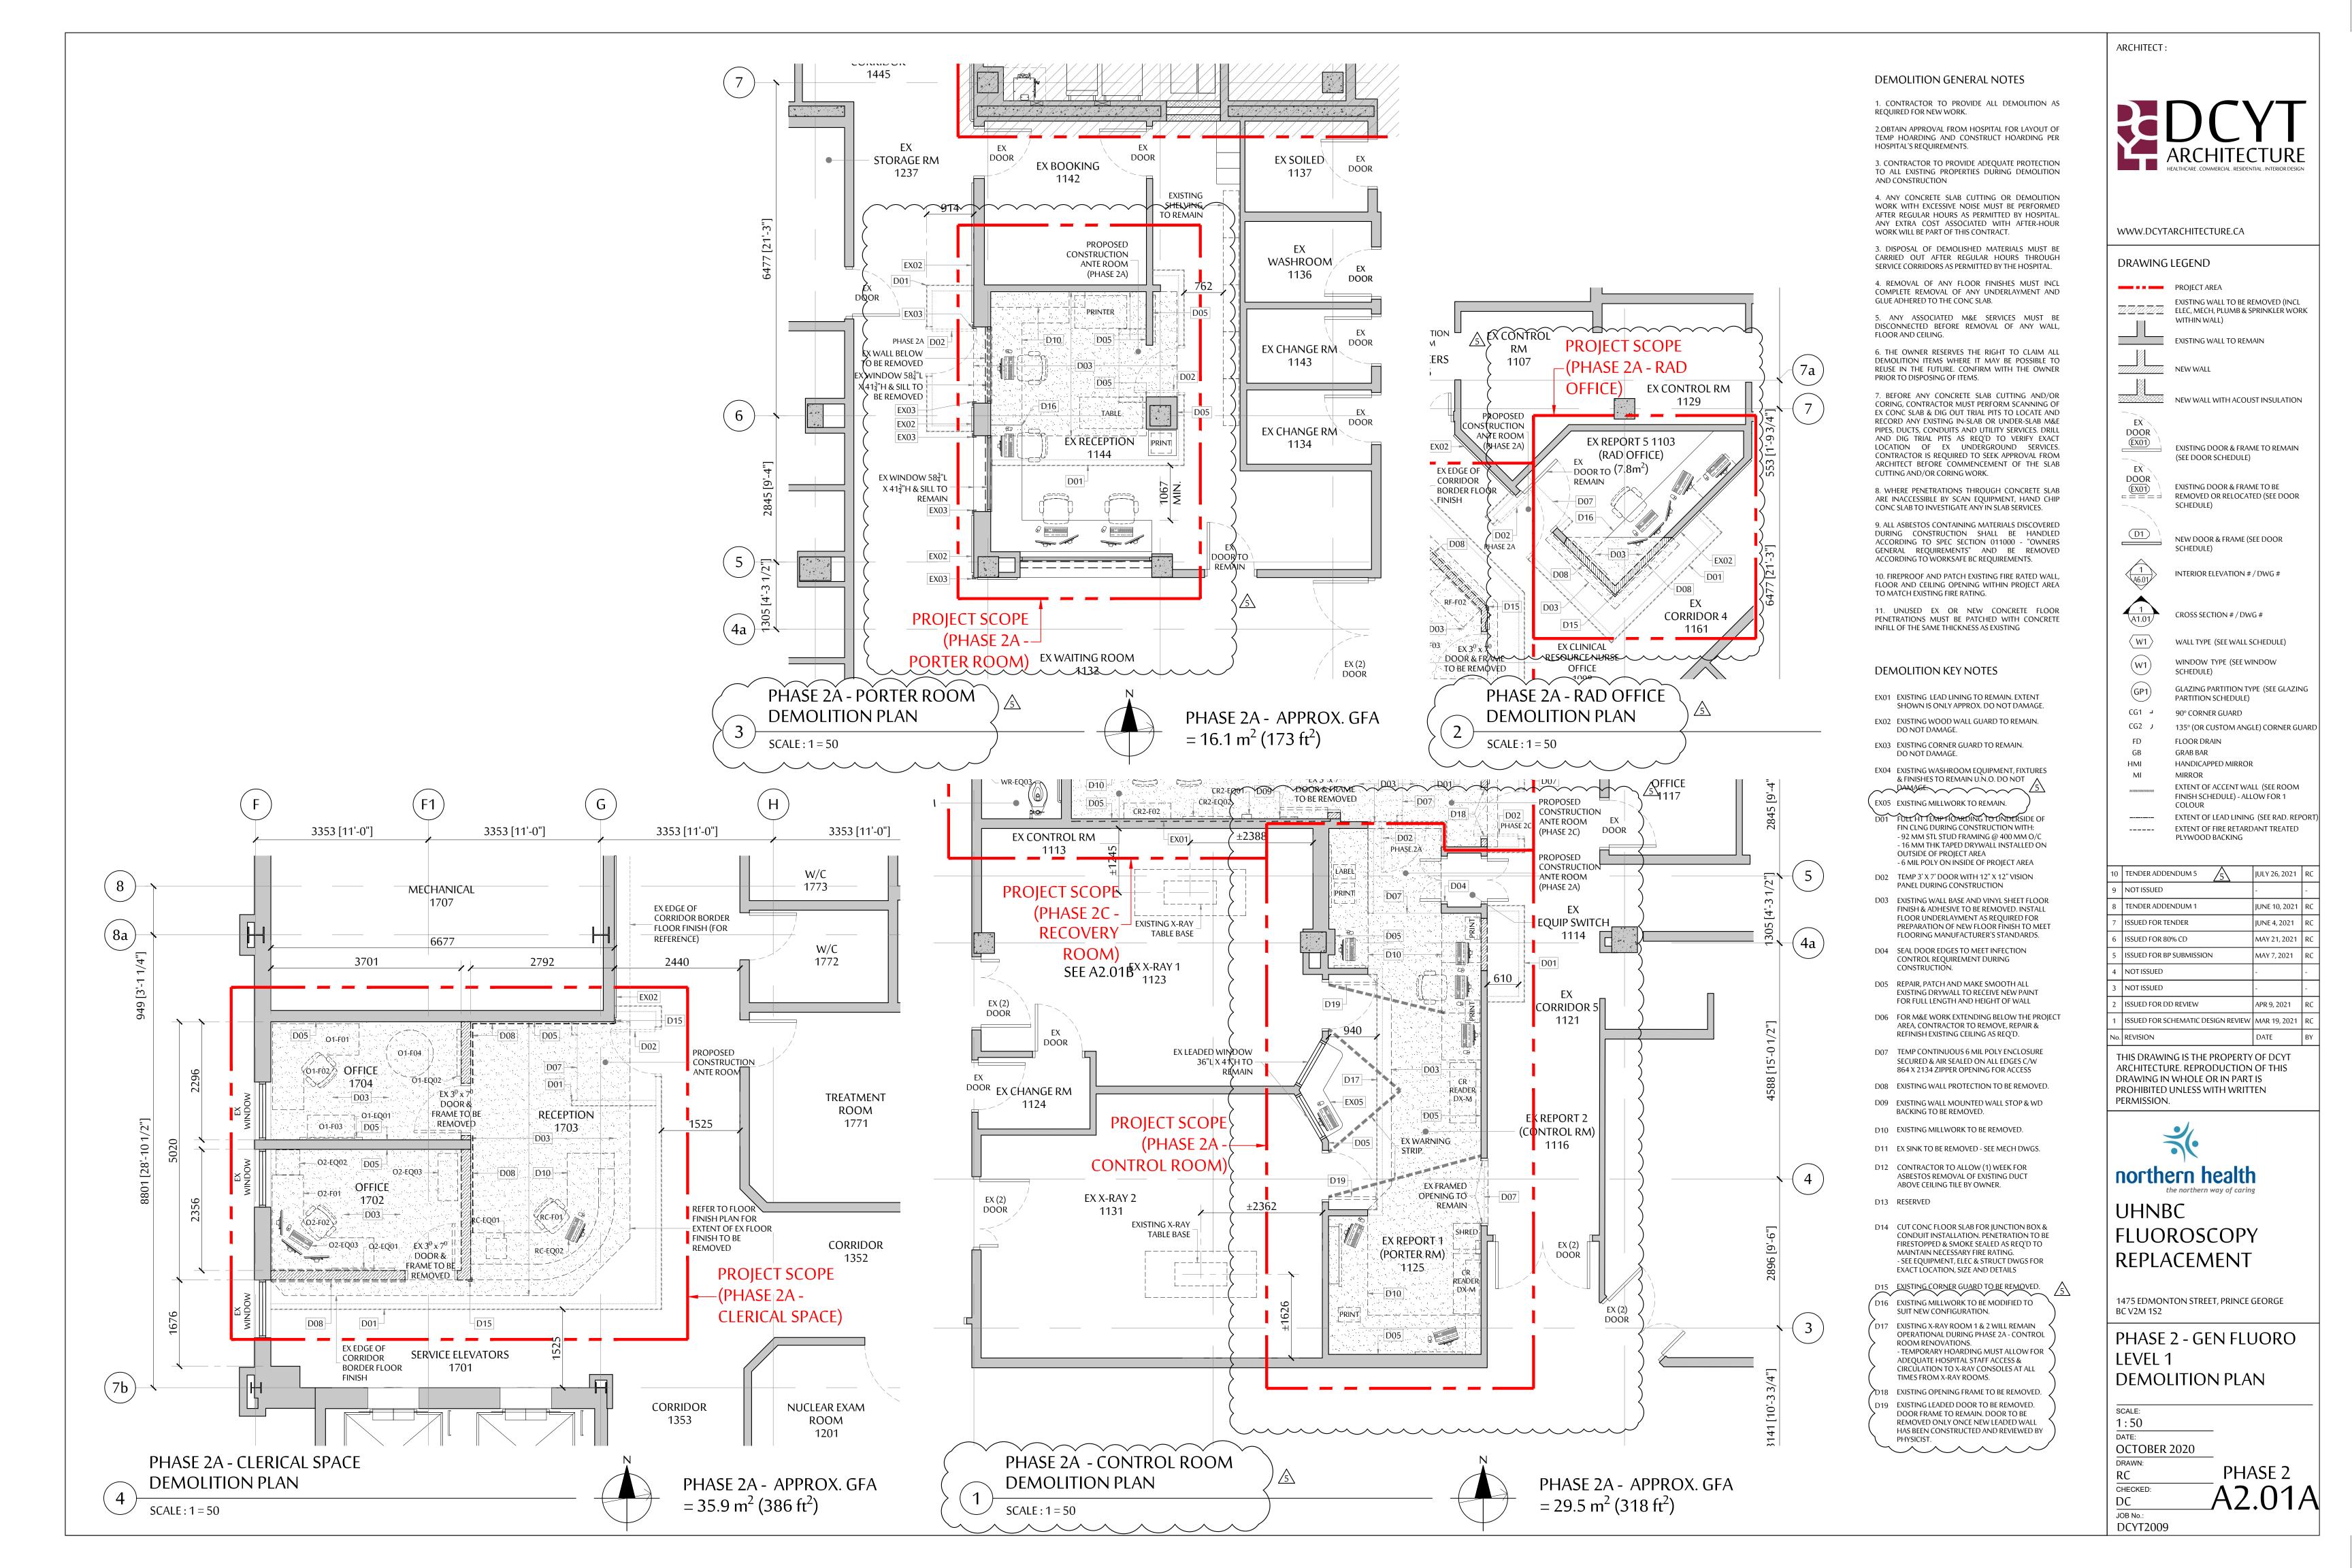

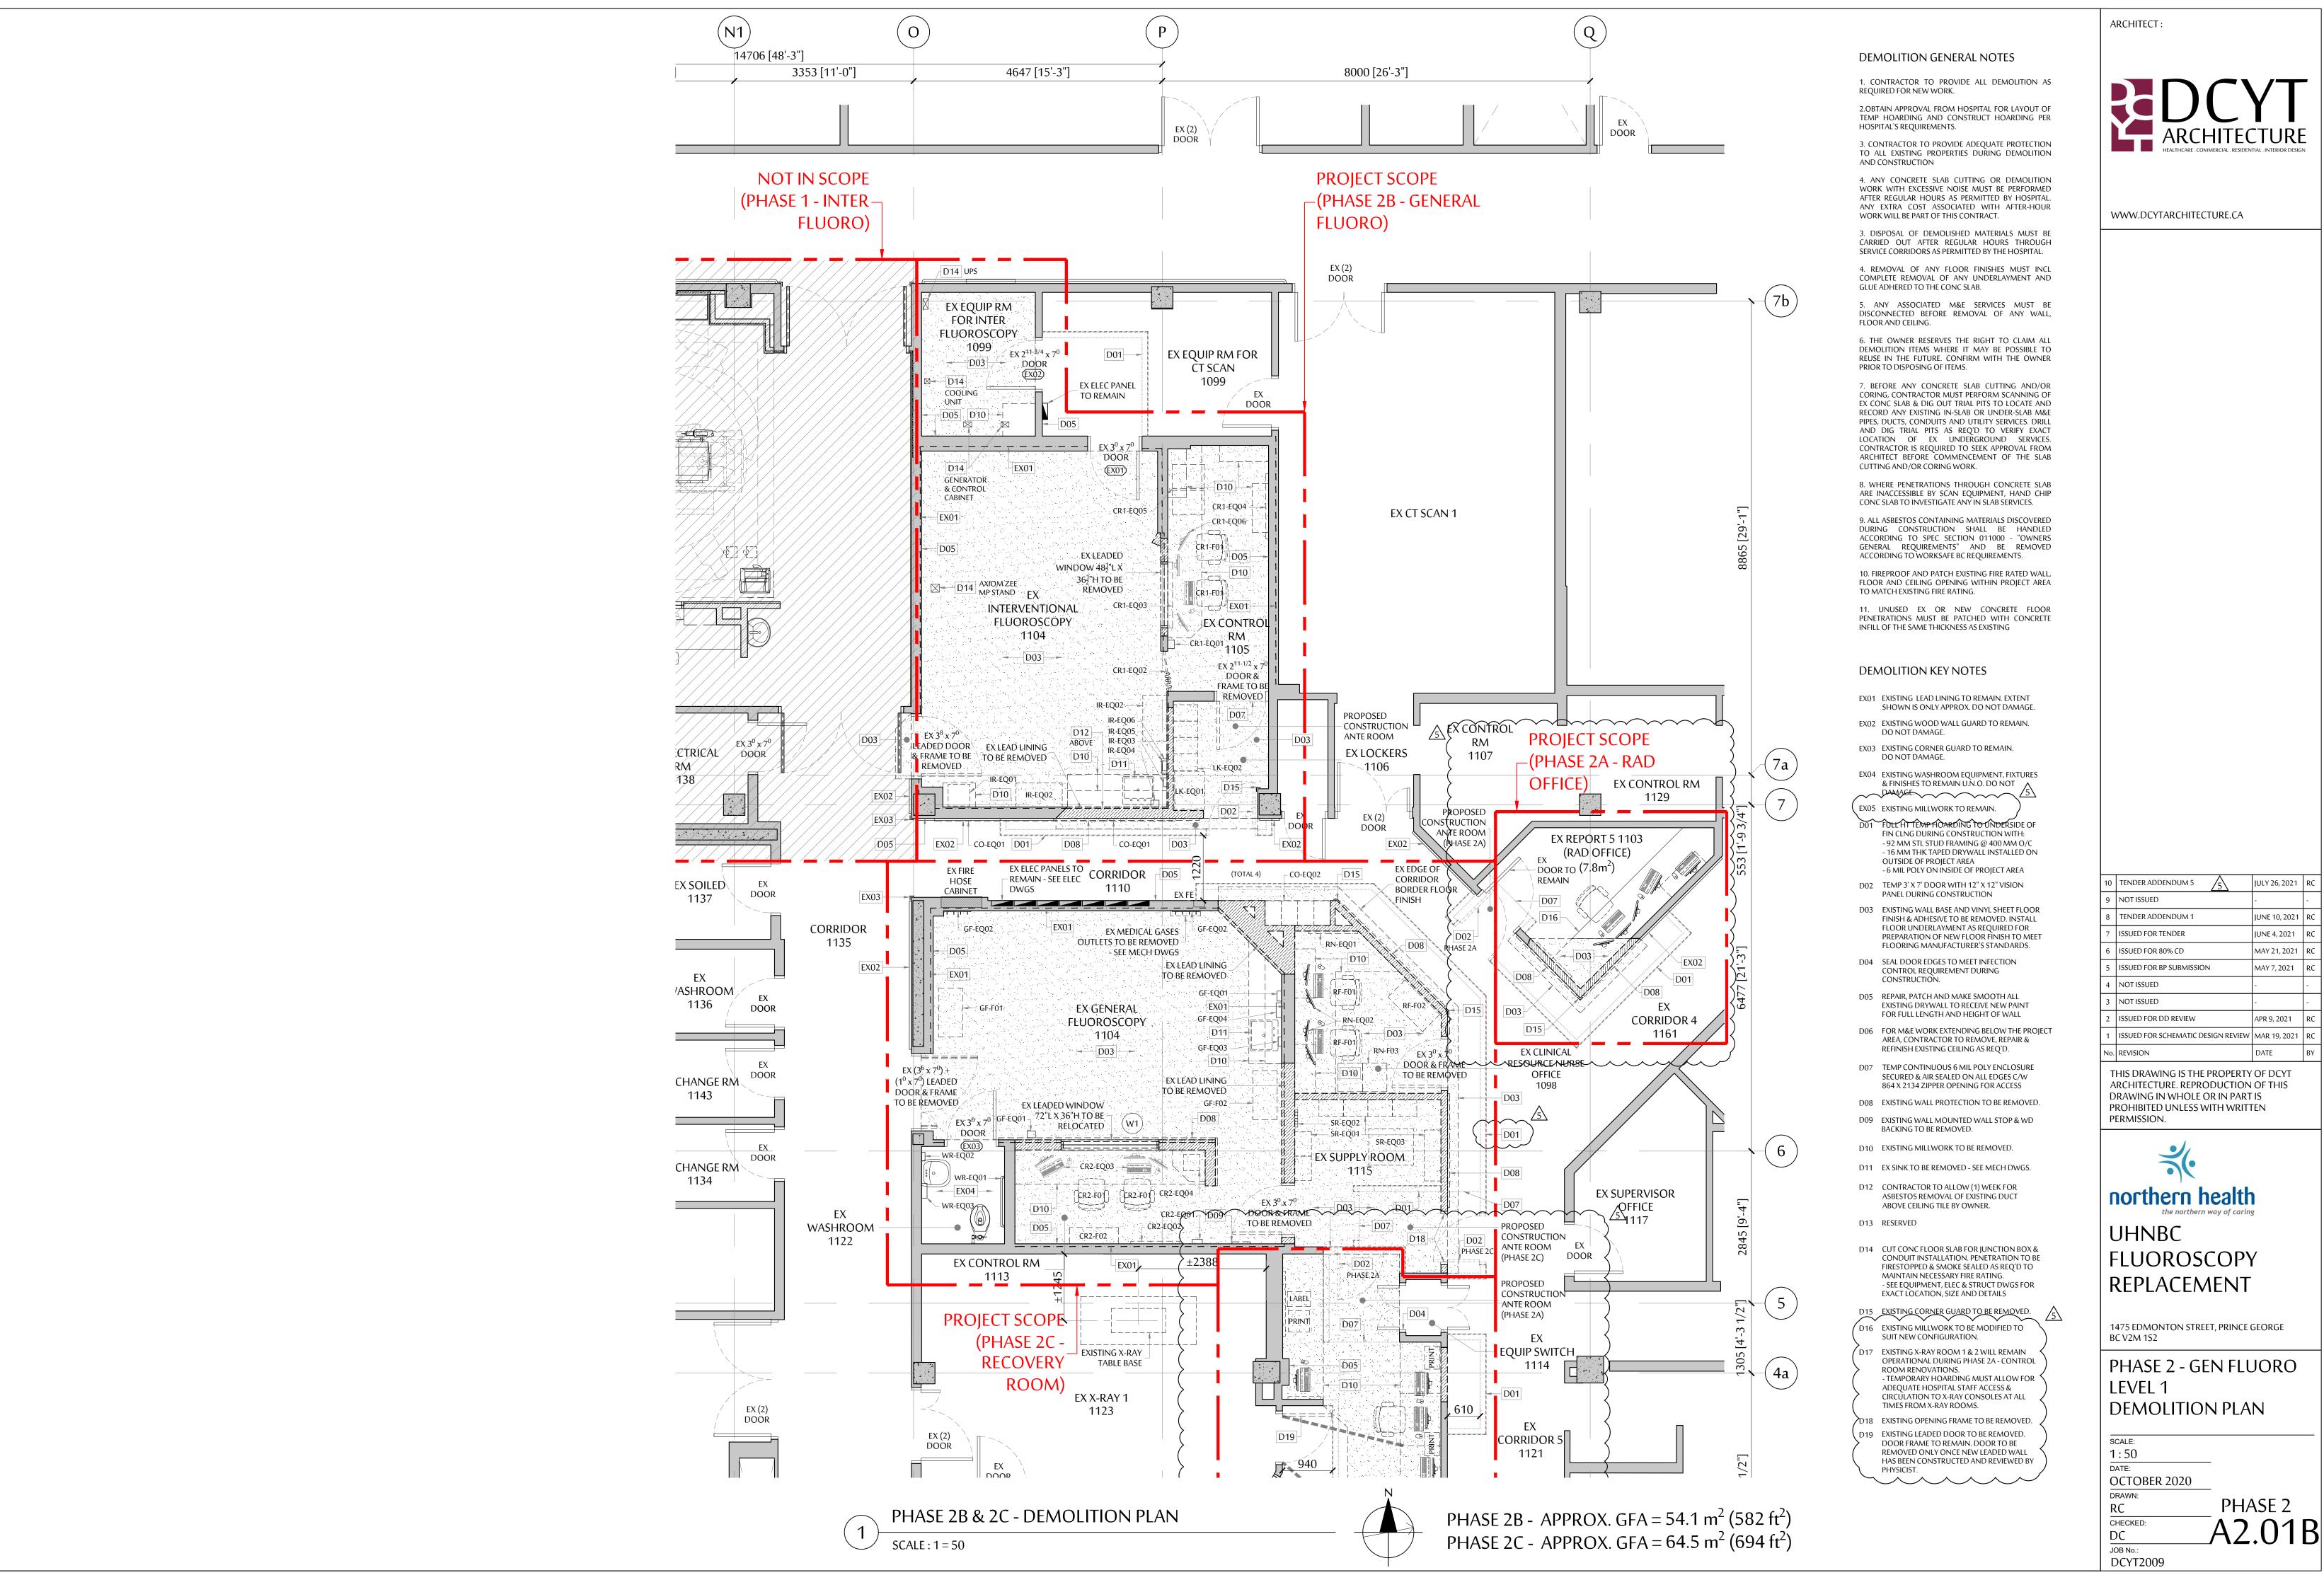


NOT ISSUED TENDER ADDENDUM 1 SSUED FOR TENDER SSUED FOR 80% CD SSUED FOR BP SUBMISSION	- JUNE 10, 2021 JUNE 4, 2021 MAY 21, 2021 MAY 7, 2021	- R
SSUED FOR TENDER SSUED FOR 80% CD	JUNE 4, 2021 MAY 21, 2021	R
SSUED FOR 80% CD	MAY 21, 2021	R
	,	_
SSUED FOR BP SUBMISSION	MAY 7, 2021	R
NOT ISSUED	-	-
NOT ISSUED	-	-
SSUED FOR DD REVIEW	APR 9, 2021	F
SSUED FOR SCHEMATIC DESIGN REVIEW	MAR 19, 2021	R
	DATE	В
	SSUED FOR SCHEMATIC DESIGN REVIEW	

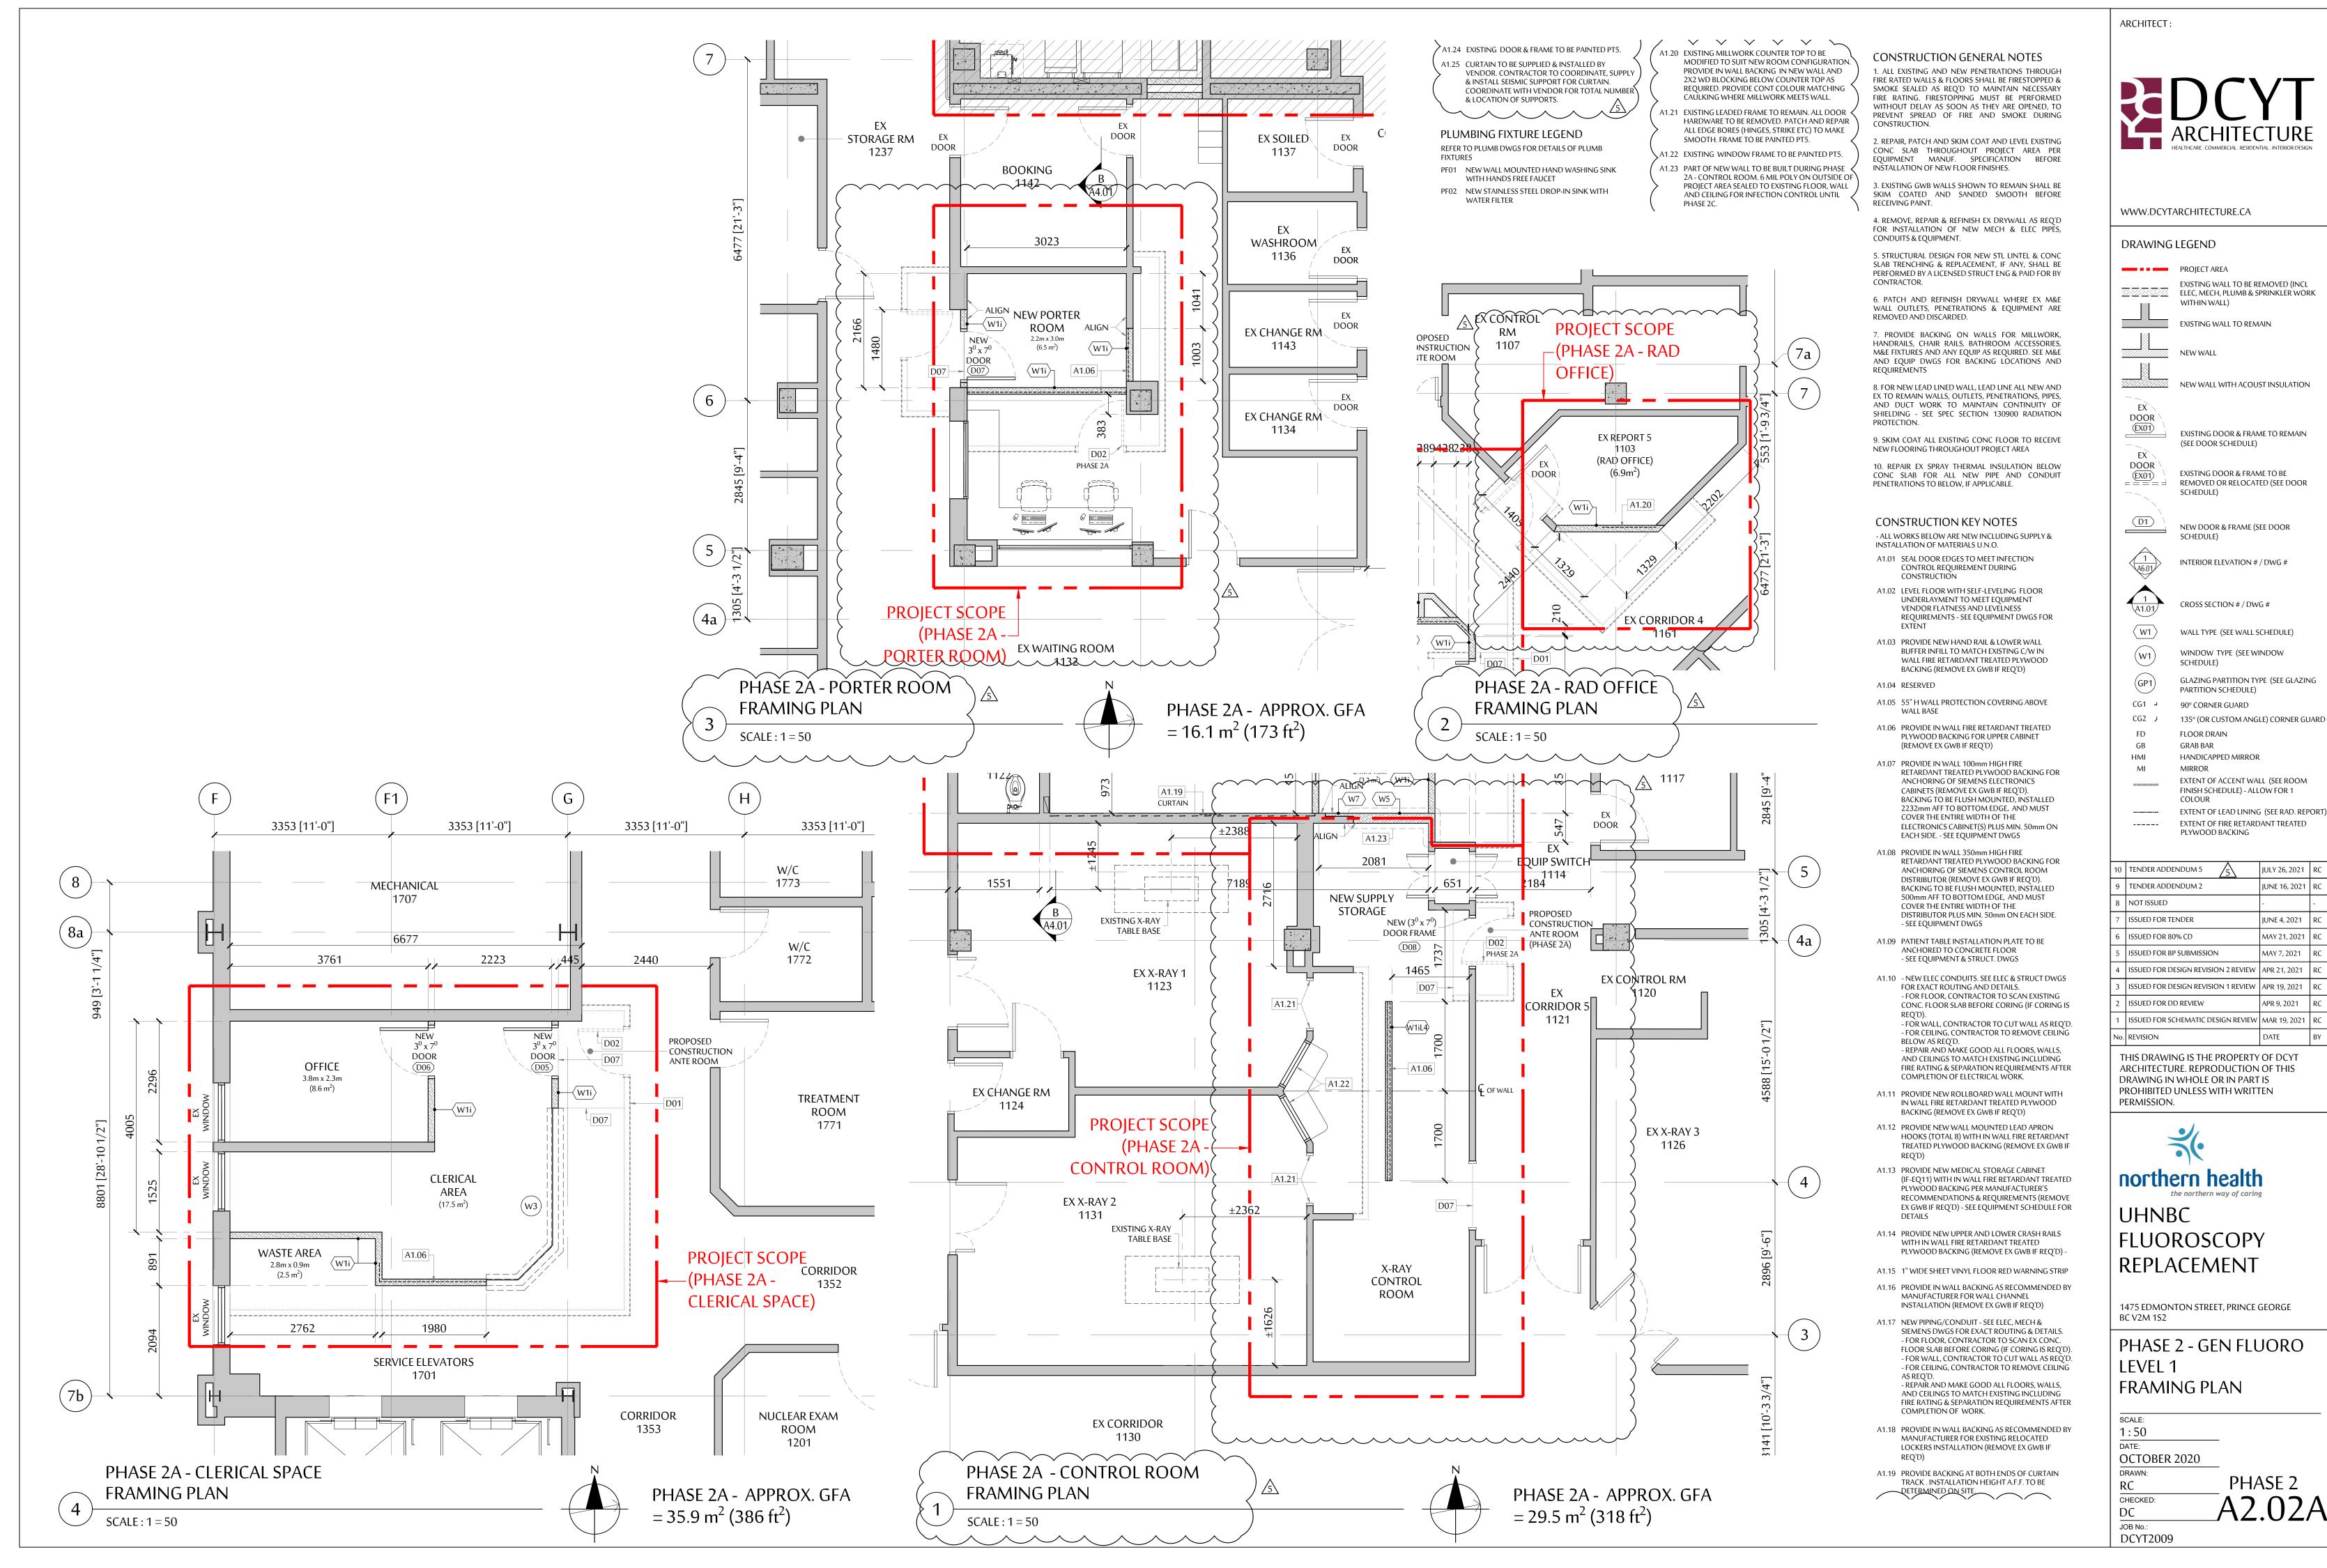

GLAZING PARTITION TYPE (SEE GLAZING

EXTENT OF LEAD LINING (SEE RAD. REPOR

JULY 26, 2021 RC JUNE 16, 2021 RC MAY 21, 2021 RC ISSUED FOR DESIGN REVISION 2 REVIEW | APR 21, 2021 | RC

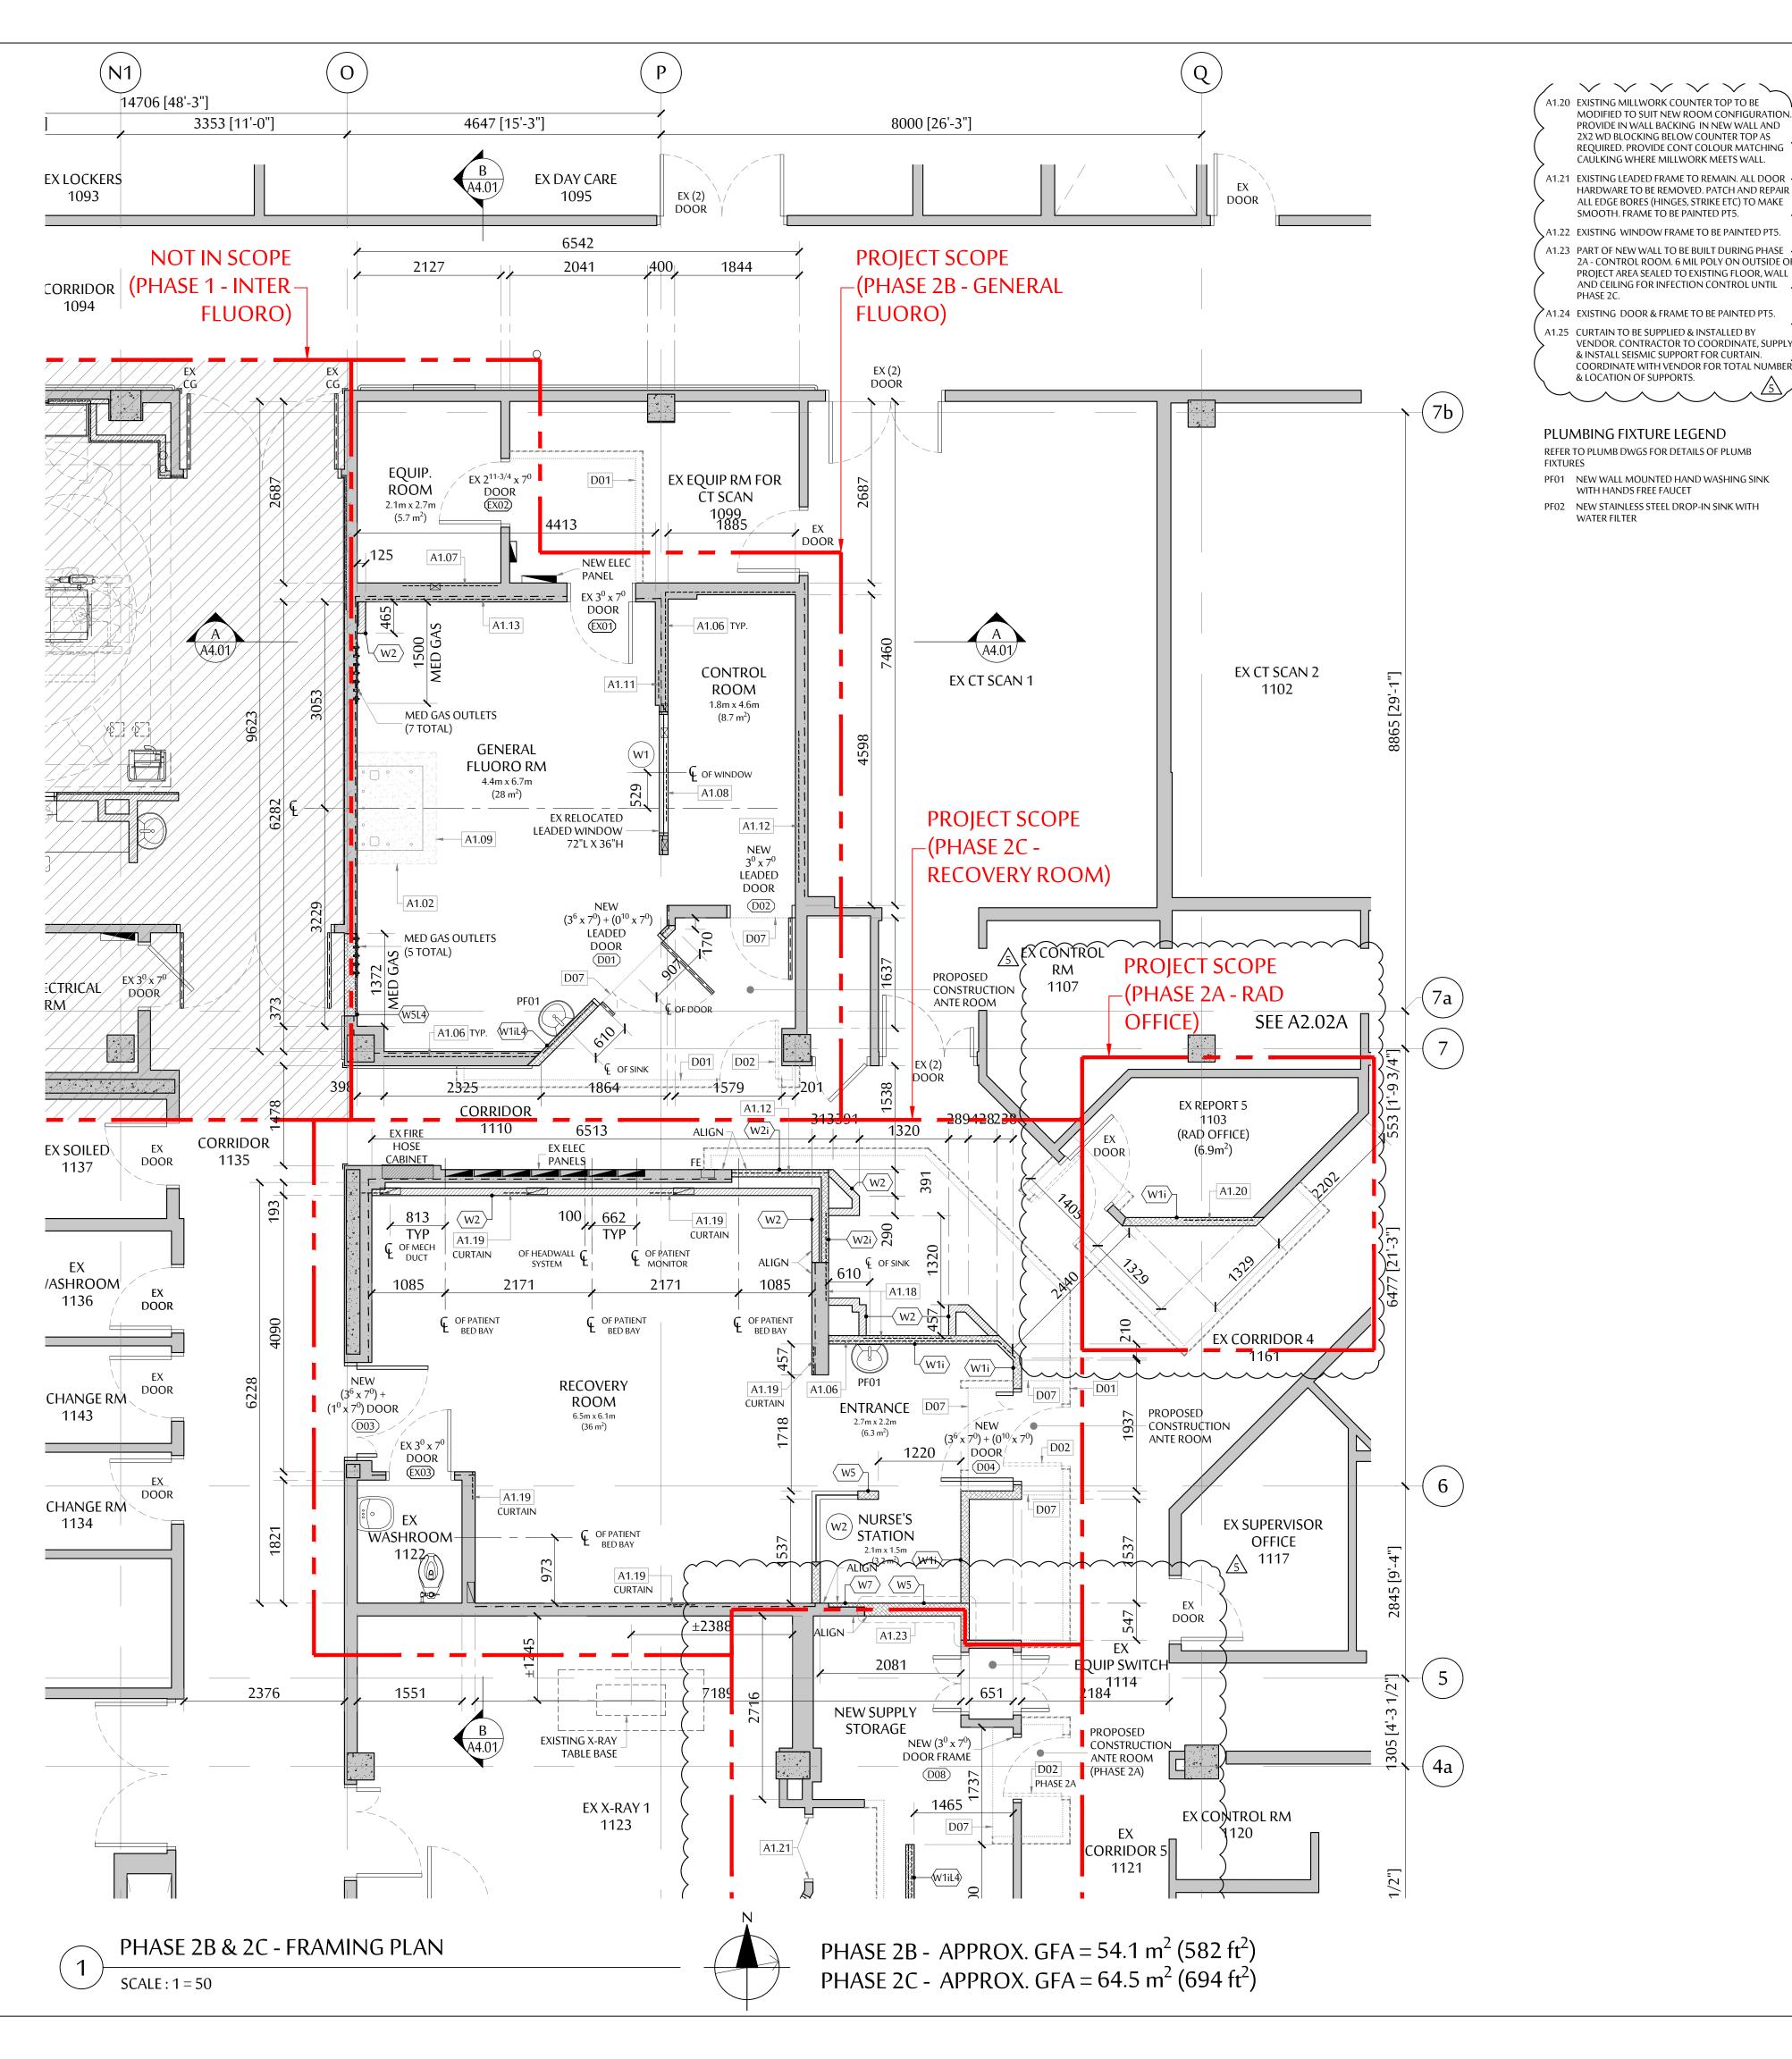

A1.20 EXISTING MILLWORK COUNTER TOP TO BE MODIFIED TO SUIT NEW ROOM CONFIGURATION.

CONSTRUCTION GENERAL NOTES

1. ALL EXISTING AND NEW PENETRATIONS THROUGH
FIRE RATED WALLS & FLOORS SHALL BE FIRESTOPPED &
SMOKE SEALED AS REQ'D TO MAINTAIN NECESSARY
FIRE RATING. FIRESTOPPING MUST BE PERFORMED
WITHOUT DELAY AS SOON AS THEY ARE OPENED, TO
PREVENT SPREAD OF FIRE AND SMOKE DURING
CONSTRUCTION.

CONSTRUCTION.

2. REPAIR, PATCH AND SKIM COAT AND LEVEL EXISTING CONC SLAB THROUGHOUT PROJECT AREA PER EQUIPMENT MANUF. SPECIFICATION BEFORE INSTALLATION OF NEW FLOOR FINISHES.

3. EXISTING GWB WALLS SHOWN TO REMAIN SHALL BE SKIM COATED AND SANDED SMOOTH BEFORE RECEIVING PAINT.

4. REMOVE, REPAIR & REFINISH EX DRYWALL AS REQ'D FOR INSTALLATION OF NEW MECH & ELEC PIPES,

& INSTALL SEISMIC SUPPORT FOR CURTAIN.
COORDINATE WITH VENDOR FOR TOTAL NUMBER
& LOCATION OF SUPPORTS.

5. STRUCTURAL DESIGN FOR NEW STL LINTEL & CONC
SLAB TRENCHING & REPLACEMENT, IF ANY, SHALL BE
PERFORMED BY A LICENSED STRUCT ENG & PAID FOR BY

CONDUITS & EQUIPMENT.

6. PATCH AND REFINISH DRYWALL WHERE EX M&E WALL OUTLETS, PENETRATIONS & EQUIPMENT ARE REMOVED AND DISCARDED.

7. PROVIDE BACKING ON WALLS FOR MILLWORK, HANDRAILS, CHAIR RAILS, BATHROOM ACCESSORIES, M&E FIXTURES AND ANY EQUIP AS REQUIRED. SEE M&E AND EQUIP DWGS FOR BACKING LOCATIONS AND REQUIREMENTS

AND DUCT WORK TO MAINTAIN CONTINUITY OF SHIELDING - SEE SPEC SECTION 130900 RADIATION PROTECTION.

8. FOR NEW LEAD LINED WALL, LEAD LINE ALL NEW AND EX TO REMAIN WALLS, OUTLETS, PENETRATIONS, PIPES,

9. SKIM COAT ALL EXISTING CONC FLOOR TO RECEIVE NEW FLOORING THROUGHOUT PROJECT AREA

10. REPAIR EX SPRAY THERMAL INSULATION BELOW CONC SLAB FOR ALL NEW PIPE AND CONDUIT PENETRATIONS TO BELOW, IF APPLICABLE.

CONSTRUCTION KEY NOTES

- ALL WORKS BELOW ARE NEW INCLUDING SUPPLY & INSTALLATION OF MATERIALS U.N.O.

A1.01 SEAL DOOR EDGES TO MEET INFECTION
CONTROL REQUIREMENT DURING

A1.02 LEVEL FLOOR WITH SELF-LEVELING FLOOR UNDERLAYMENT TO MEET EQUIPMENT VENDOR FLATNESS AND LEVELNESS REQUIREMENTS - SEE EQUIPMENT DWGS FOR

A1.03 PROVIDE NEW HAND RAIL & LOWER WALL BUFFER INFILL TO MATCH EXISTING C/W IN WALL FIRE RETARDANT TREATED PLYWOOD BACKING (REMOVE EX GWB IF REQ'D)

A1.04 RESERVED

CONSTRUCTION

A1.05 55" H WALL PROTECTION COVERING ABOVE WALL BASE

A1.06 PROVIDE IN WALL FIRE RETARDANT TREATED PLYWOOD BACKING FOR UPPER CABINET (REMOVE EX GWB IF REQ'D)

A1.07 PROVIDE IN WALL 100mm HIGH FIRE
RETARDANT TREATED PLYWOOD BACKING FOR
ANCHORING OF SIEMENS ELECTRONICS
CABINETS (REMOVE EX GWB IF REQ'D).
BACKING TO BE FLUSH MOUNTED, INSTALLED
2232mm AFF TO BOTTOM EDGE, AND MUST
COVER THE ENTIRE WIDTH OF THE
ELECTRONICS CABINET(S) PLUS MIN. 50mm ON
EACH SIDE. - SEE EQUIPMENT DWGS

A1.08 PROVIDE IN WALL 350mm HIGH FIRE
RETARDANT TREATED PLYWOOD BACKING FOR
ANCHORING OF SIEMENS CONTROL ROOM
DISTRIBUTOR (REMOVE EX GWB IF REQ'D).
BACKING TO BE FLUSH MOUNTED, INSTALLED
500mm AFF TO BOTTOM EDGE, AND MUST
COVER THE ENTIRE WIDTH OF THE
DISTRIBUTOR PLUS MIN. 50mm ON EACH SIDE.
- SEE EQUIPMENT DWGS

A1.09 PATIENT TABLE INSTALLATION PLATE TO BE ANCHORED TO CONCRETE FLOOR
- SEE EQUIPMENT & STRUCT. DWGS

A1.10 - NEW ELEC CONDUITS. SEE ELEC & STRUCT DWGS FOR EXACT ROUTING AND DETAILS.
- FOR FLOOR, CONTRACTOR TO SCAN EXISTING CONC. FLOOR SLAB BEFORE CORING (IF CORING IS REQ'D).
- FOR WALL, CONTRACTOR TO CUT WALL AS REQ'D.
- FOR CEILING, CONTRACTOR TO REMOVE CEILING BELOW AS REQ'D.
- REPAIR AND MAKE GOOD ALL FLOORS, WALLS, AND CEILINGS TO MATCH EXISTING INCLUDING

AND CEILINGS TO MATCH EXISTING INCLUDING
FIRE RATING & SEPARATION REQUIREMENTS AFTER
COMPLETION OF ELECTRICAL WORK.

A1.11 PROVIDE NEW ROLLBOARD WALL MOUNT WITH

TREATED PLYWOOD BACKING (REMOVE EX GWB IF

IN WALL FIRE RETARDANT TREATED PLYWOOD
BACKING (REMOVE EX GWB IF REQ'D)

A1.12 PROVIDE NEW WALL MOUNTED LEAD APRON
HOOKS (TOTAL 8) WITH IN WALL FIRE RETARDANT

A1.13 PROVIDE NEW MEDICAL STORAGE CABINET
(IF-EQ11) WITH IN WALL FIRE RETARDANT TREATED
PLYWOOD BACKING PER MANUFACTURER'S
RECOMMENDATIONS & REQUIREMENTS (REMOVE
EX GWB IF REQ'D) - SEE EQUIPMENT SCHEDULE FOR

A1.14 PROVIDE NEW UPPER AND LOWER CRASH RAILS WITH IN WALL FIRE RETARDANT TREATED PLYWOOD BACKING (REMOVE EX GWB IF REQ'D)

A1.15 1" WIDE SHEET VINYL FLOOR RED WARNING STRIP

A1.16 PROVIDE IN WALL BACKING AS RECOMMENDED BY MANUFACTURER FOR WALL CHANNEL INSTALLATION (REMOVE EX GWB IF REQ'D)

A1.17 NEW PIPING/CONDUIT - SEE ELEC, MECH &
SIEMENS DWGS FOR EXACT ROUTING & DETAILS.
- FOR FLOOR, CONTRACTOR TO SCAN EX CONC.
FLOOR SLAB BEFORE CORING (IF CORING IS REQ'D).
- FOR WALL, CONTRACTOR TO CUT WALL AS REQ'D.
- FOR CEILING, CONTRACTOR TO REMOVE CEILING AS REQ'D.
- REPAIR AND MAKE GOOD ALL FLOORS, WALLS, AND CEILINGS TO MATCH EXISTING INCLUDING FIRE RATING & SEPARATION REQUIREMENTS AFTER

A1.18 PROVIDE IN WALL BACKING AS RECOMMENDED BY MANUFACTURER FOR EXISTING RELOCATED LOCKERS INSTALLATION (REMOVE EX GWB IF

A1.19 PROVIDE BACKING AT BOTH ENDS OF CURTAIN TRACK . INSTALLATION HEIGHT A.F.F. TO BE DETERMINED ON SITE.

COMPLETION OF WORK.

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ARCHITECT:

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9	TENDER ADDENDUM 2	JUNE 16, 2021	RC
8	NOT ISSUED	-	-
7	ISSUED FOR TENDER	JUNE 4, 2021	RC
6	ISSUED FOR 80% CD	MAY 21, 2021	RC
5	ISSUED FOR BP SUBMISSION	MAY 7, 2021	RC
4	ISSUED FOR DESIGN REVISION 2 REVIEW	APR 21, 2021	RC
3	ISSUED FOR DESIGN REVISION 1 REVIEW	APR 19, 2021	RC
2	ISSUED FOR DD REVIEW	APR 9, 2021	RC
1	ISSUED FOR SCHEMATIC DESIGN REVIEW	MAR 19, 2021	RC
No.	REVISION	DATE	BY
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JULY 26, 2021 RC

10 TENDER ADDENDUM 5

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UHNBC FLUOROSCOPY REPLACEMENT

1475 EDMONTON STREET, PRINCE GEORGE BC V2M 1S2

PHASE 2 - GEN FLUORO LEVEL 1 FRAMING PLAN

SCALE:

1:50

DATE:

OCTOBER 2020

DRAWN:

RC

CHECKED:


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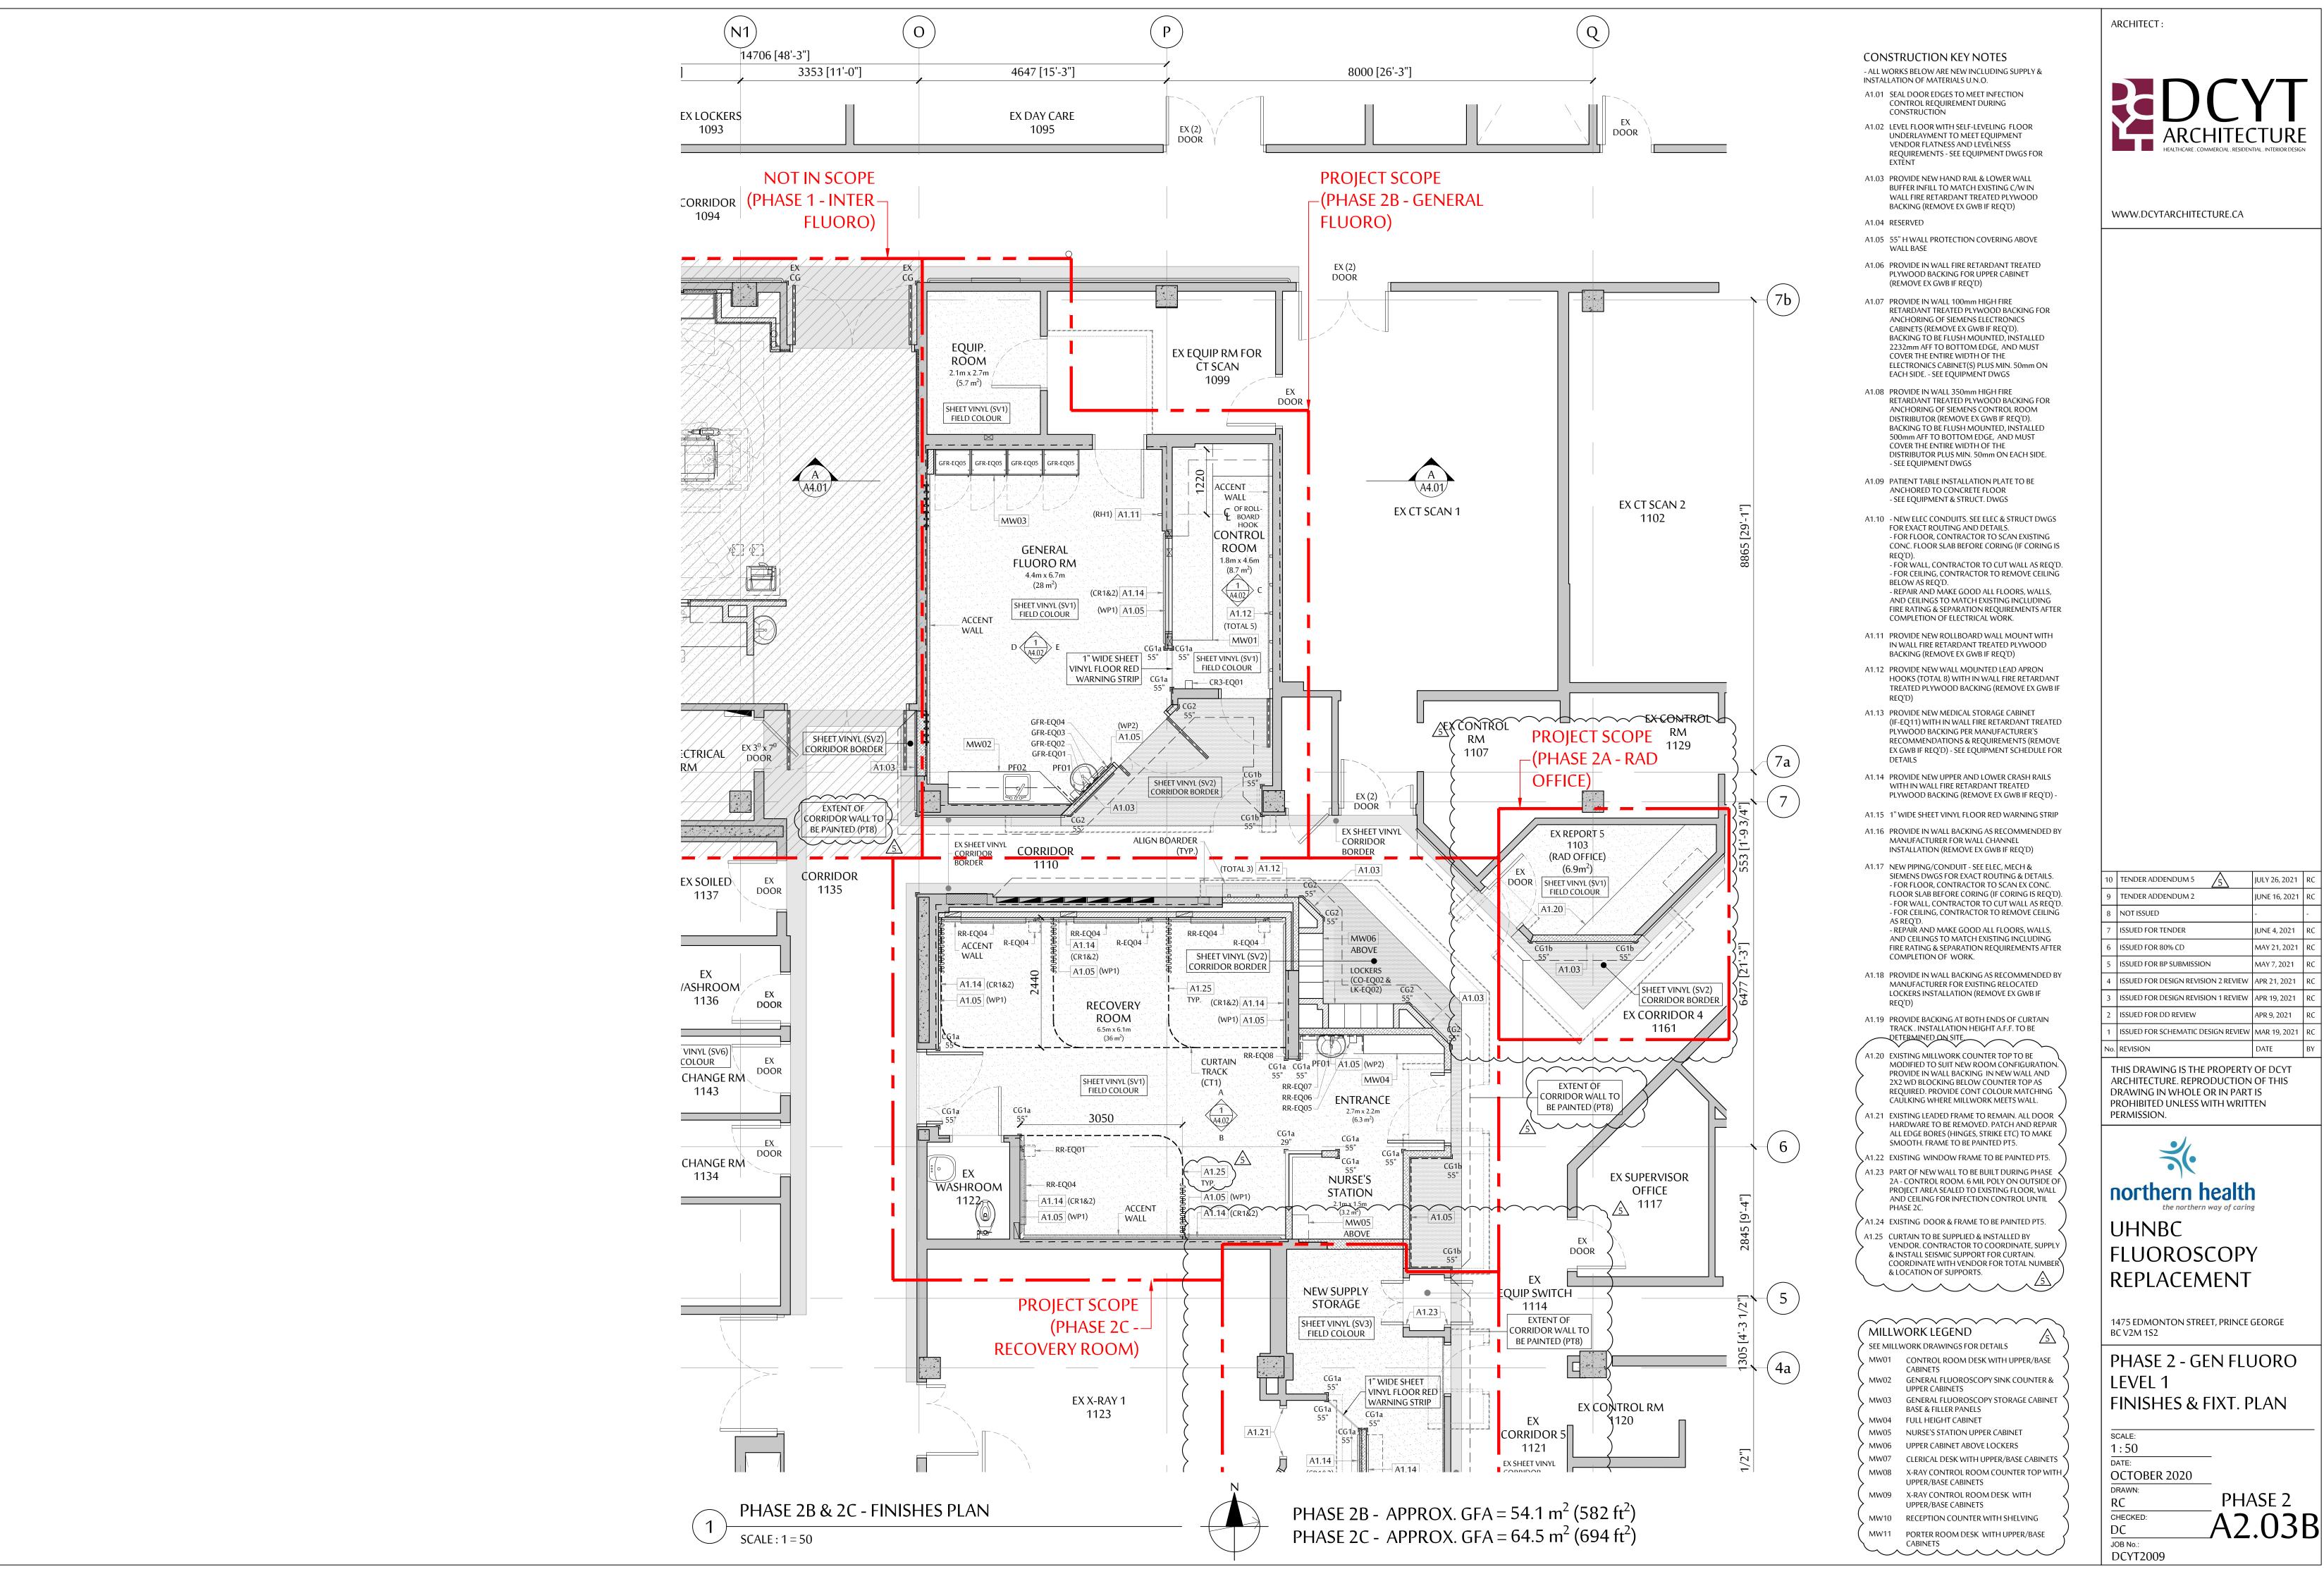
JOB No.:

PHASE 2


A2.02


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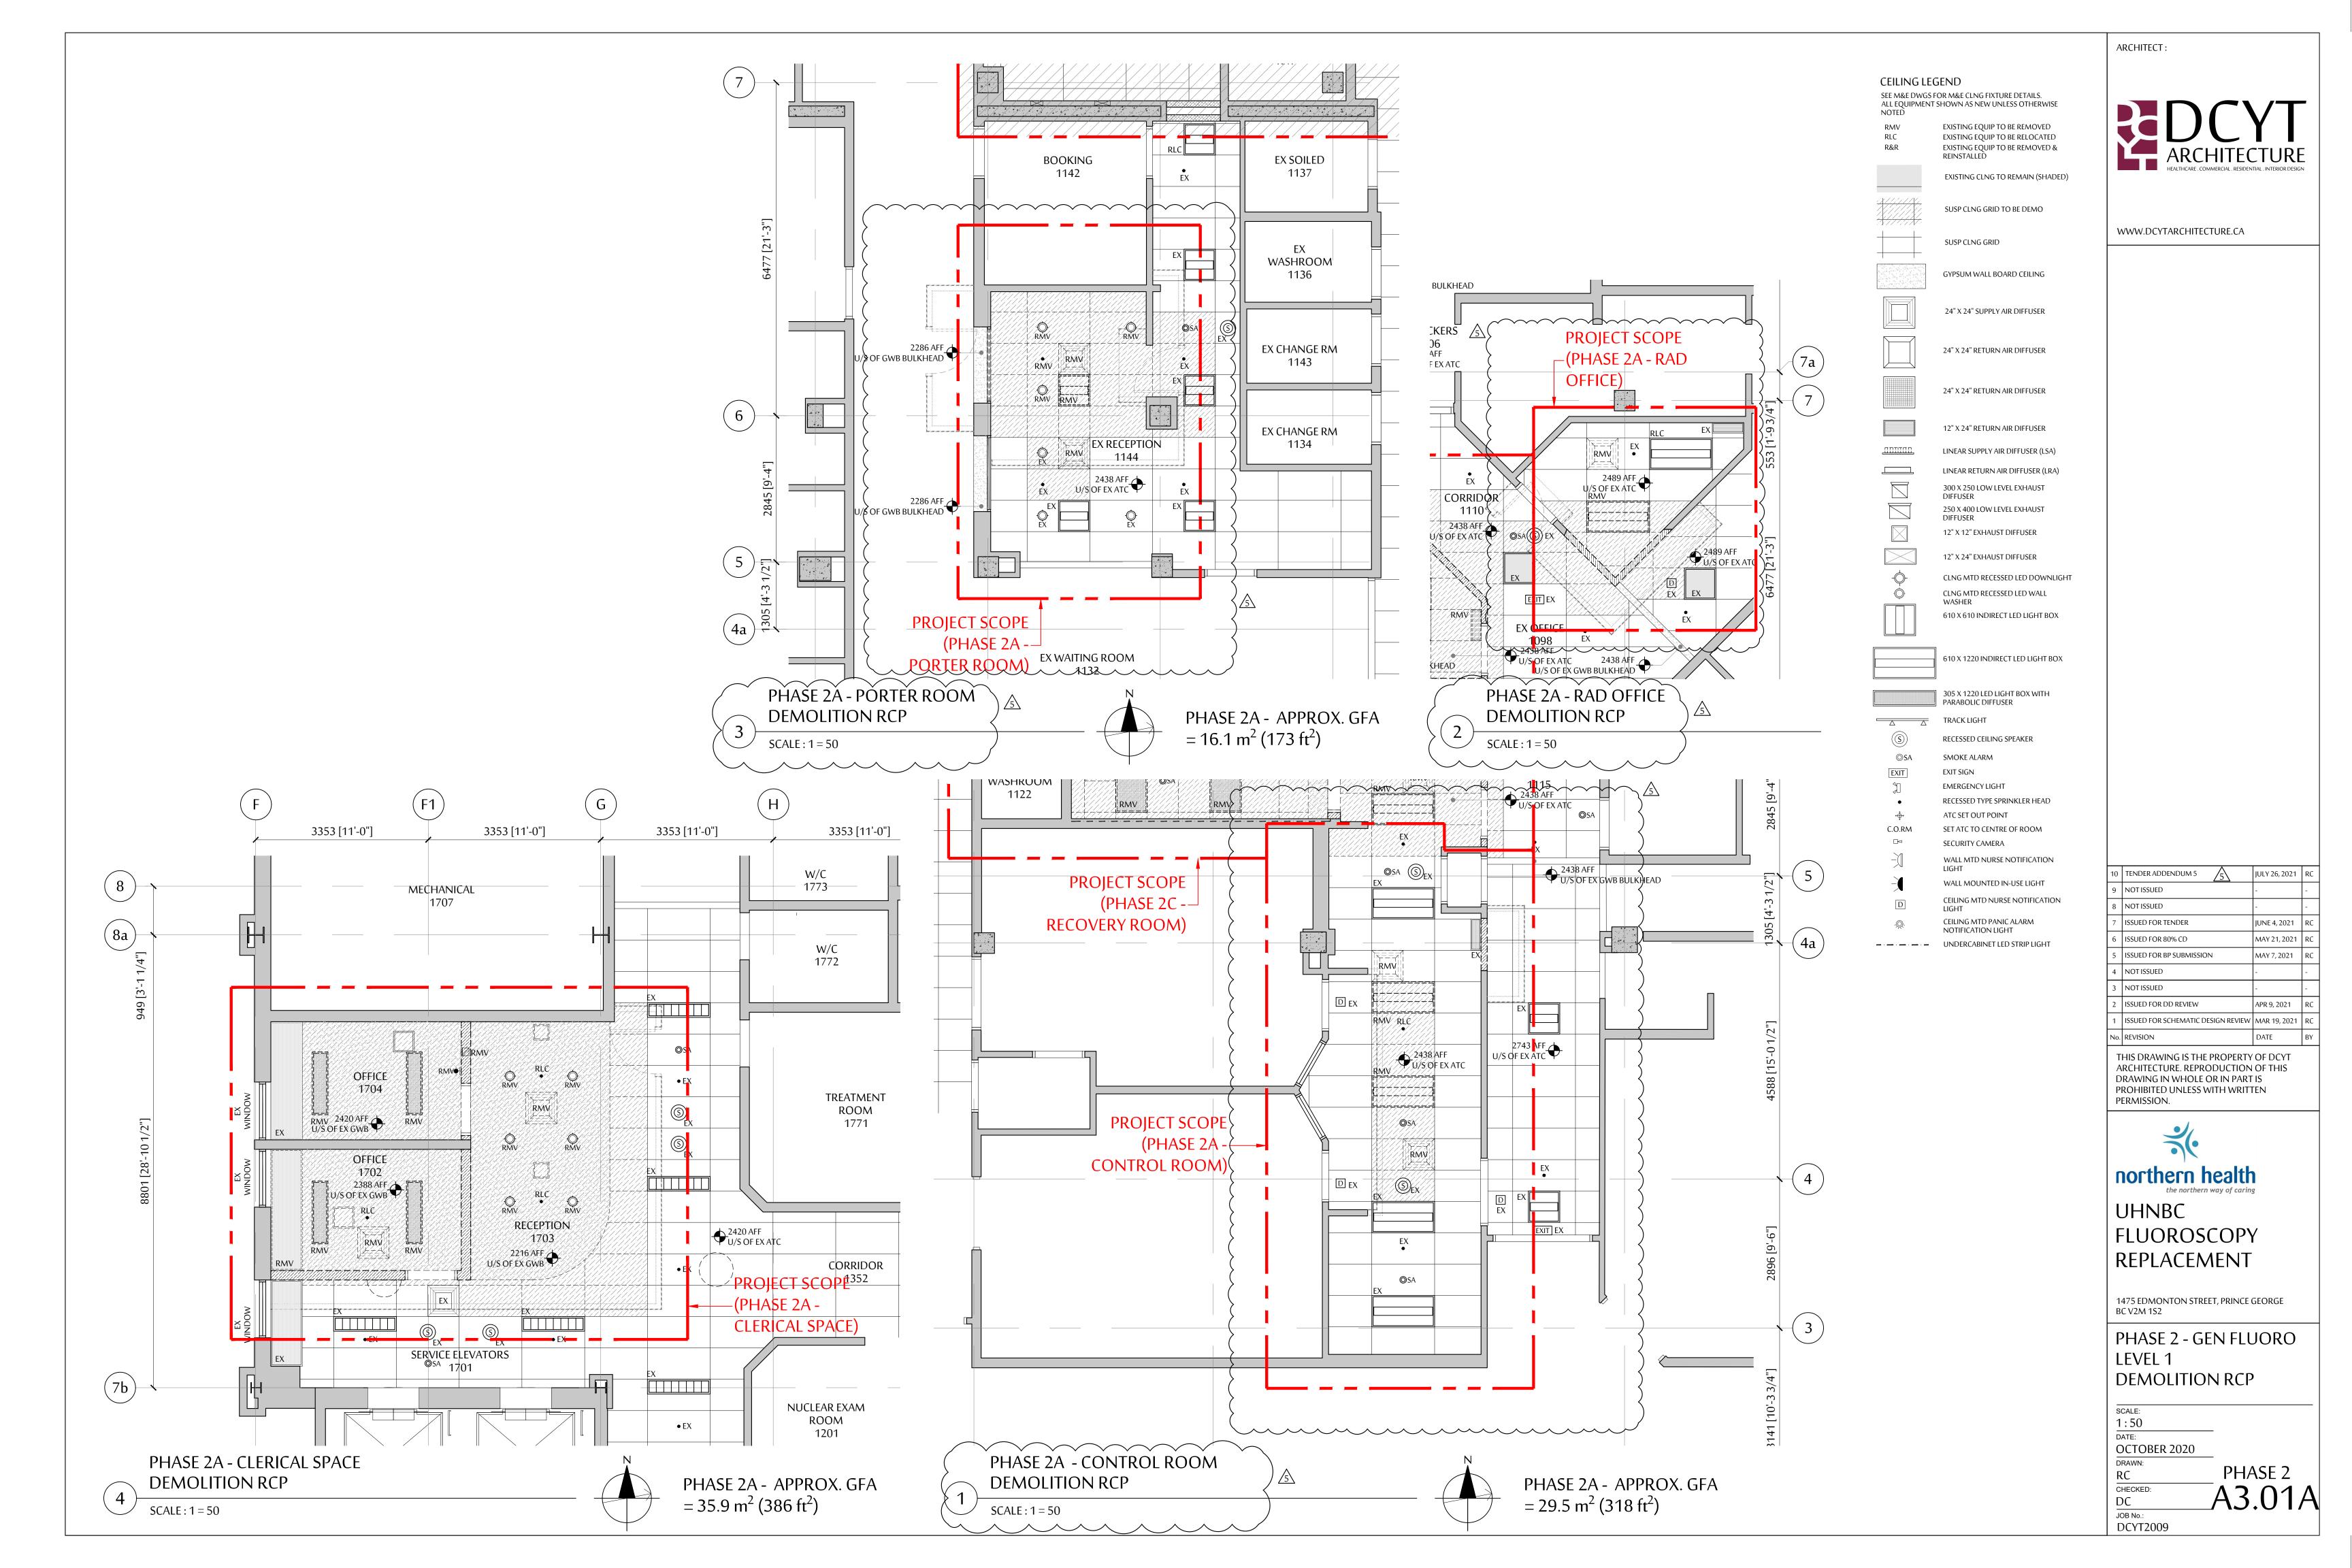


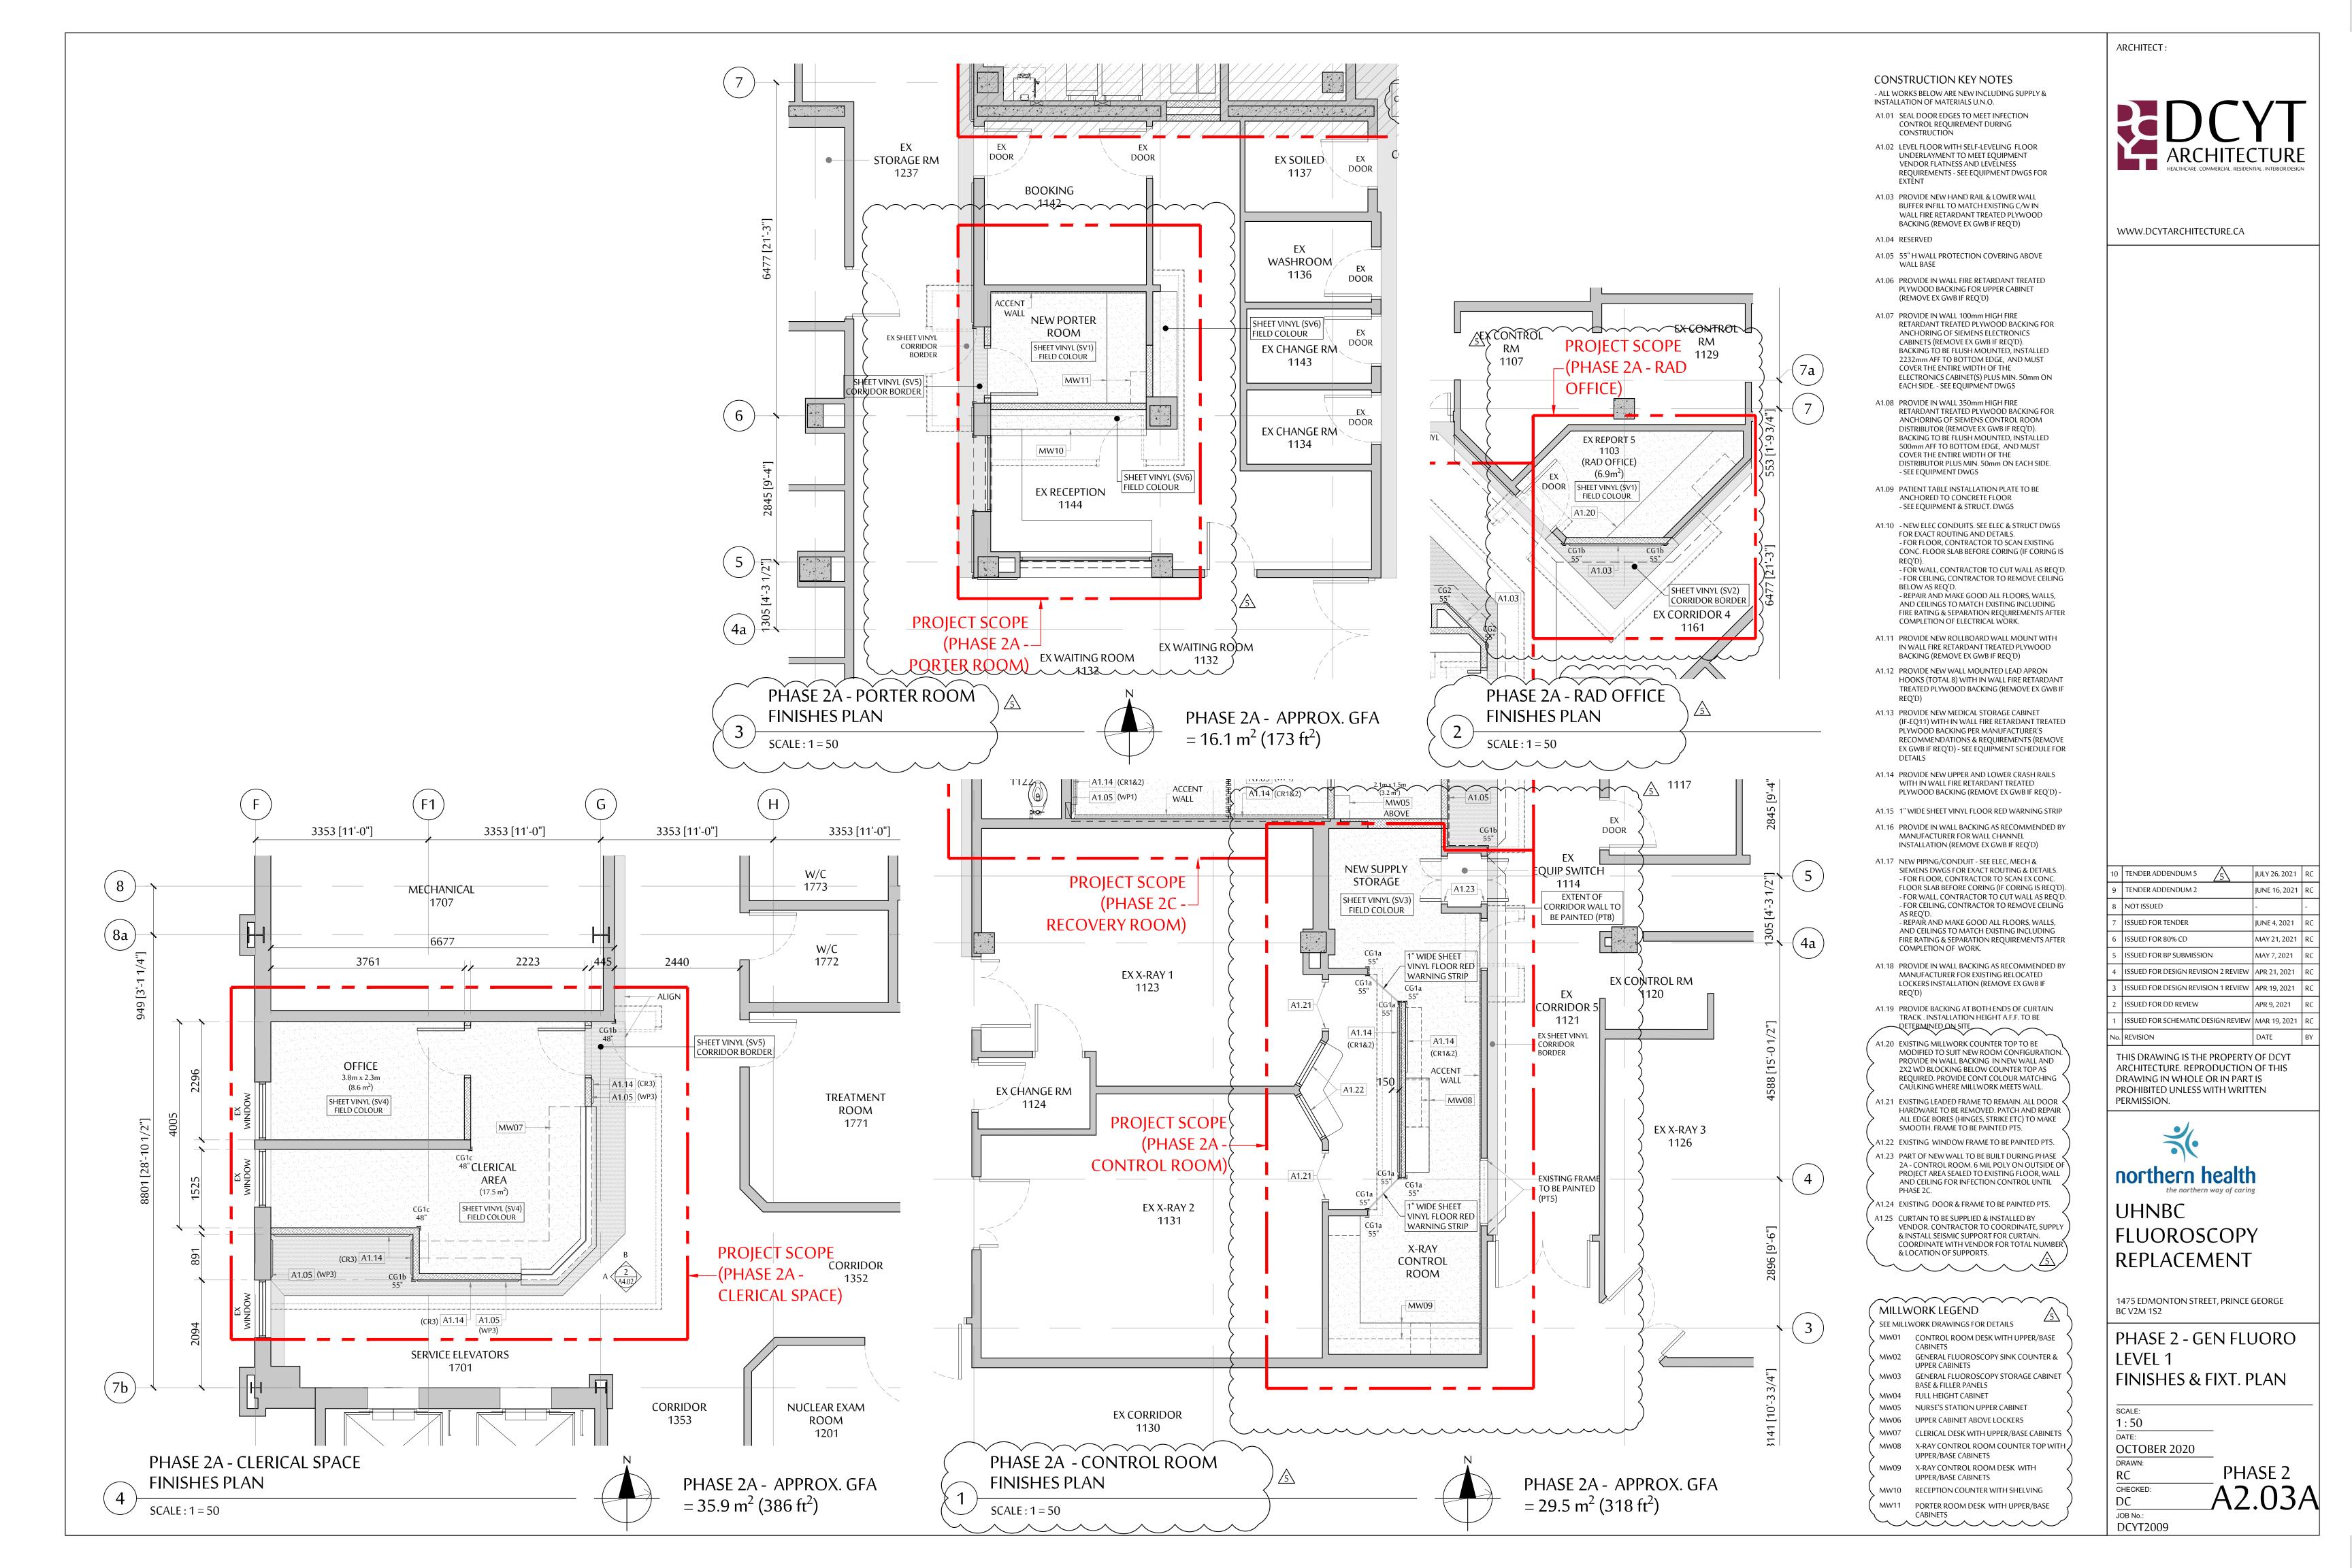



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9	TENDER ADDENDUM 2	JUNE 16, 2021	RC
8	NOT ISSUED	-	-
7	ISSUED FOR TENDER	JUNE 4, 2021	RC
6	ISSUED FOR 80% CD	MAY 21, 2021	RC
5	ISSUED FOR BP SUBMISSION	MAY 7, 2021	RC
4	ISSUED FOR DESIGN REVISION 2 REVIEW	APR 21, 2021	RC
3	ISSUED FOR DESIGN REVISION 1 REVIEW	APR 19, 2021	RC
2	ISSUED FOR DD REVIEW	APR 9, 2021	RC
1	ISSUED FOR SCHEMATIC DESIGN REVIEW	MAR 19, 2021	RC
No.	REVISION	DATE	BY



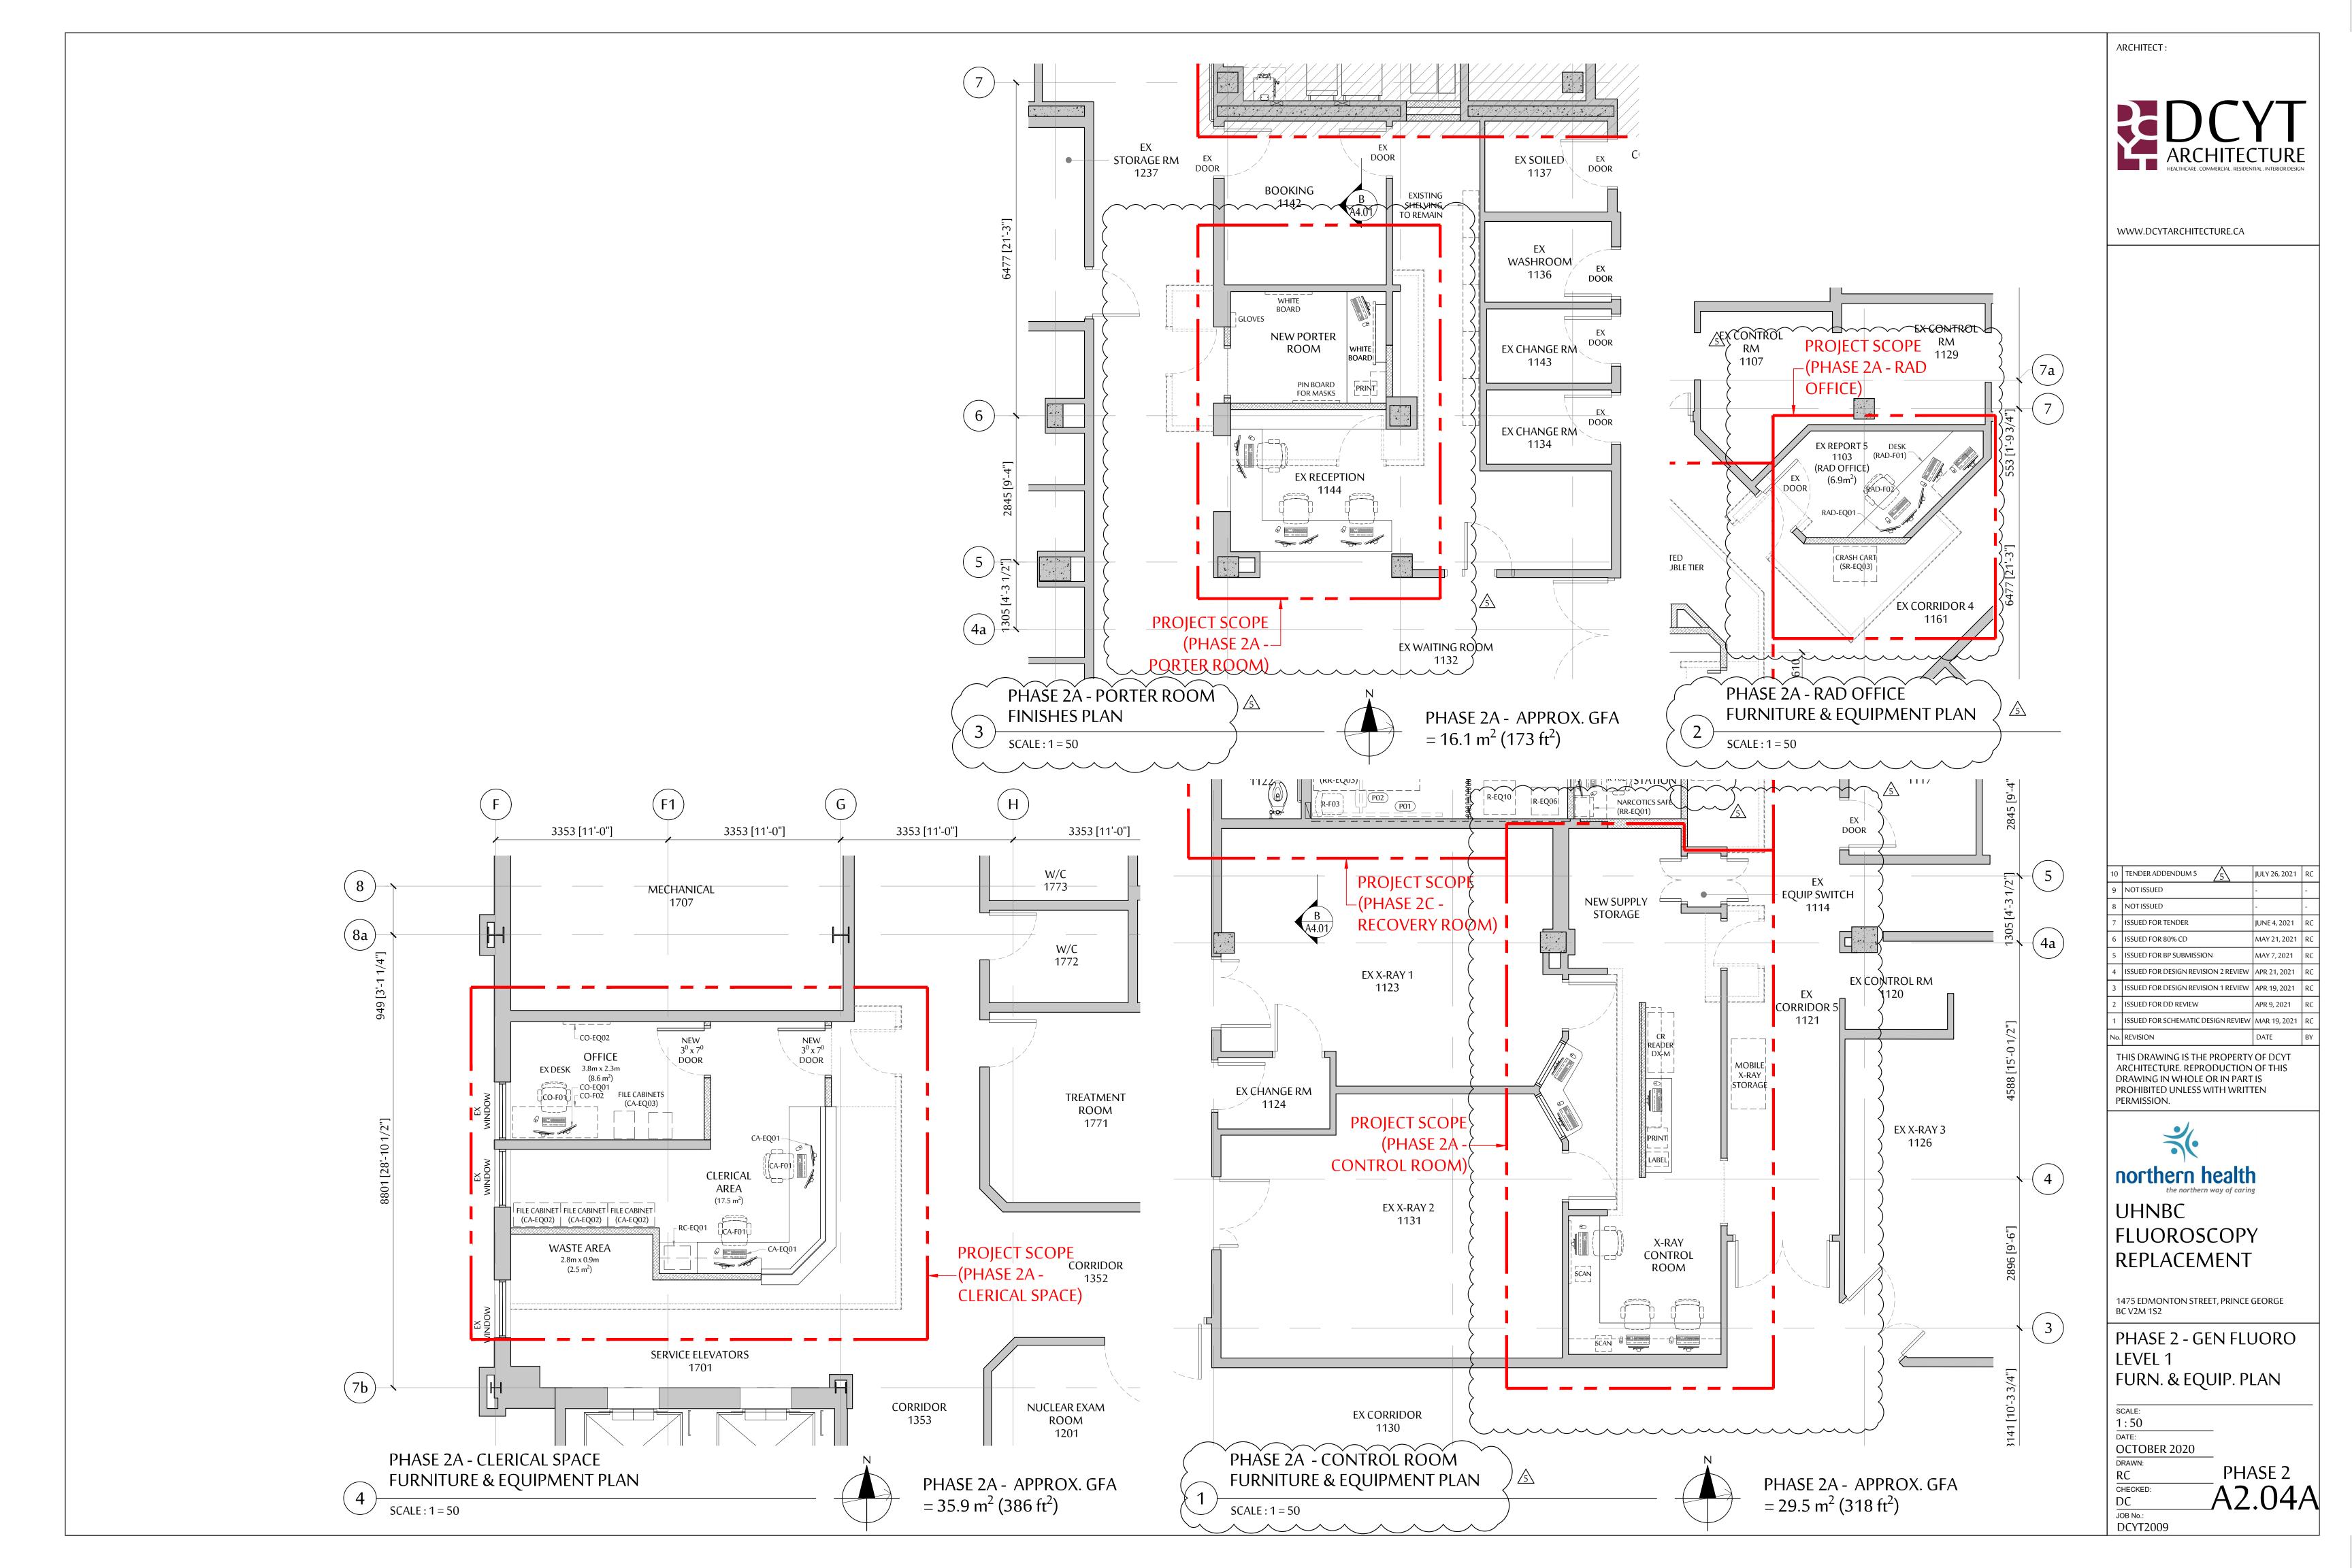

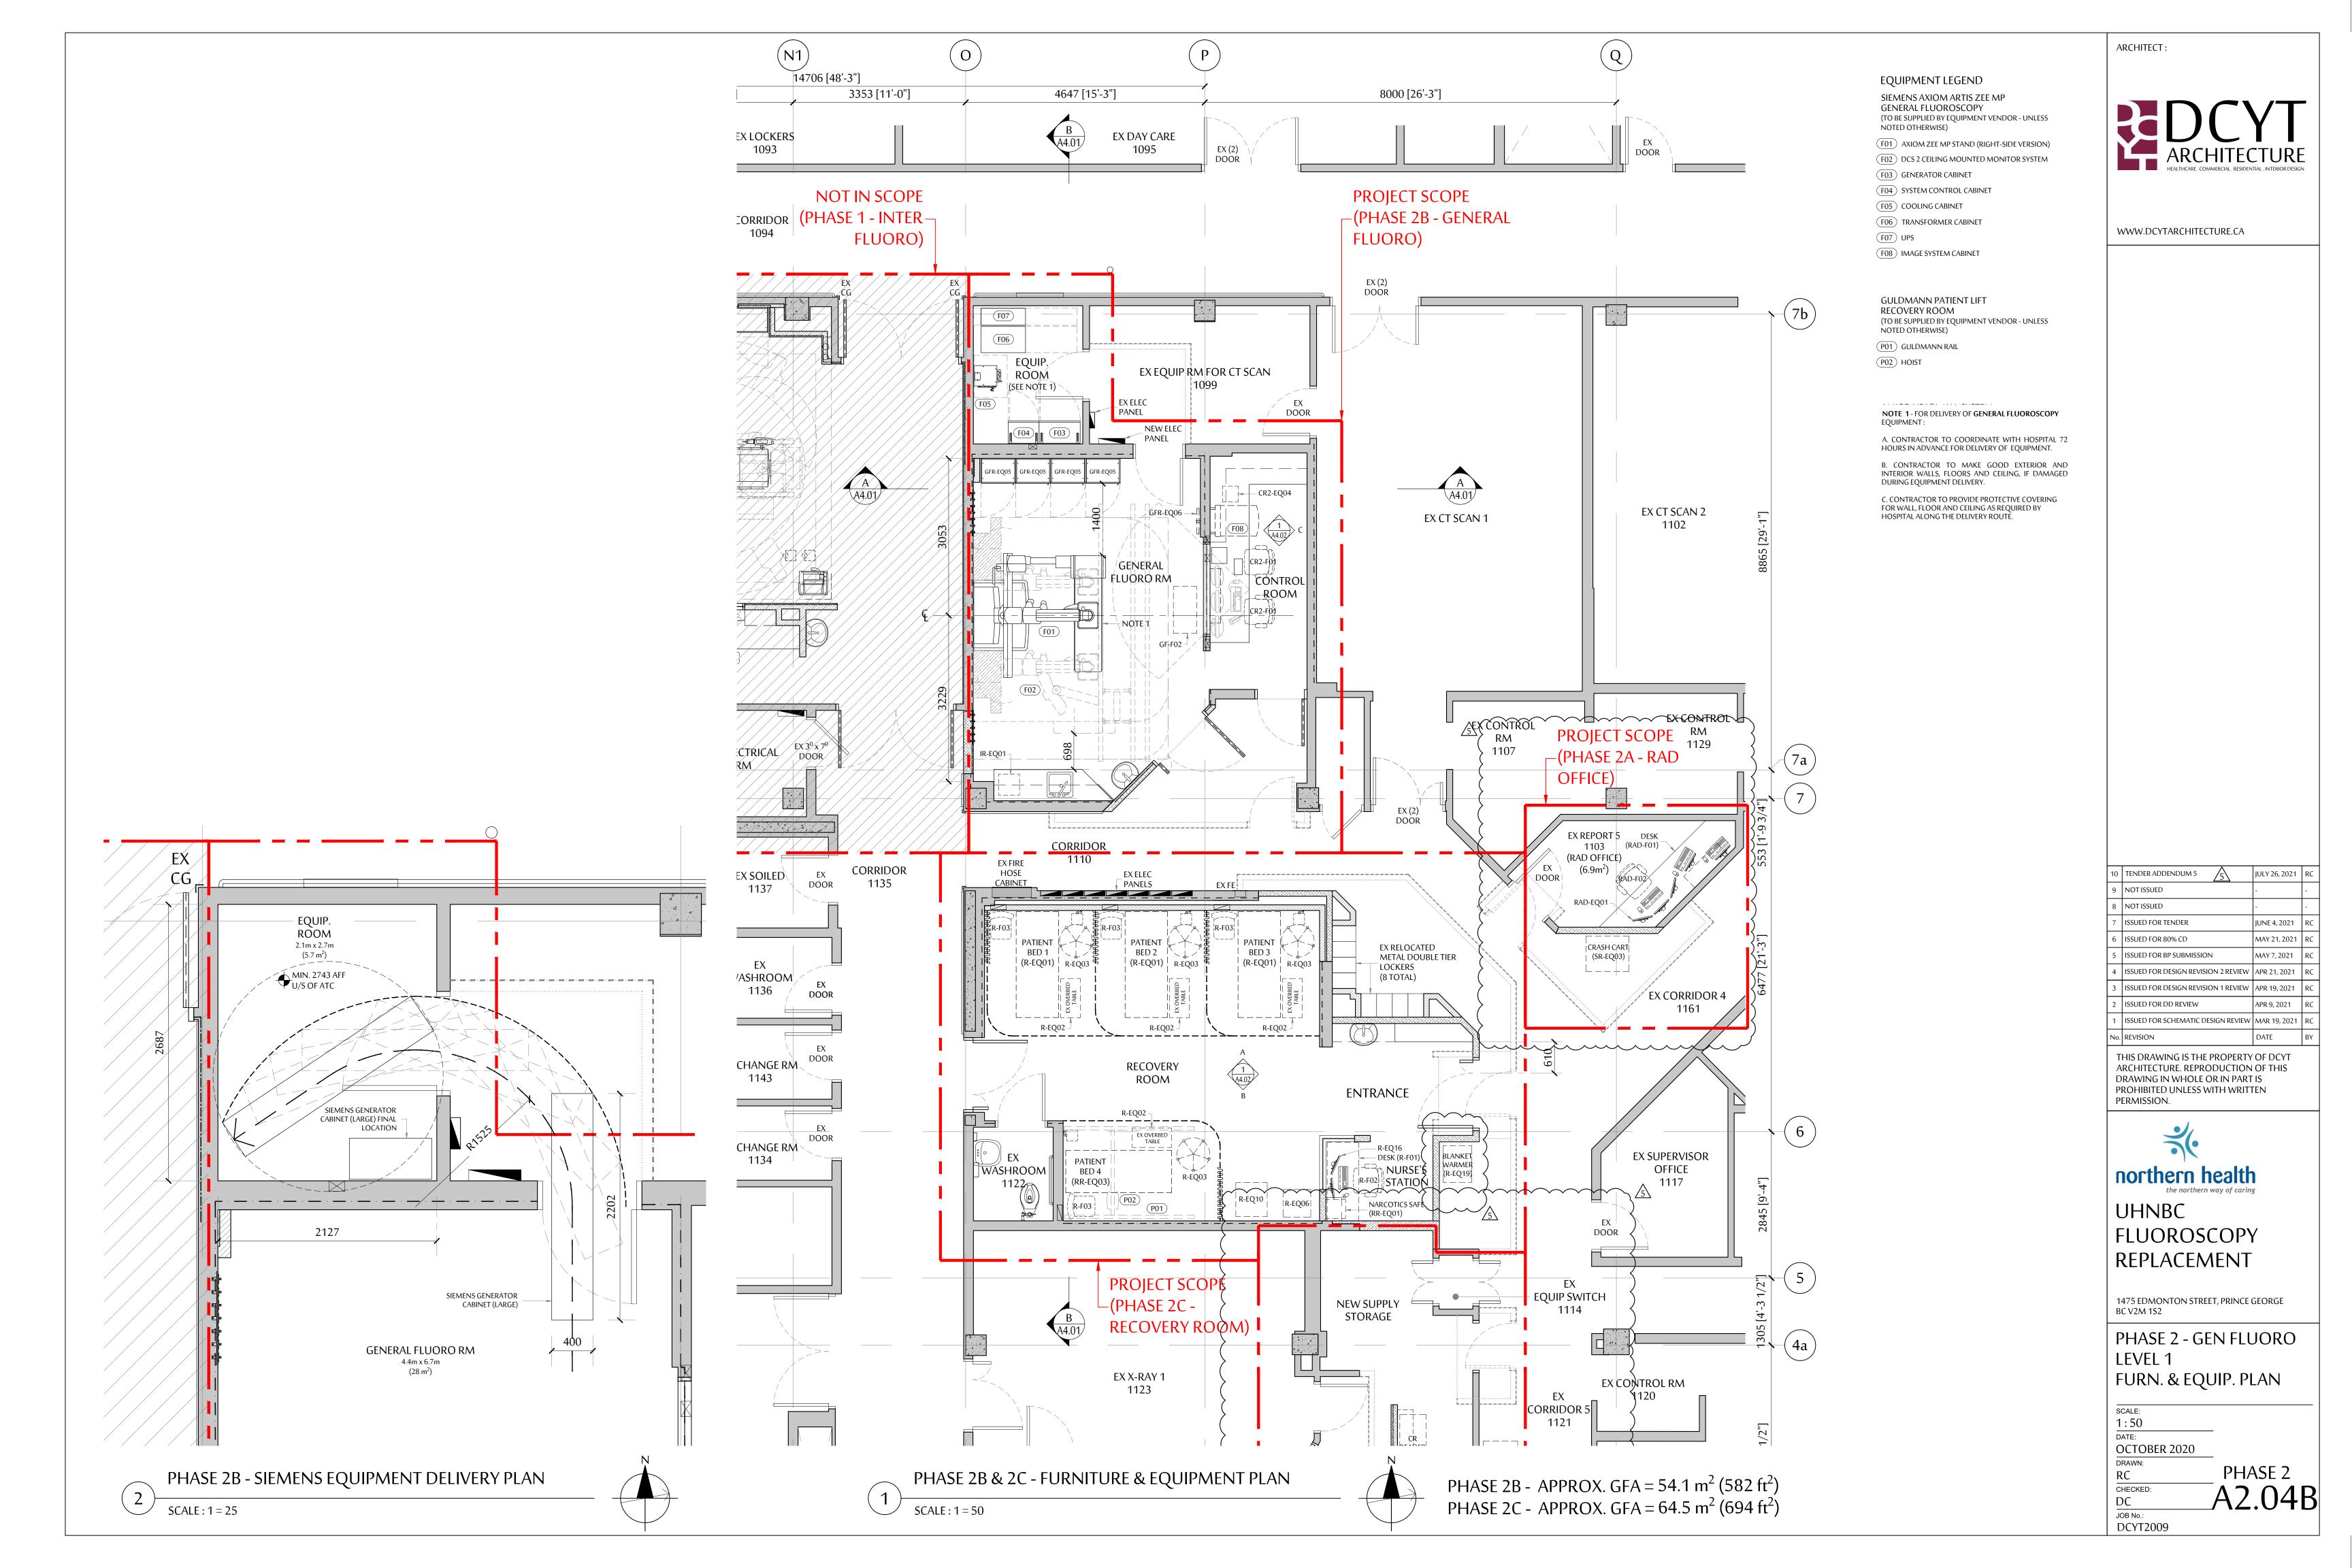


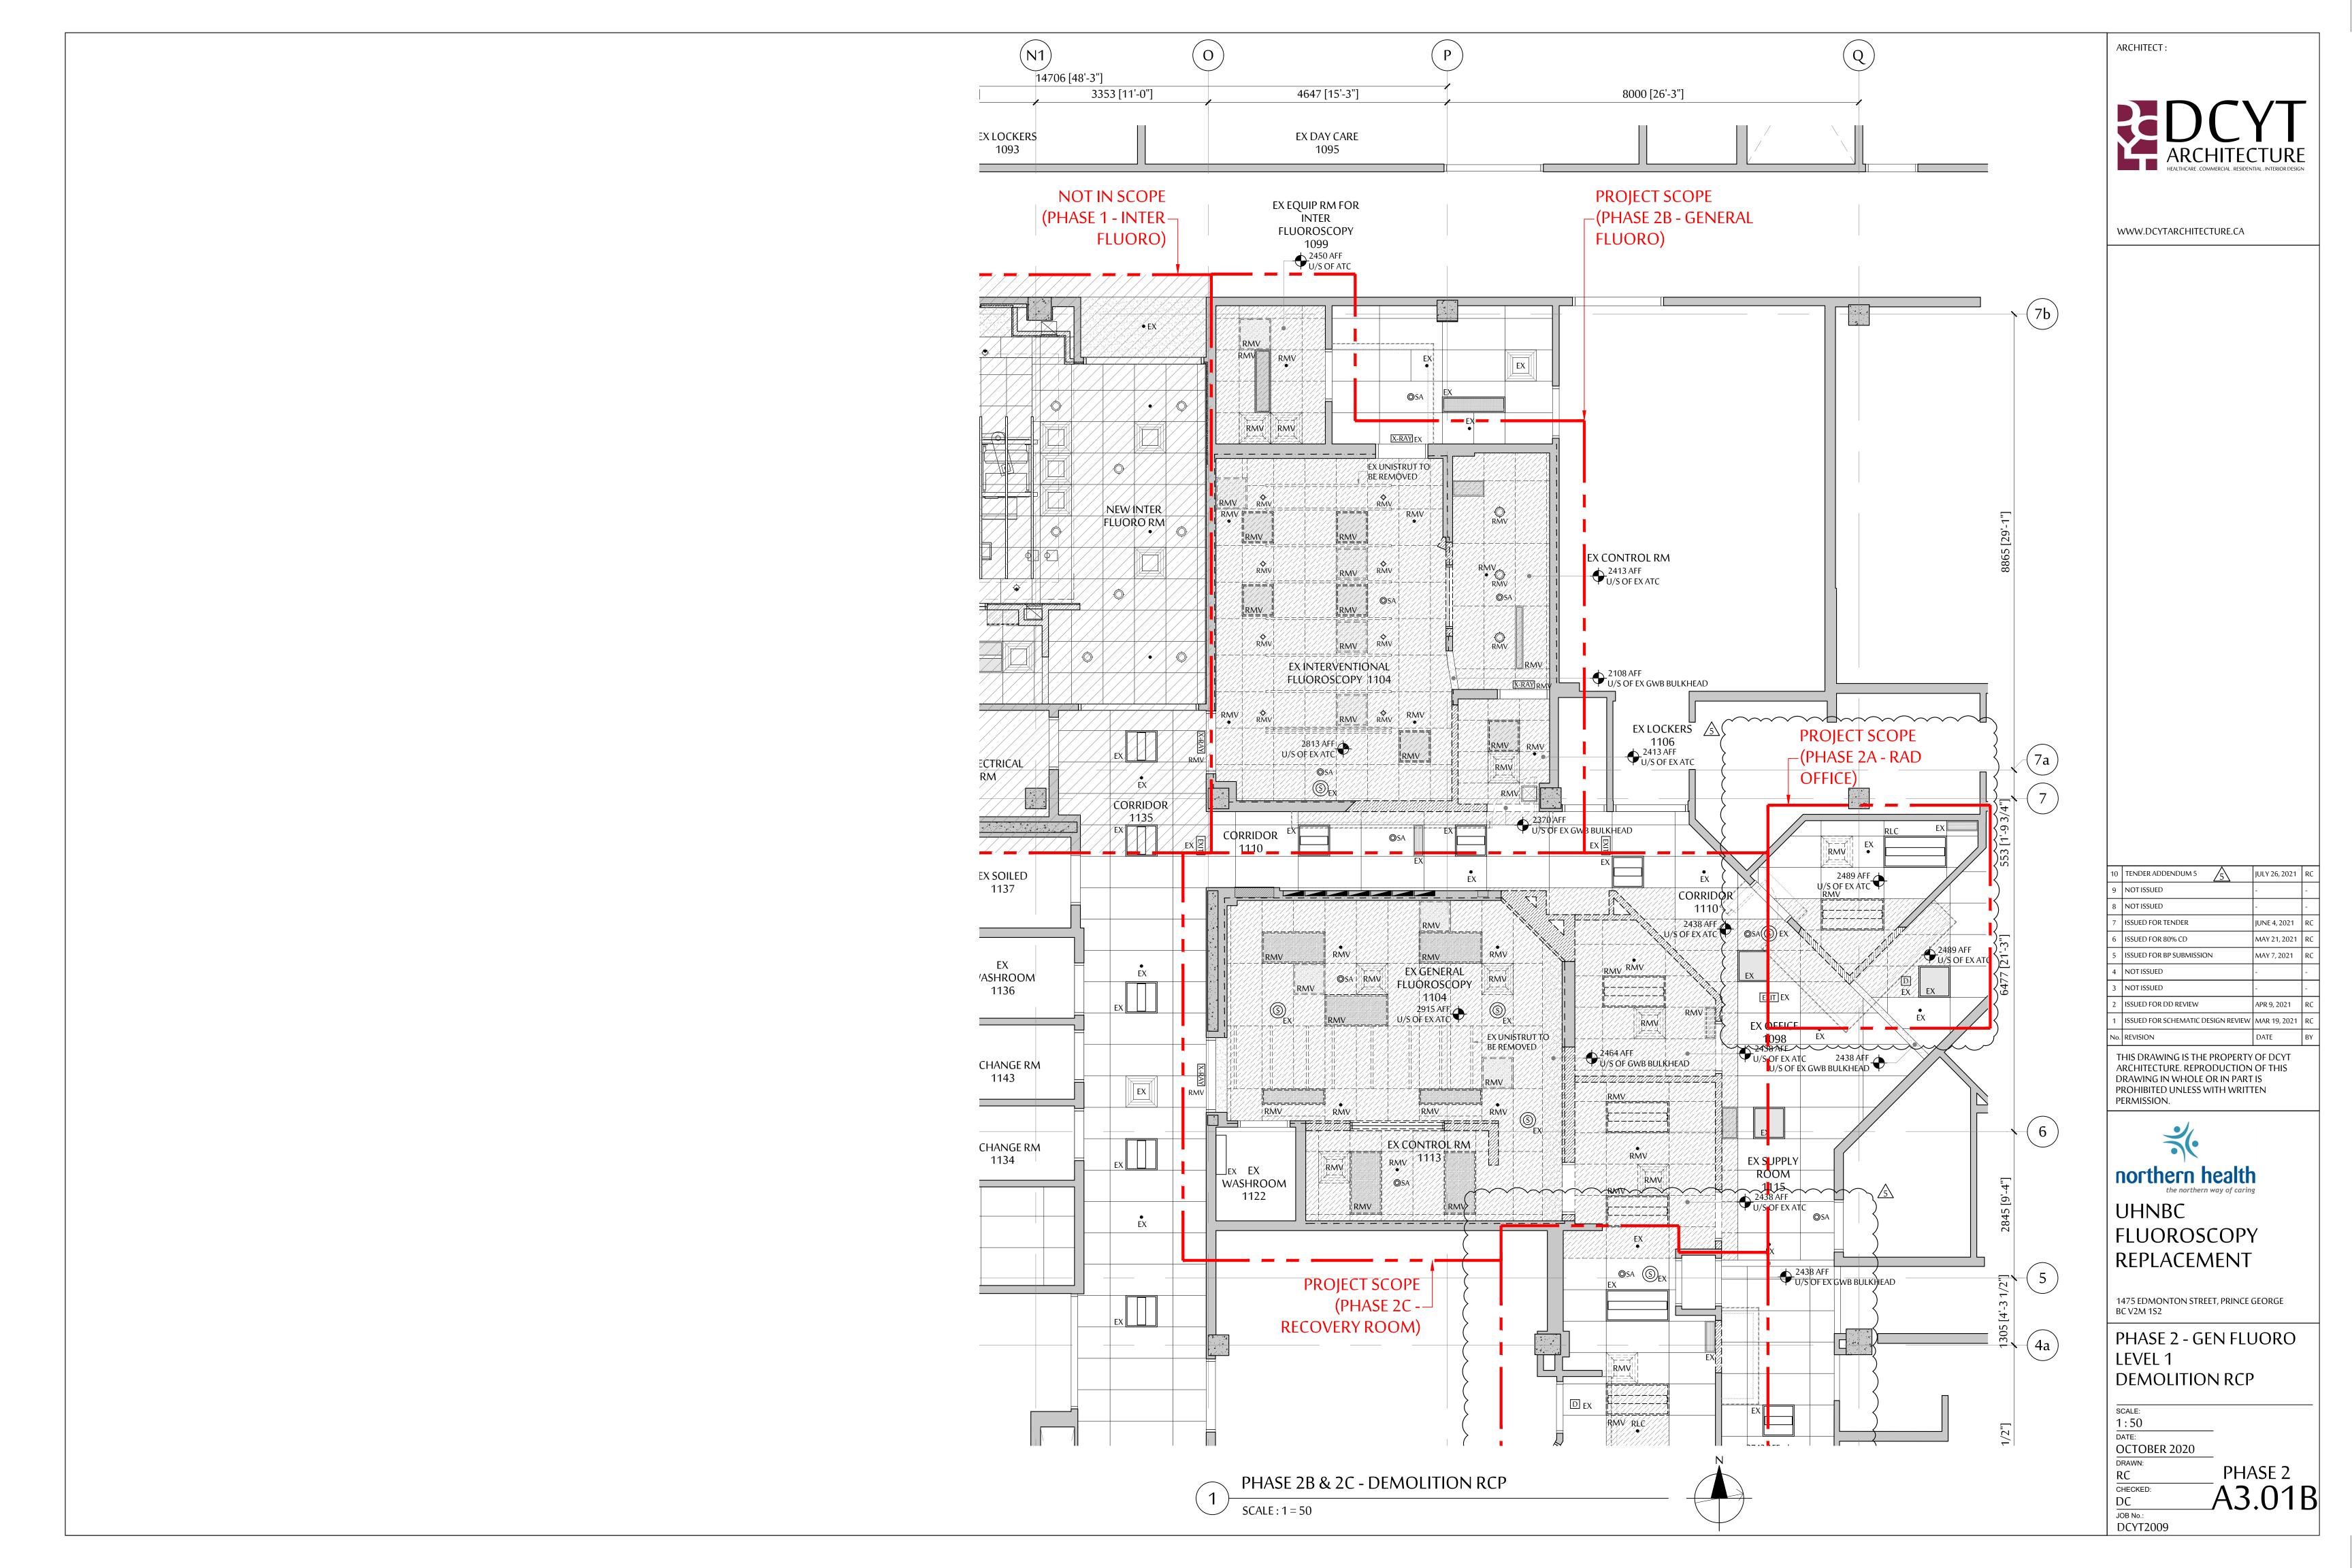

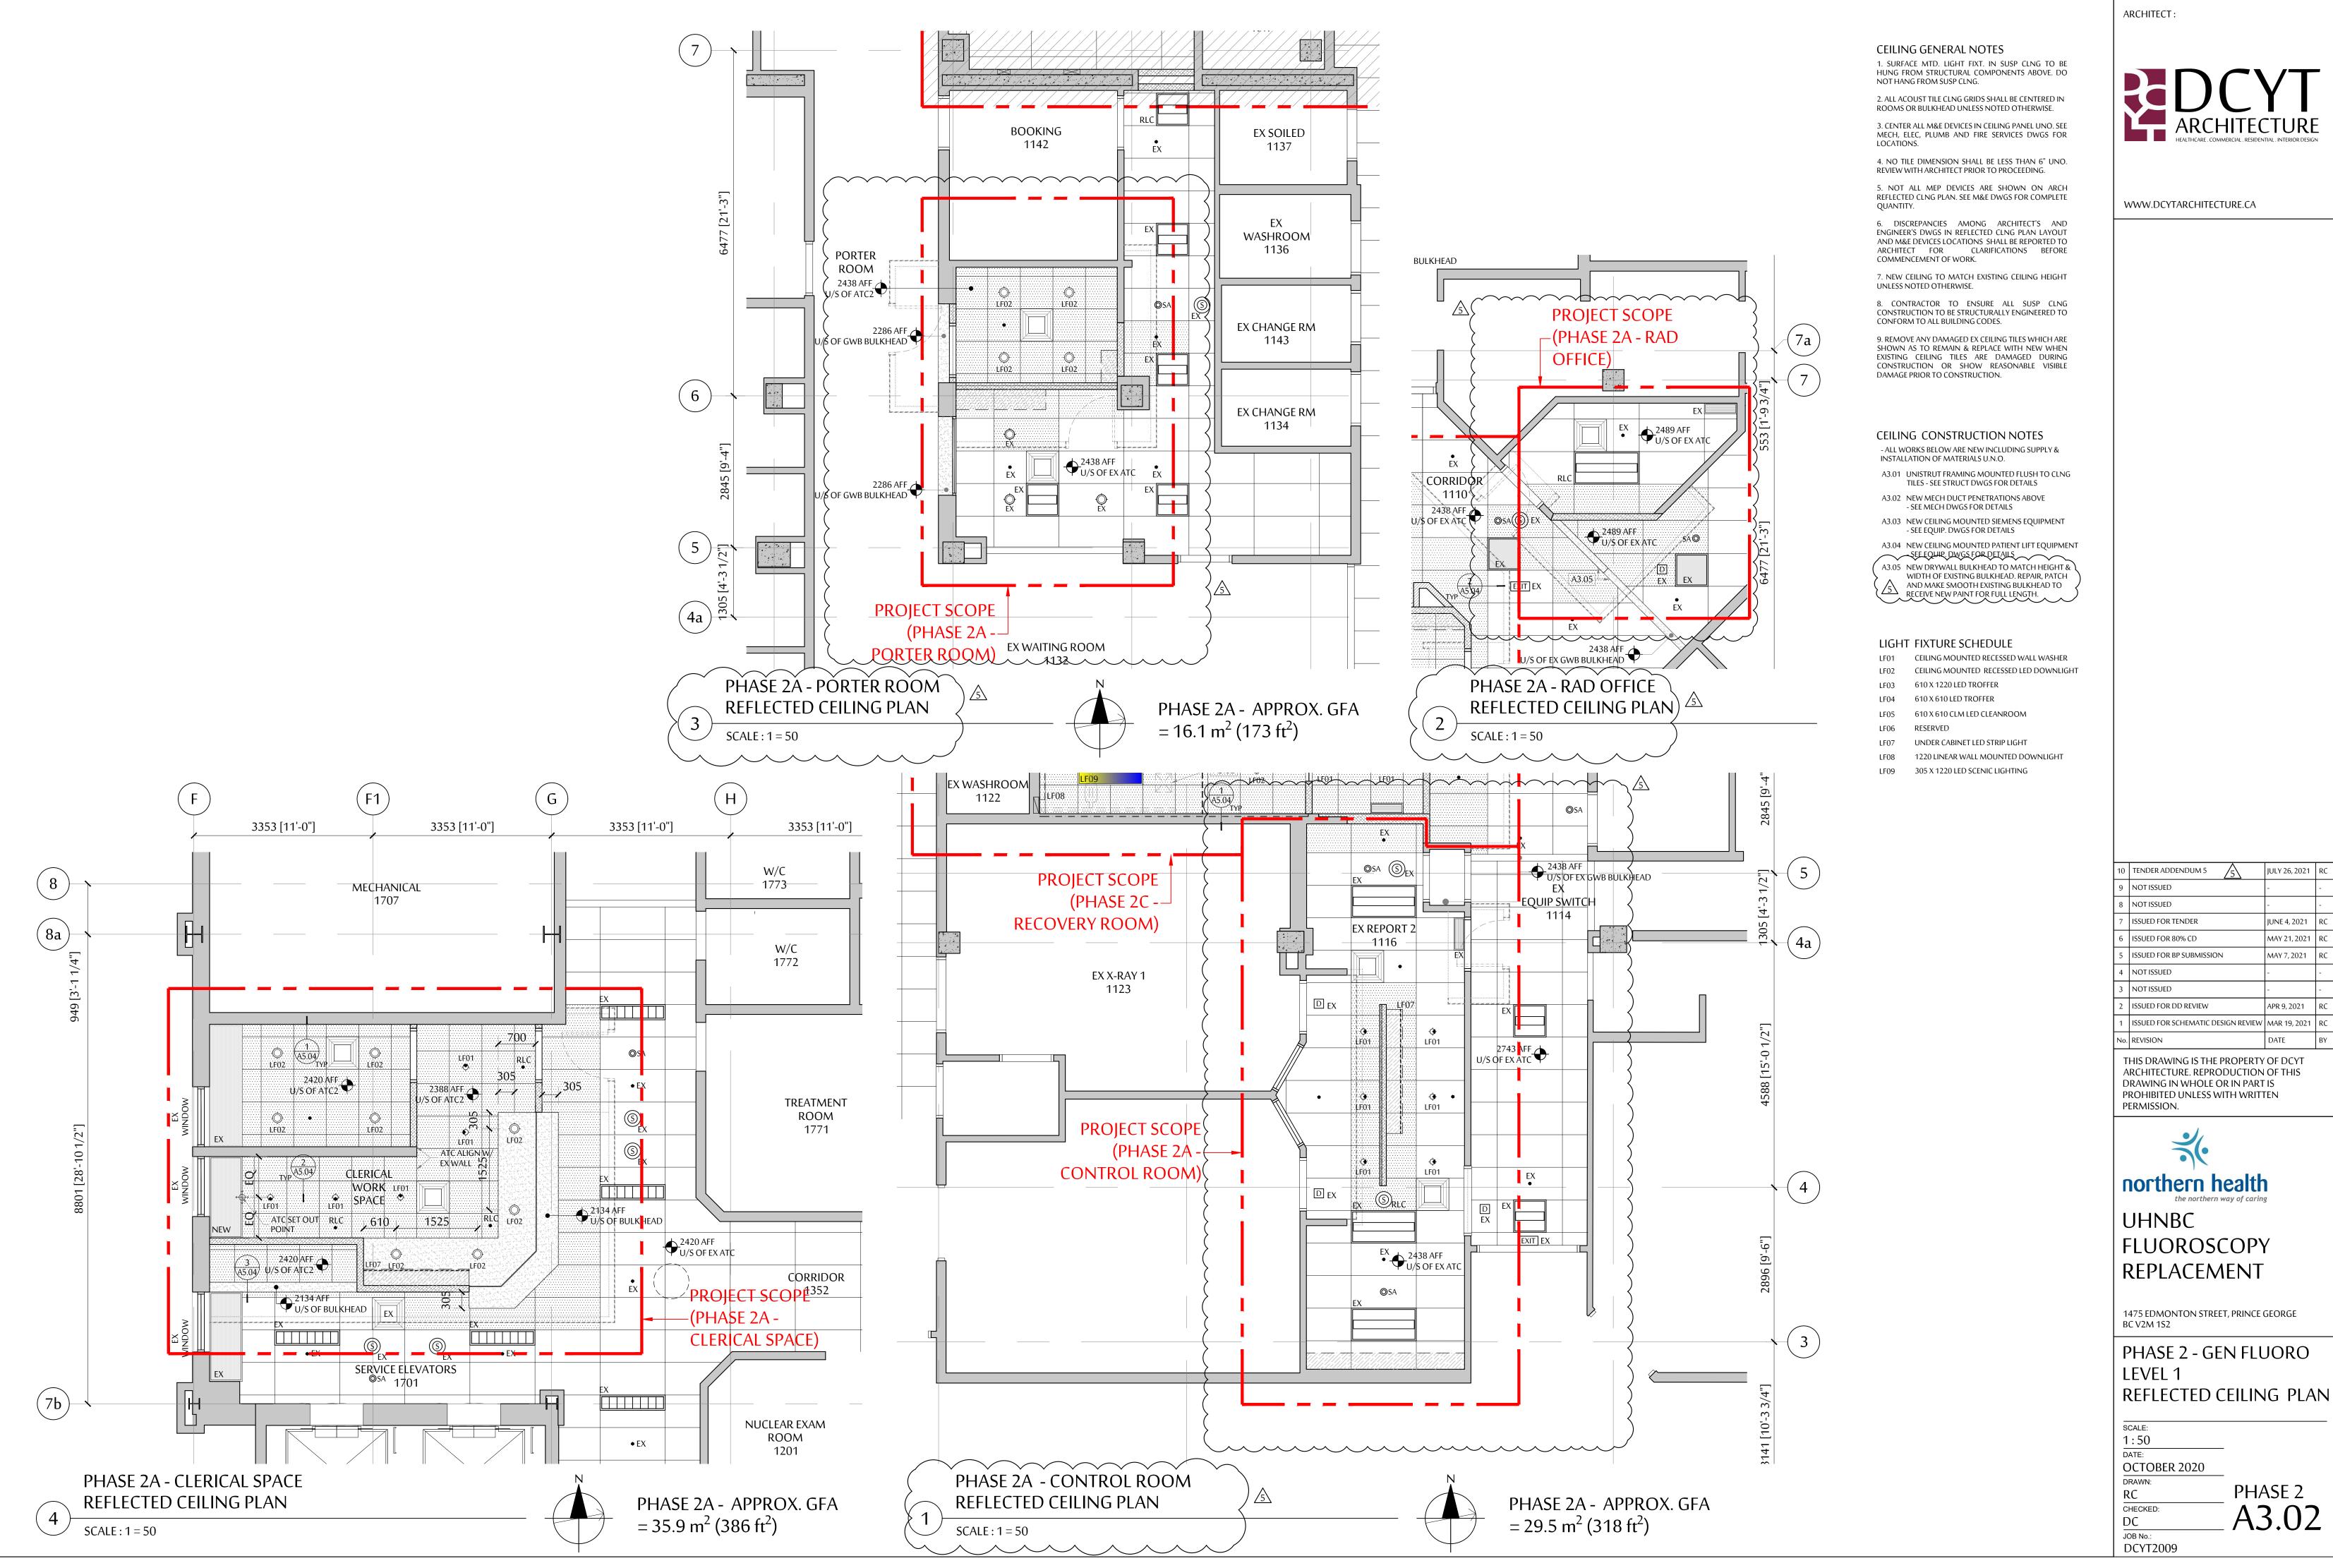





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8	NOT ISSUED	-	1
7	ISSUED FOR TENDER	JUNE 4, 2021	RC
6	ISSUED FOR 80% CD	MAY 21, 2021	RC
5	ISSUED FOR BP SUBMISSION	MAY 7, 2021	RC
4	NOT ISSUED	-	-
3	NOT ISSUED	-	-
2	ISSUED FOR DD REVIEW	APR 9, 2021	RC
1	ISSUED FOR SCHEMATIC DESIGN REVIEW	MAR 19, 2021	RC

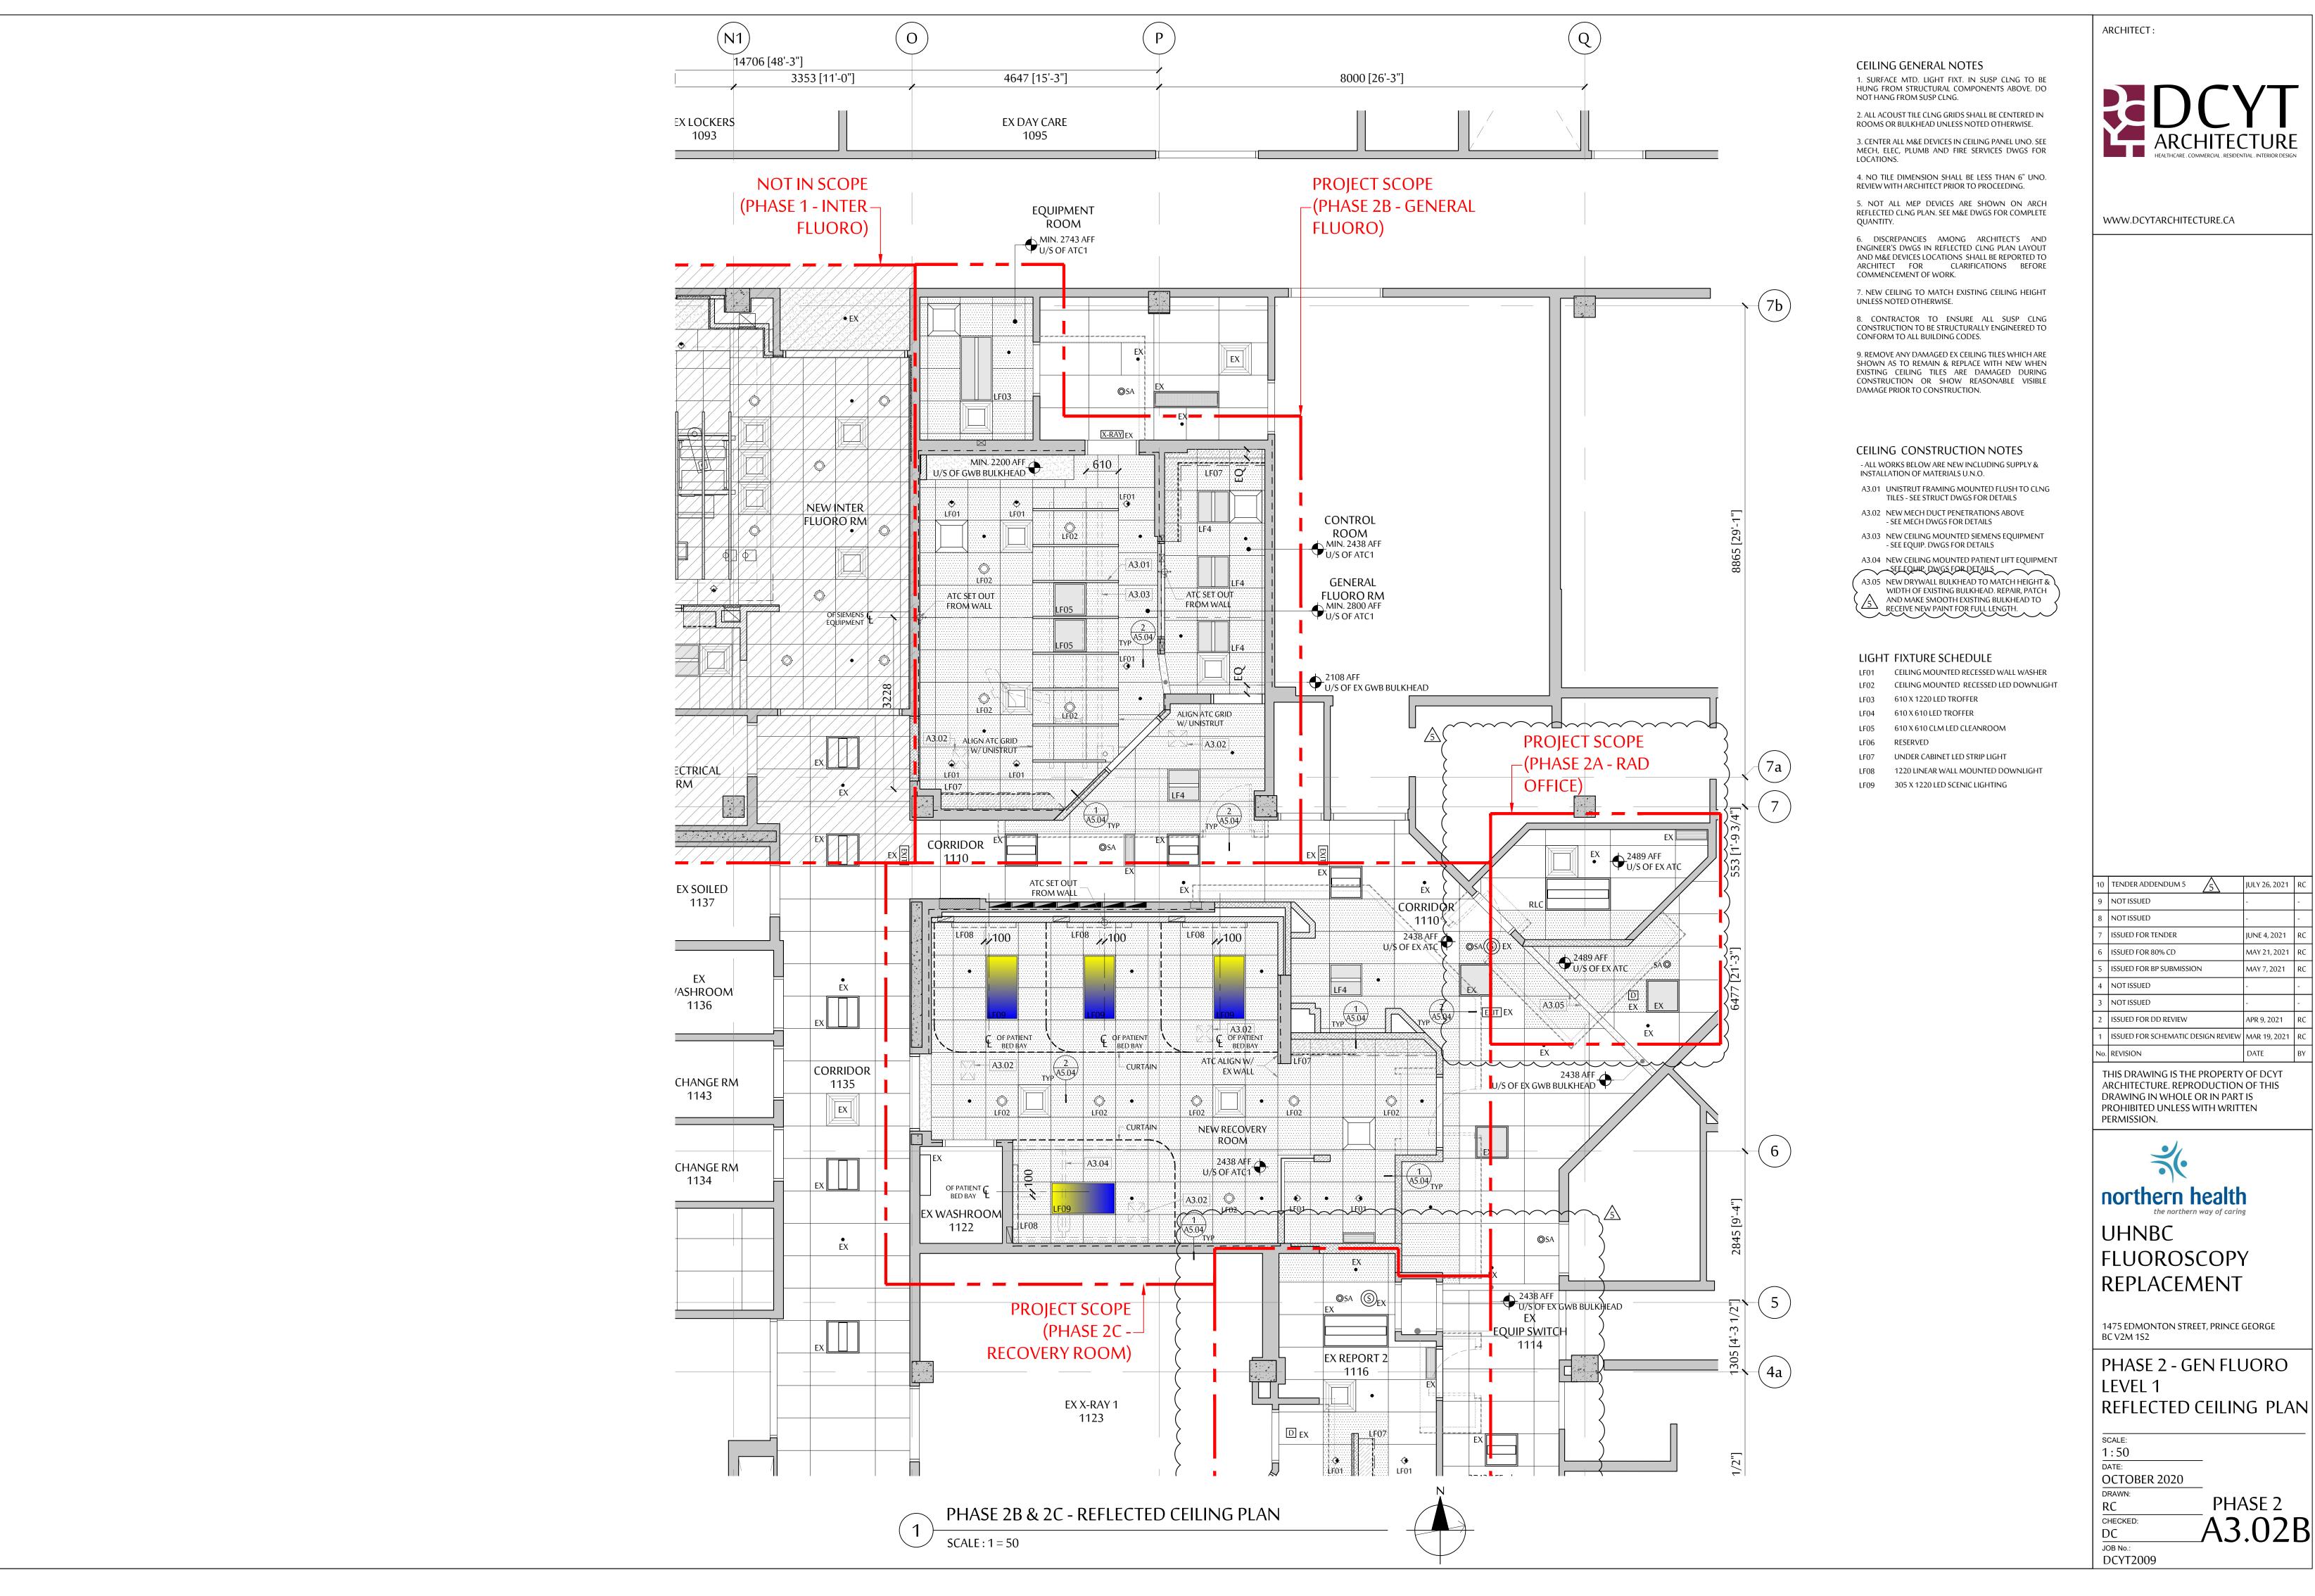

JUNE 4, 2021 RC MAY 21, 2021 RC MAY 7, 2021 RC APR 9, 2021 RC ISSUED FOR SCHEMATIC DESIGN REVIEW MAR 19, 2021 RC

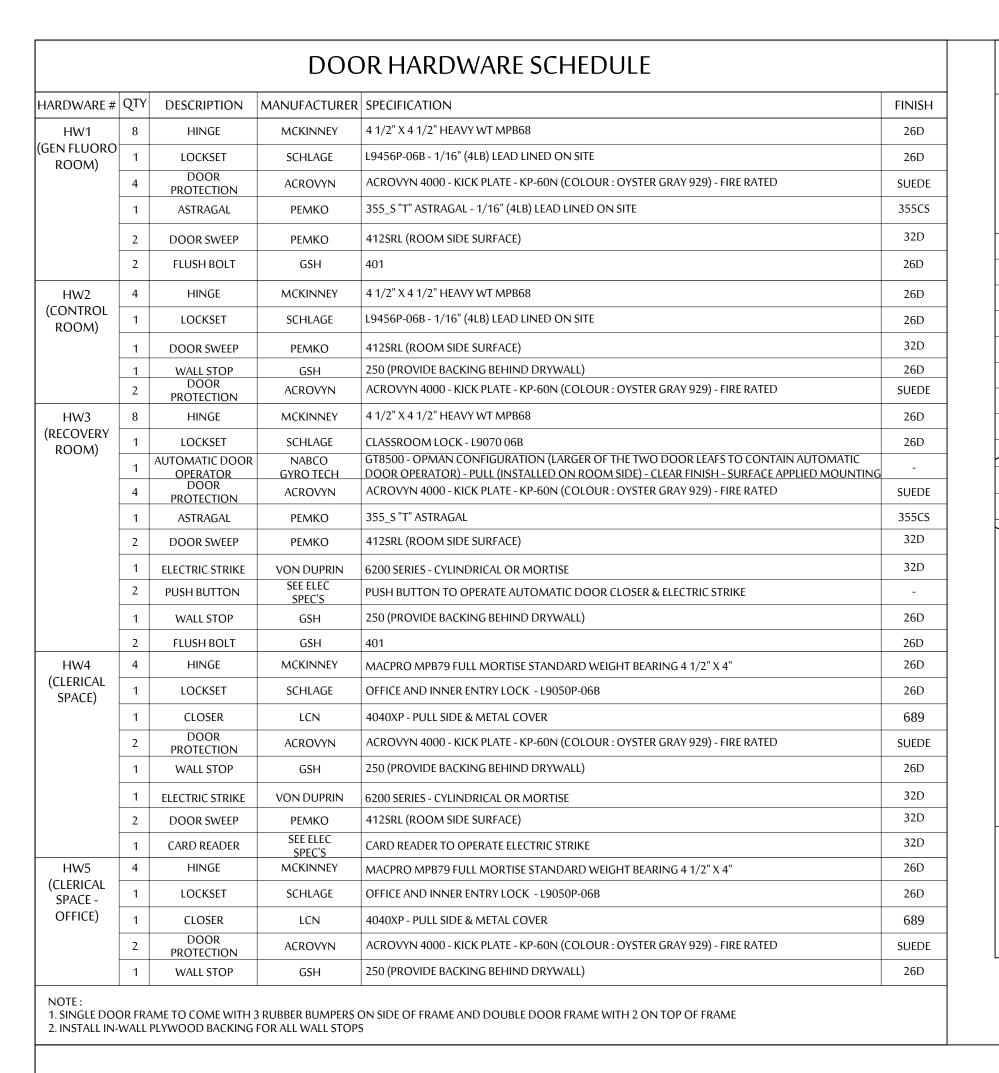

WS2 SCALE: 3" = 1'-0"

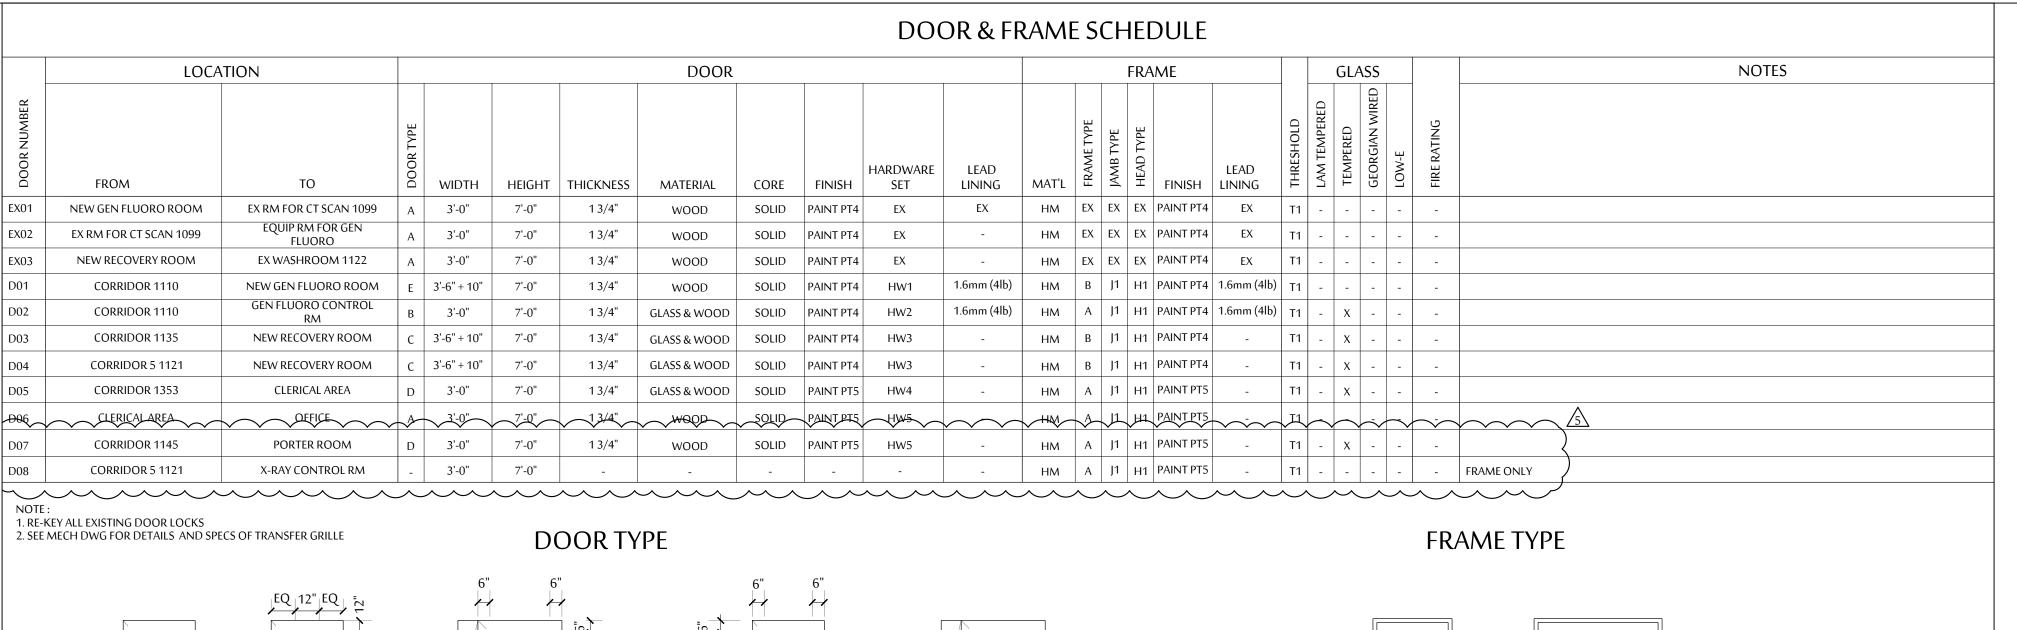


DOOR TYPE E


(DOUBLE DOOR)

DOOR

PROTECTION

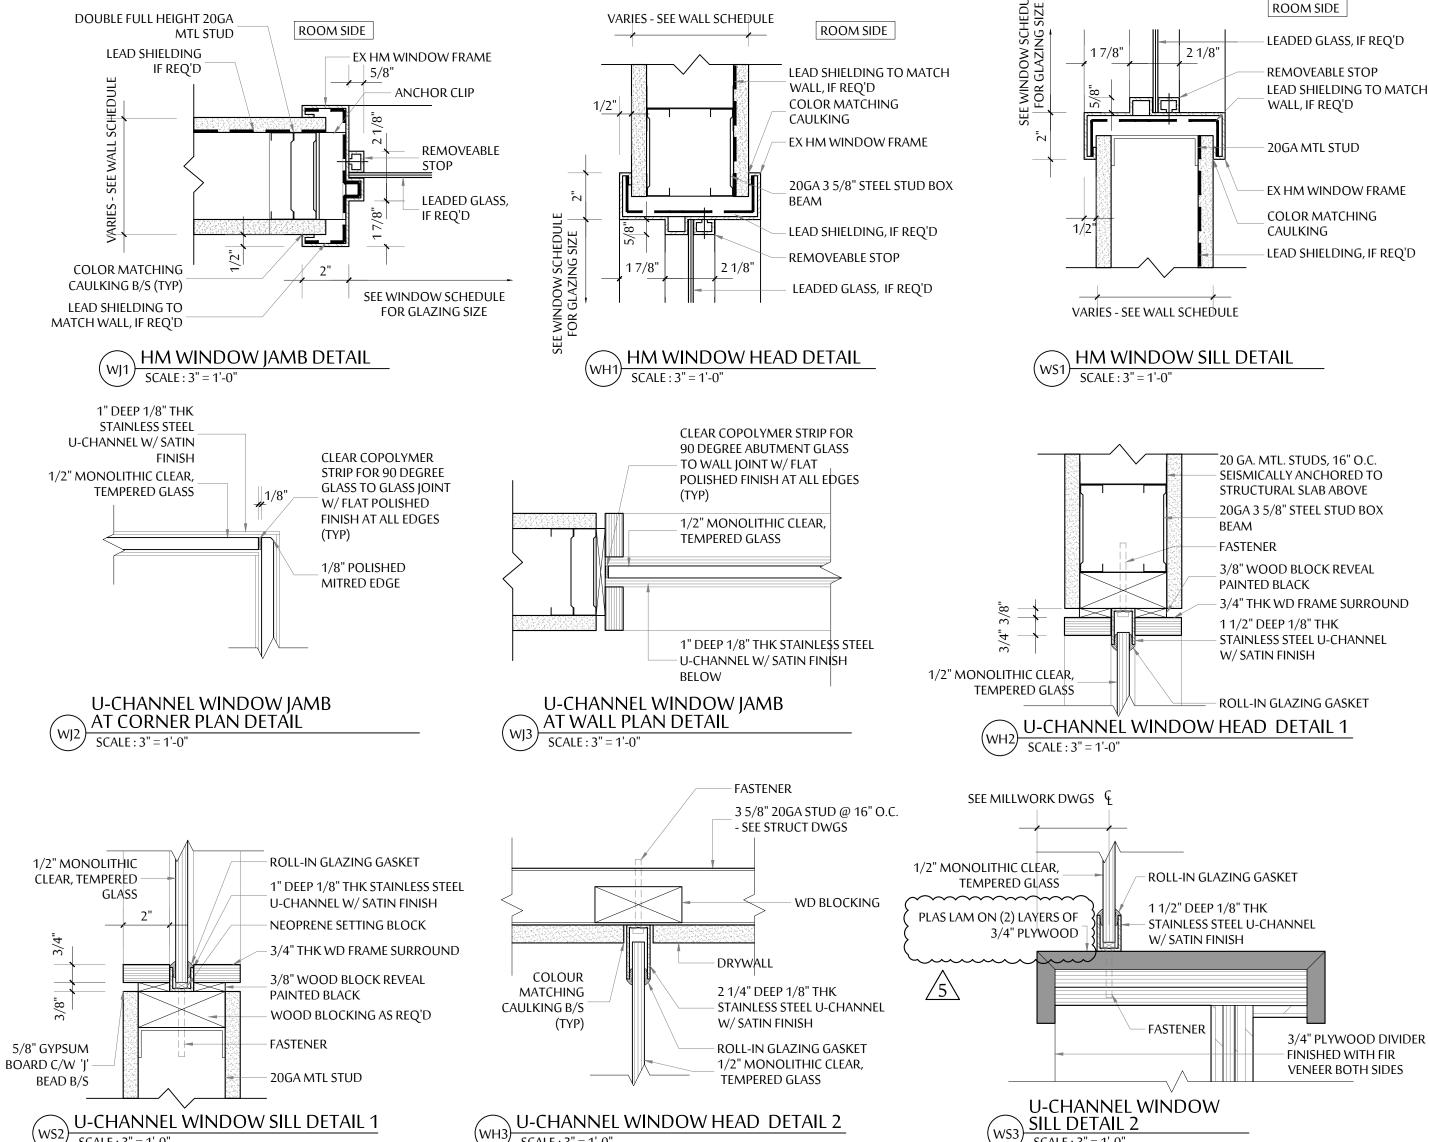

WH3) SCALE: 3" = 1'-0"

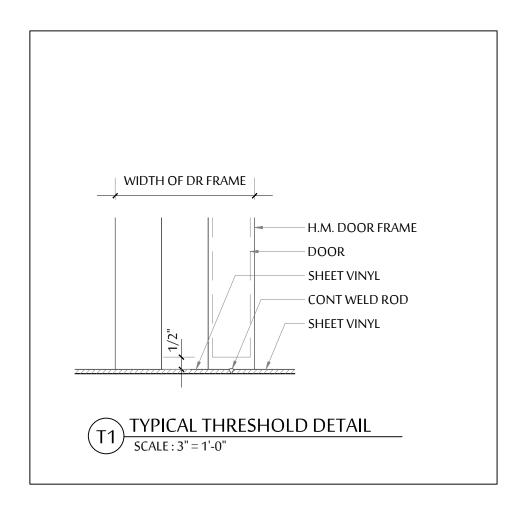

DOOR TYPE D

(WITH VISION

PANEL)

DOOR PROTECTION

DOOR TYPE C

(DOUBLE DOOR W/

VISION PANEL)

DOOR TYPE B


(SINGLE DOOR

W/VISION PANEL)

DOOR TYPE A

(SINGLE DOOR)

SCALE: 3'' = 1'-0''

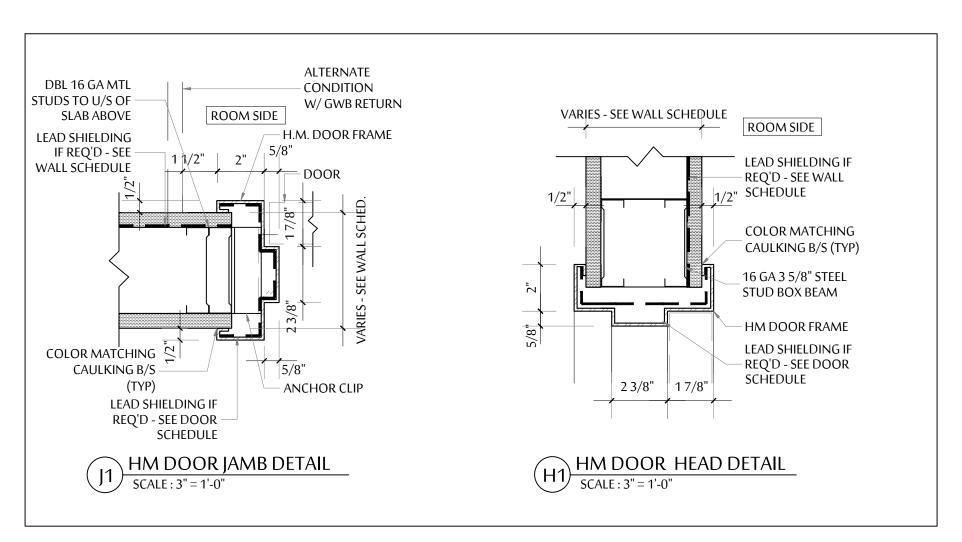


FRAME TYPE B

(DOUBLE DOOR)

FRAME TYPE A

(SINGLE DOOR)

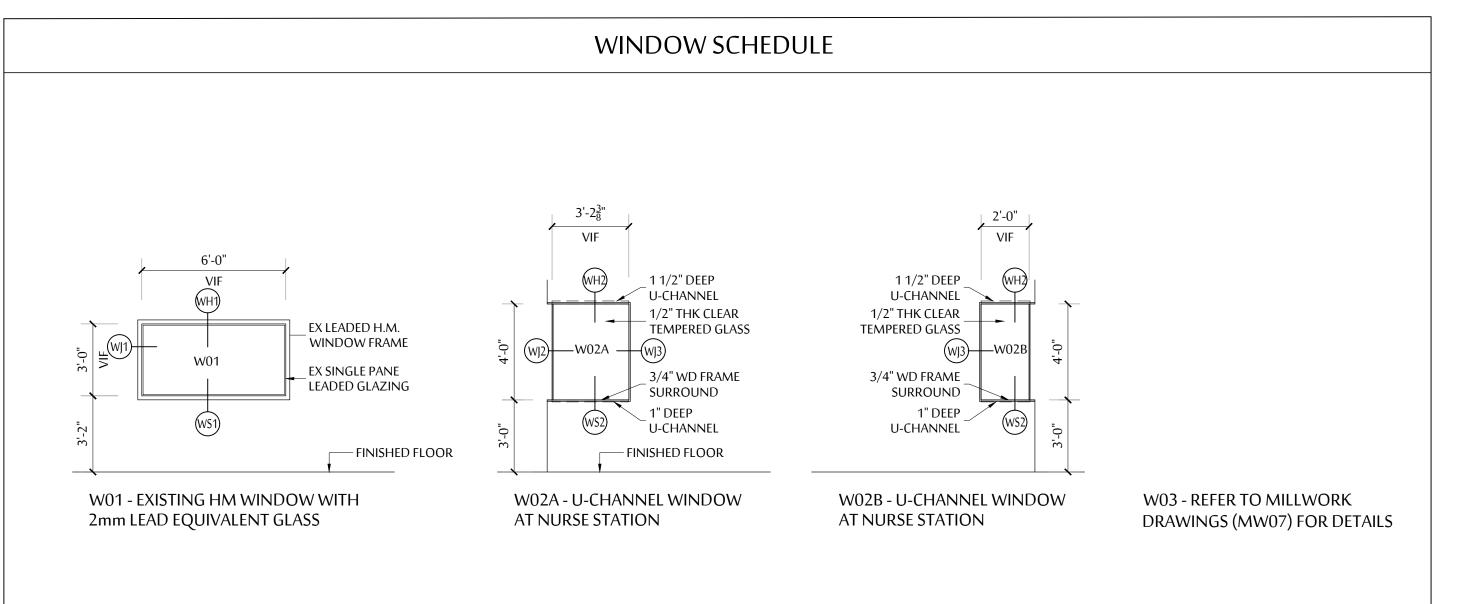

10	TENDER ADDENDUM 5 \(\frac{1}{5}\)	JULY 26, 2021	
9	NOT ISSUED	-	Ι.
8	TENDER ADDENDUM 1	JUNE 10, 2021	ı
7	ISSUED FOR TENDER	JUNE 4, 2021	ı
6	ISSUED FOR 80% CD	MAY 21, 2021	ı
5	ISSUED FOR BP SUBMISSION	MAY 7, 2021	ı
4	NOT ISSUED	-	-
3	NOT ISSUED	-	-
2	NOT ISSUED	-	-
1	NOT ISSUED	-	-
No.	REVISION	DATE	ı

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UHNBC FLUOROSCOPY REPLACEMENT

1475 EDMONTON STREET, PRINCE GEORGE BC V2M 1S2

PHASE 2 - GEN FLUORO DOOR & WINDOW SCHEDULES

SCALE:	
AS NOTED	
DATE:	_
OCTOBER 2020	
DRAWN:	- - DIIAGE
RC	PHASE
CHECKED:	$\bar{}$ Λ \Box Λ
DC	AD.
JOB No.:	· ·
DCYT2009	

LOCATION	ATION WALL (SEE NOTE 2 & 3)				FLOOR	BASE	CEILING	NOTES
ROOM NAME / RM#	NORTH	EAST	SOUTH	WEST	(SEE NOTE 1)			
GENERAL FLUORO ROOM	PAINT PT1	PAINT PT1	PAINT PT1	PAINT PT2	SHEET VINYL SV1	INTEGRAL COVE BASE SV1	SUSP CEILING ATC1	SEE DWG A2.03 FOR ACCENT WALL EXTEN
CONTROL ROOM	PAINT PT1	PAINT PT2	PAINT 1	PAINT PT1	SHEET VINYL SV1	INTEGRAL COVE BASE SV1	SUSP CEILING ATC1	SEE DWG A2.03 FOR ACCENT WALL EXTEN
EQUIPMENT ROOM	PAINT PT1	PAINT PT1	PAINT PT1	PAINT PT1	SHEET VINYL SV1	INTEGRAL COVE BASE SV1	SUSP CEILING ATC1	
CORRIDOR 1110	PAINT PT8	PAINT PT8	PAINT PT8	PAINT PT8	SHEET VINYL SV2	INTEGRAL COVE BASE SV2	MATCH EXISTING	
RECOVERY ROOM	PAINT PT2	PAINT PT1	PAINT PT2	PAINT PT1	SHEET VINYL SV1	INTEGRAL COVE BASE SV1	SUSP CEILING ATC1	SEE DWG A2.03 FOR ACCENT WALL EXTEN
CLERICAL SPACE	PAINT PT1	PAINT PT1	PAINT PT1	PAINT PT1	SHEET VINYL SV4	INTEGRAL COVE BASE SV4	SUSP CEILING ATC2	-
CLERICAL OFFICE	PAINT PT1	PAINT PT1	PAINT PT1	PAINT PT1	SHEET VINYL SV4	INTEGRAL COVE BASE SV4	SUSP CEILING ATC2	
CORRIDOR & SERVICE ELEVATOR	PAINT PT8	PAINT PT8	PAINT PT8	PAINT PT8	SHEET VINYL SV5	INTEGRAL COVE BASE SV5	MATCH EXISTING	
SUPPLY STORAGE ROOM	PAINT PT1	PAINT PT1	PAINT PT1	PAINT PT1	SHEET VINYL SV1	INTEGRAL COVE BASE SV1	MATCH EXISTING	
CONTROL ROOM	PAINT PT1	PAINT PT2	PAINT PT1	PAINT PT1	SHEET VINYL SV1	INTEGRAL COVE BASE SV1	MATCH EXISTING	SEE DWG A2.03 FOR ACCENT WALL EXTEN
RAD OFFICE	PAINT PT1	PAINT PT1	PAINT PT1	PAINT PT1	SHEET VINYL SV1	INTEGRAL COVE BASE SV1	MATCH EXISTING	
PORTER ROOM	PAINT PT2	PAINT PT1	PAINT PT1	PAINT PT1	SHEET VINYL SV1	INTEGRAL COVE BASE SV1	MATCH EXISTING	SEE DWG A2.03 FOR ACCENT WALL EXTEN

1. PATCH & SKIM COAT TO LEVEL EX FLOOR BEFORE INSTALLING SHEET VINYL FLOOR 2. ALLOW 1 ACCENT WALL PAINT COLOR - FINAL LOCATIONS TO BE DETERMINED ON SITE 3. PATCH & MAKE GOOD EX WALLS BEFORE PROVIDING NEW PAINT FINISH

4. SEE DWG 4/A5.04 FOR INTEGRAL SHEET VINYL WALL BASE DETAIL

	<u>/5</u> \						
				FINISHE	S & FIXTURES	SCHEDULE	
	DESCRIPTION	TYPE	SIZE	BRAND	MODEL	COLOR/FINISH	NOTES
PAINT	WALL - FIELD COLOR WALL - ACCENT COLOR 1	PT1 PT2	-	DULUX	LIFEMASTER (ZERO VOC) LIFEMASTER (ZERO VOC)	ENDURING ICE - DLX1102-1 EMBELLISHMENT - DLX1151-2	SHEEN: EGGSHELL SHEEN: EGGSHELL
-	WALL - ACCENT COLOR 2 (NOT USED)	PT3	-	DULUX	LIFEMASTER (ZERO VOC)		PROVIDE 3' X 3' MOCK UP OF THE ACCENT COLOR ON SITE FOR FINAL DECISION SHEEN: EGGSHELL PROVIDE 3' X 3' MOCK UP OF THE ACCENT COLOR ON SITE FOR FINAL DECISION.
	DOOR & FRAME (PHASE 2B & 2C)	PT4		DULUX	LIFEMASTER (ZERO VOC)	MOTH GRAY - DLX1024-4	PROVIDE 3' X 3' MOCK UP OF THE ACCENT COLOR ON SITE FOR FINAL DECISION SHEEN: SEMI-GLOSS
	DOOR & FRAME (PHASE 2A)	PT5	-	DULUX	LIFEMASTER (ZERO VOC)	MOTH GRAY - DLX1024-4	SHEEN: SEMI-GLOSS
	CEILING	PT6	-	DULUX	LIFEMASTER (ZERO VOC)	DELICATE WHITE - DLX1001-1	SHEEN: FLAT
<u>\$</u>	WOOD WINDOW FRAME	PT7	-	DULUX	LIFEMASTER (ZERO VOC)	ENDURING ICE - DLX1102-1	SHEEN: SEMI-GLOSS
	WALL - CORRIDOR SHEET VINYL - FIELD COLOUR	PT8	-	DULUX	LIFEMASTER (ZERO VOC)	MATCH EXISTING	SHEEN: MATCH EXISTING
LOORING ((PHASE 2A, 2B & 2C)	SV1	2mm THICK	JOHNSONITE	IQ GRANIT	770 SOFT FLEECE WB	SEE FINISHES PLAN DWG A2.03 FOR EXTENT C/W 6" H INTEGRAL COVE BASE SEE FINISHES PLAN DWG A2.03 FOR EXTENT
	SHEET VINYL - CORRIDOR BORDER INFILL (PHASE 2B & 2C) SHEET VINYL - EX REPORT 2		2mm THICK	MATCH EXISTING	MATCH EXISTING	MATCH EXISTING	C/W INTEGRAL COVE BASE TO MATCH EXISTING HEIGHT SEE FINISHES PLAN DWG A2.03 FOR EXTENT
_	1116 (PHASE 2C) SHEET VINYL - FIELD COLOUR	SV3	2mm THICK	MATCH EXISTING	MATCH EXISTING	MATCH EXISTING	C/W INTEGRAL COVE BASE TO MATCH EXISTING HEIGHT SEE FINISHES PLAN DWG A2.03 FOR EXTENT
\$	(PHASE 2A) SHEET VINYL - CORRIDOR	SV4	2mm THICK 2mm THICK	JOHNSONITE MATCHEXISTING	IQ GRANIT MATCHEXISTING	445 VINTAGE MATCHEXISTING	C/W 6" H INTEGRAL COVE BASE SEE FINISHES PLAN DWG A2.03 FOR EXTENT
	SORVER MFILM (PHASE 2A) SHEET VINYL - RECEPTION FIELD COLUMN (PLASE 2A)	SV6	2mm THICK	MATCH EXISTING	MATCH EXISTING	MATCH EXISTING	C/WINTEGRAMOVE BASE TO MAYOM EXISTING HEIGHT SEE FINISHES PLAN DWG A2.03 FOR EXTENT CAMINITECRAL COVERAGE TO MATCH EXISTING HEIGHT
MILLWORK	FIELD COLOUR (PHASE 2A) PLAS LAM-BASE CABINET	-R11		NEVAMAR \	HIGH PRESSURE LAMINTE	GRARHITE PLUE 58023-T	C/W INTEGRAL COVE BASE TO MATCH EXISTING HEIGHT FIMISH: ARP (T-)
-	PLAS LAM-UPPER CABINET	PL2	-	NEVAMAR	THRUCOLOR	CHALK WHITE S7024-T	FINISH: ARP (T-)
	PLAS LAM-COUNTER TOP	PL3	-	NEVAMAR	THRUCOLOR	GARDEN MIST SG0004-T	FINISH: ARP (T-)
	PLAS LAM-BASE CABINET	PL4	-	NEVAMAR	THRUCOLOR	DRY CREEK PLUM TREE WZ6001	FINISH: ARP (T-)
	PLAS LAM-UPPER CABINET	PL5	-	NEVAMAR	THRUCOLOR	CHALK WHITE \$7024-T	FINISH: ARP (T-)
-	PLAS LAM-COUNTER TOP SOLID SURFACING	PL6		NEVAMAR	THRUCOLOR	WILD OATS MATRIX MR7002	FINISH: ARP (T-)
	COUNTERTOP (NOT USED)	SC1	1/2" THICK	DUPONT CORIAN	-	-	-
	DOOR HANDLE	DH1	-	RICHELIEU	1076CV	CHROME	-
WALL PROTECTION	CORNER GUARD 90 DEG	CG1a	3" LEG	C/S ACROVYN 4000	SM-20N	#934 PEARL	SEE DWG A2.03 FOR HEIGHT & LOCATION
_	CORNER GUARD 90 DEG CORNER GUARD 90 DEG	CG1b CG1c	3" LEG 3" LEG	C/S ACROVYN 4000	SM-20N SM-20N	MATCH CORRIDOR WALL #934 PEARL	SEE DWG A2.03 FOR HEIGHT & LOCATION SEE DWG A2.03 FOR HEIGHT & LOCATION
_	CORNER GUARD 135 DEG	CG2	3" LEG	C/S ACROVYN 4000	SM-20MN	MATCH CORRIDOR WALL	SEE DWG A2.03 FOR HEIGHT & LOCATION
_	CRASH RAIL	CR1	8" H	C/S ACROVYN	SCR-80	#934 PEARL	ALUMINUM CLIP, SURFACE MOUNTED
-	CRASH RAIL	CR2	5" H	C/S ACROVYN	SCR-50	#934 PEARL	ALUMINUM CLIP, SURFACE MOUNTED
	CRASH RAIL	CR3	MATCH EX	C/S ACROVYN	MATCH EX	MATCH EX	ALUMINUM CLIP, SURFACE MOUNTED
-	WALL PROTECTION	WP1	0.06" THK	C/S ACROVYN 4000		#934 PEARL	COMPLETE WITH COLOUR MATCHING CAULKING AT BUTT JOINT & WAINSCOT TRIM ON EXPOSED TOP & SIDES
	WALL PROTECTION	WP2	0.09" THK	PANOLAM	FRP	WHITE (CLASSIC COLLECTION) SMOOTH (SURFACE TEXTURE)	COMPLETE WITH COLOUR MATCHING CAULKING AT BUTT JOINT & WAINSCOT TRIM ON EXPOSED TOP & SIDES
	WALL PROTECTION	WP3	0.06" THK	C/S ACROVYN 4000	-	MATCH EX	COMPLETE WITH COLOUR MATCHING CAULKING AT BUTT JOINT & WAINSCOT TRIM ON EXPOSED TOP & SIDES. MATCH EXISTING HEIGHT
CEILING	SUSPENDED T-BAR	ATC1	15/16"	ARMSTRONG	15/16" CLEAN ROOM ALUMINUM	WHITE	-
	ACOUSTIC CEILING PANEL	ЛІСІ	24" X 24"	ARMSTRONG	ULTIMA HEALTH ZONE HIGH NRC	WHITE	SQUARE LAY-IN PANELS NRC : 0.80 / CAC : 35
	SUSPENDED T-BAR	ATC2	15/16"	ARMSTRONG	PRELUDE XL 15/16" EXPOSED TEE	WHITE	-
	ACOUSTIC CEILING PANEL	-	24" X 24"	ARMSTRONG	ULTIMA HIGH NRC SQUARE LAY-IN	WHITE	SQUARE LAY-IN PANELS NRC: 0.80 / CAC: 35
PATIENT BAY CURTAIN -	CURTAIN	CU1	TBD	TBD	TBD	TBD	PURCHASED BY OWNER AND INSTALLED BY VENDOR.
	CURTAIN TRACK	CT1	TBD	TBD	TBD	TBD	PURCHASED BY OWNER AND INSTALLED BY VENDOR.
GLAZING PARTITION	TRANSLUCENT FILM	TF1	-	3M	FASARA	MILKY MILKY SH2MAMM	SEE MILLWORK FOR DIMENSIONS AND LOCATION
MISCELLANEOUS	LEAD APRON HOOK	AH1	-	BOBRICK	HEAVY-DUTY CLOTHES HOOK B-2116 ROLLBOARD WALL	SATIN NICKEL-PLATED FINISH	COMPLETE WITH CONCEALED MOUNTING PROVIDE BACKING AS REQUIRED; SEE PLAN & ELEVATIONS FOR TOTAL NUMBER
_	ROLLBOARD HOOK	RH1	-	SAMARIT	MOUNT MOUNT	WHITE	PROVIDE BACKING AS REQUIRED
	UNDER DESK CABLE TRAY ORGANIZER	CTO1	23.6" W	PROGRESSIVE DESK	D0-06-BLACK	BLACK POWDER COATED STEEL	MOUNT TO UNDERSIDE OF DESK
	SPEAK-THRU	ST1	5" DIAM.	CRL	TTU1DJB1	SATIN ANODIZED	THRU-GLASS TWO-WAY ELECTRONIC COMMUNICATOR 115V AC MODEL
	HEADWALL SYSTEM	RR-EQ04	4' LONG	AMICO	MAJESTIC SERIES	TBD	MAJESTIC SERIES HORIZONTAL HEADWALL SYSTEM - SINGLE TIER - NO CHASE SEE DWG A4.02 FOR LOCATION, INSTALLATION HEIGHT AND DESIGN PROVIDE IN WALL BACKING AS RECOMMENDED BY MANUFACTURER

ARCHITECT:



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10	TENDER ADDENDUM 5	JULY 26, 2021	RC
9	TENDER ADDENDUM 2	JUNE 16, 2021	RC
8	TENDER ADDENDUM 1	JUNE 10, 2021	RC
7	ISSUED FOR TENDER	JUNE 4, 2021	RC
6	NOT ISSUED	1	-
5	NOT ISSUED	-	-
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3	NOT ISSUED	-	-
2	NOT ISSUED	-	-
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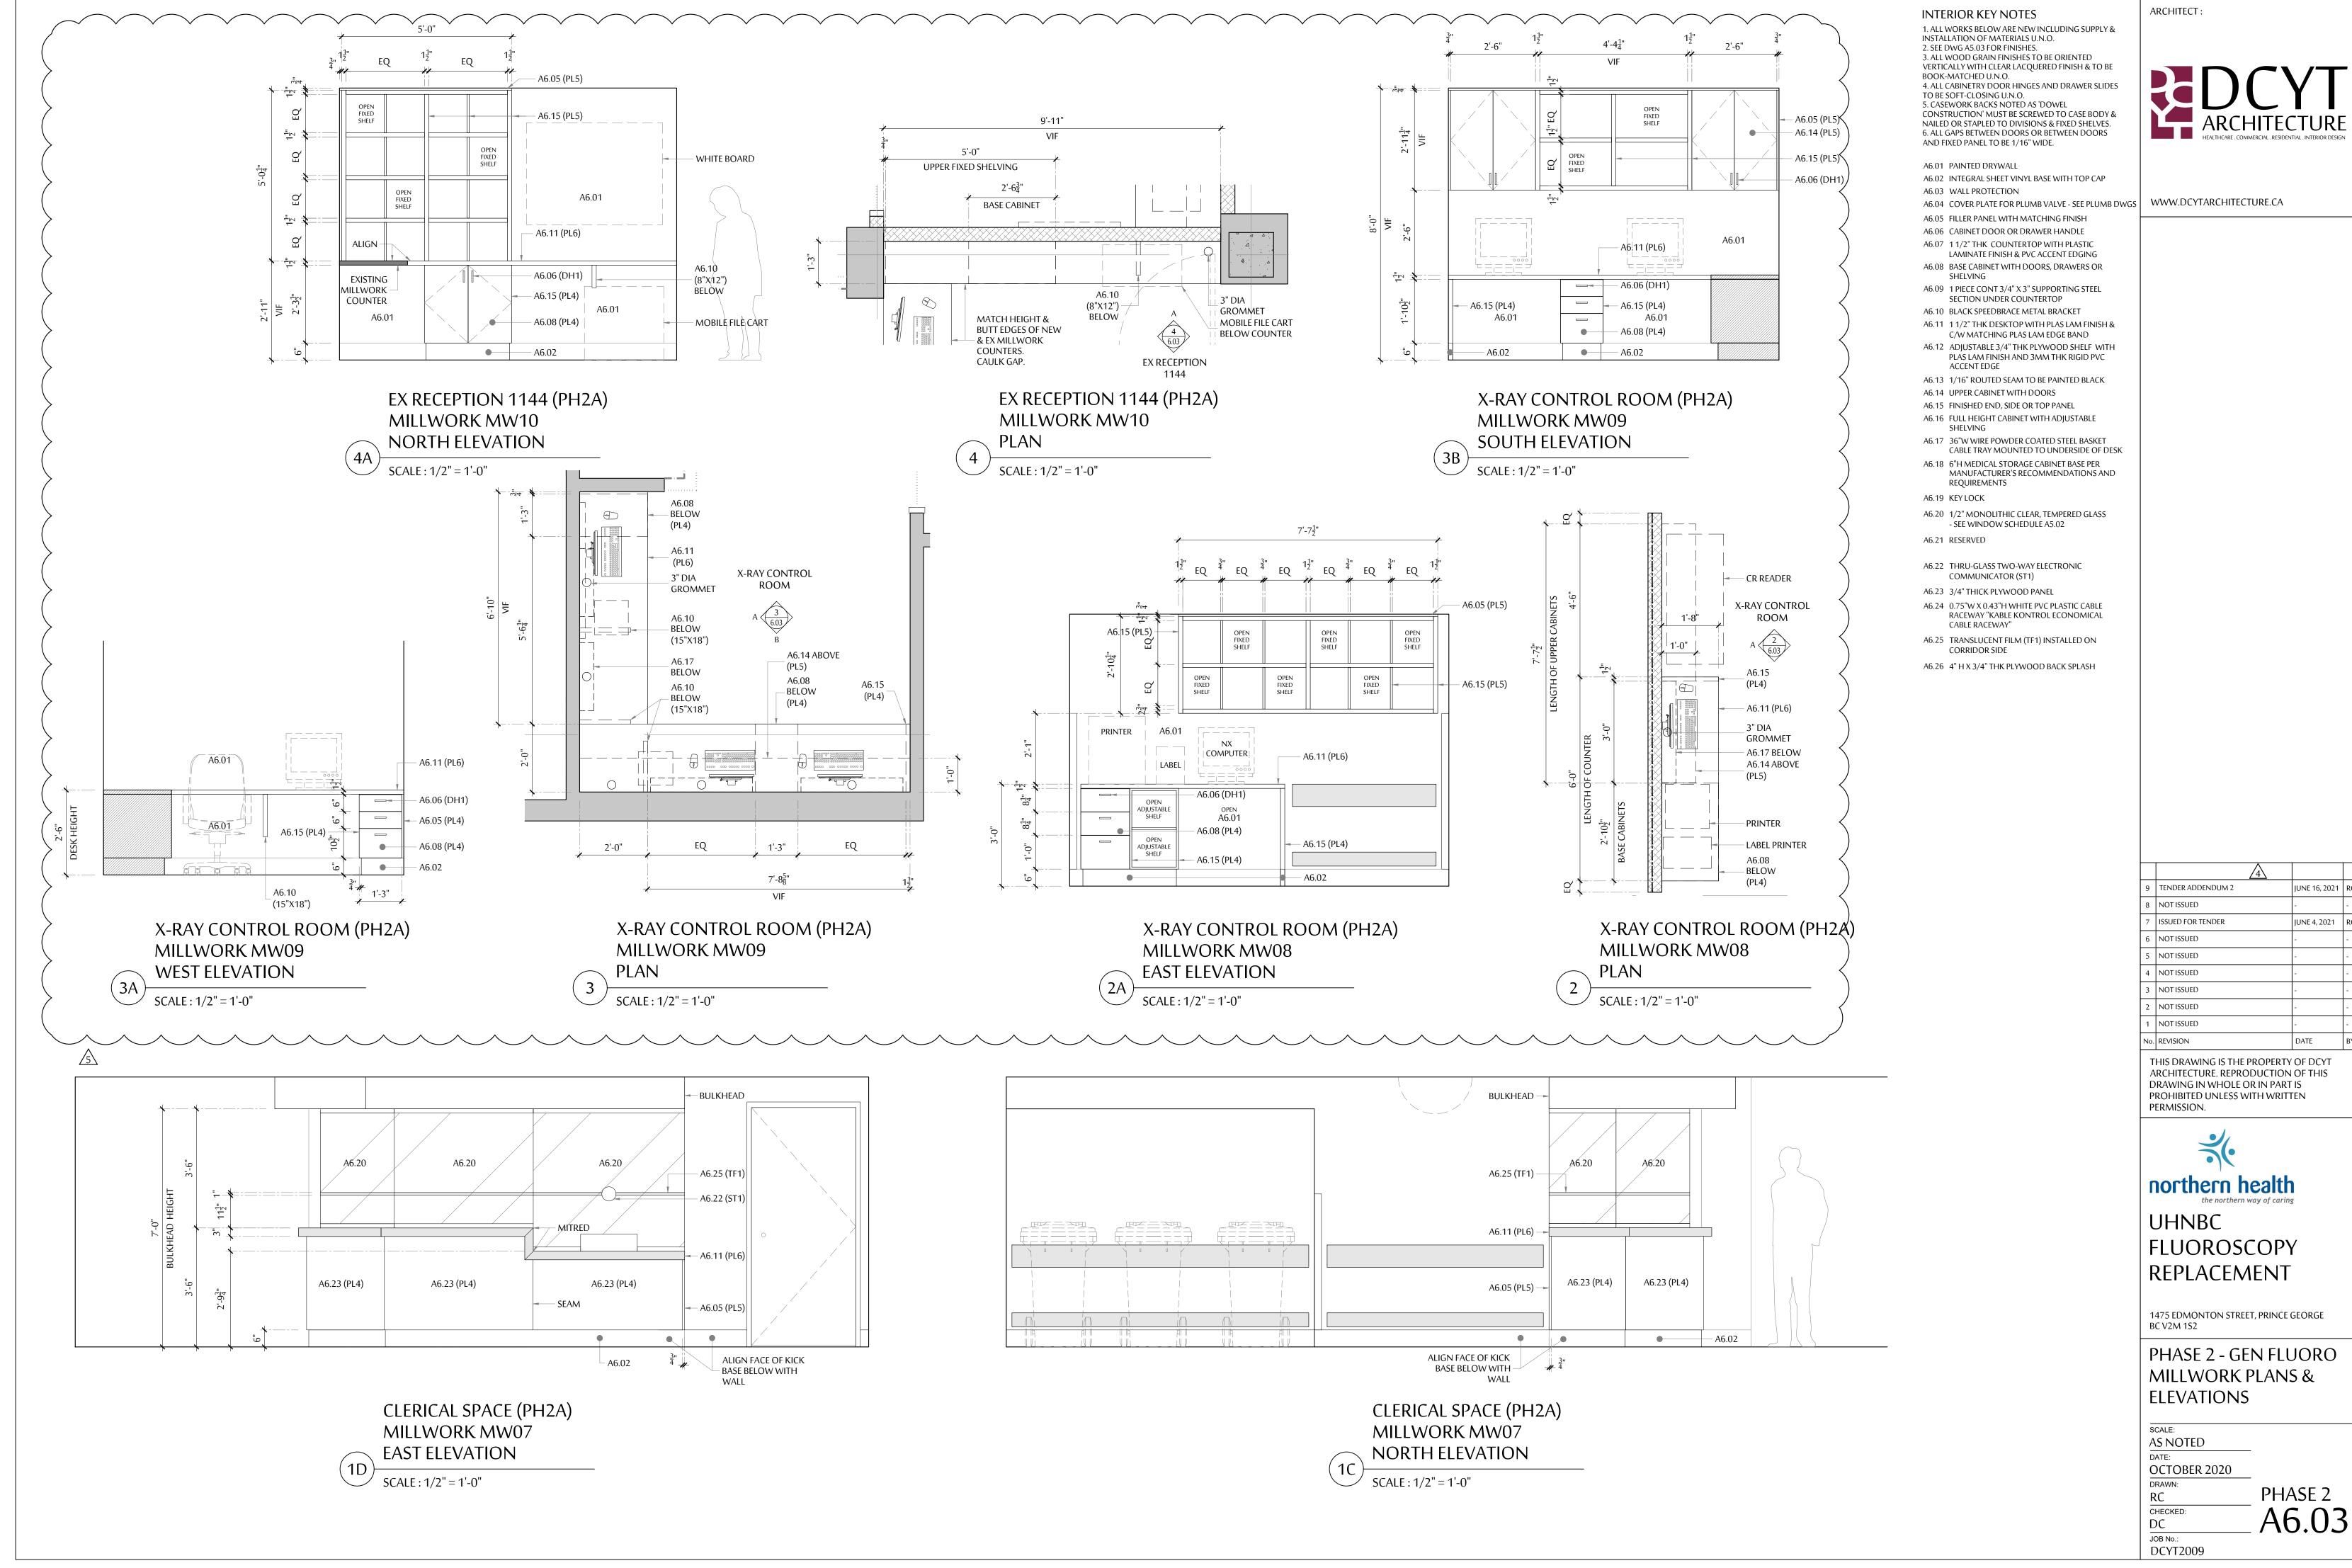


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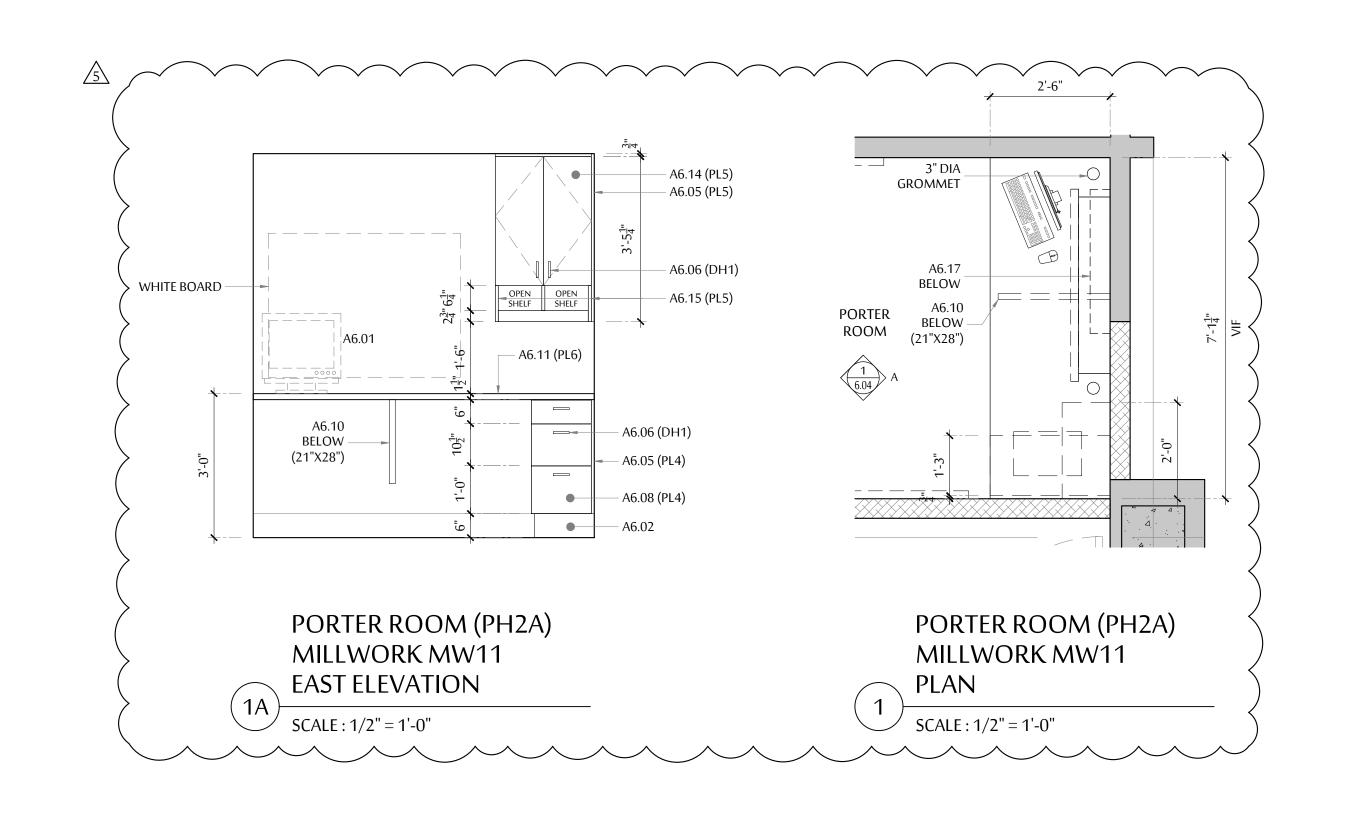
1475 EDMONTON STREET, PRINCE GEORGE BC V2M 1S2

PHASE 2 - GEN FLUORO ROOM, FINISHES & FIXTURES SCHEDULES

SCALE:	
AS NOTED	
DATE:	_
OCTOBER 2020	
DRAWN:	- - DIIAGE
RC	PHASE
CHECKED:	$\bar{}$ Λ Γ ℓ
DC	$J.CH_{-}$
JOB No.:	•
DCYT2009	



JUNE 16, 2021 RC JUNE 4, 2021 RC



INTERIOR KEY NOTES

1. ALL WORKS BELOW ARE NEW INCLUDING SUPPLY & INSTALLATION OF MATERIALS U.N.O. 2. SEE DWG A5.03 FOR FINISHES. 3. ALL WOOD GRAIN FINISHES TO BE ORIENTED VERTICALLY WITH CLEAR LACQUERED FINISH & TO BE BOOK-MATCHED U.N.O. 4. ALL CABINETRY DOOR HINGES AND DRAWER SLIDES TO BE SOFT-CLOSING U.N.O. 5. CASEWORK BACKS NOTED AS 'DOWEL CONSTRUCTION' MUST BE SCREWED TO CASE BODY & NAILED OR STAPLED TO DIVISIONS & FIXED SHELVES. 6. ALL GAPS BETWEEN DOORS OR BETWEEN DOORS

A6.01 PAINTED DRYWALL

AND FIXED PANEL TO BE 1/16" WIDE.

A6.02 INTEGRAL SHEET VINYL BASE WITH TOP CAP A6.03 WALL PROTECTION

A6.04 COVER PLATE FOR PLUMB VALVE - SEE PLUMB DWGS WWW.DCYTARCHITECTURE.CA

A6.05 FILLER PANEL WITH MATCHING FINISH A6.06 CABINET DOOR OR DRAWER HANDLE A6.07 1 1/2" THK COUNTERTOP WITH PLASTIC

LAMINATE FINISH & PVC ACCENT EDGING A6.08 BASE CABINET WITH DOORS, DRAWERS OR SHELVING

A6.09 1 PIECE CONT 3/4" X 3" SUPPORTING STEEL

SECTION UNDER COUNTERTOP A6.10 BLACK SPEEDBRACE METAL BRACKET

C/W MATCHING PLAS LAM EDGE BAND A6.12 ADJUSTABLE 3/4" THK PLYWOOD SHELF WITH PLAS LAM FINISH AND 3MM THK RIGID PVC

A6.11 11/2" THK DESKTOP WITH PLAS LAM FINISH &

A6.13 1/16" ROUTED SEAM TO BE PAINTED BLACK A6.14 UPPER CABINET WITH DOORS

ACCENT EDGE

A6.15 FINISHED END, SIDE OR TOP PANEL A6.16 FULL HEIGHT CABINET WITH ADJUSTABLE SHELVING

A6.17 36"W WIRE POWDER COATED STEEL BASKET CABLE TRAY MOUNTED TO UNDERSIDE OF DESK

A6.18 6"H MEDICAL STORAGE CABINET BASE PER MANUFACTURER'S RECOMMENDATIONS AND REQUIREMENTS

A6.19 KEY LOCK

A6.20 1/2" MONOLITHIC CLEAR, TEMPERED GLASS - SEE WINDOW SCHEDULE A5.02

A6.21 RESERVED

A6.22 THRU-GLASS TWO-WAY ELECTRONIC COMMUNICATOR (ST1)

A6.23 3/4" THICK PLYWOOD PANEL

A6.24 0.75"W X 0.43"H WHITE PVC PLASTIC CABLE RACEWAY "KABLE KONTROL ECONOMICAL CABLE RACEWAY"

A6.25 TRANSLUCENT FILM (TF1) INSTALLED ON CORRIDOR SIDE

A6.26 4" H X 3/4" THK PLYWOOD BACK SPLASH

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8	NOT ISSUED	-	-
7	ISSUED FOR TENDER	JUNE 4, 2021	RC
6	NOT ISSUED	-	-
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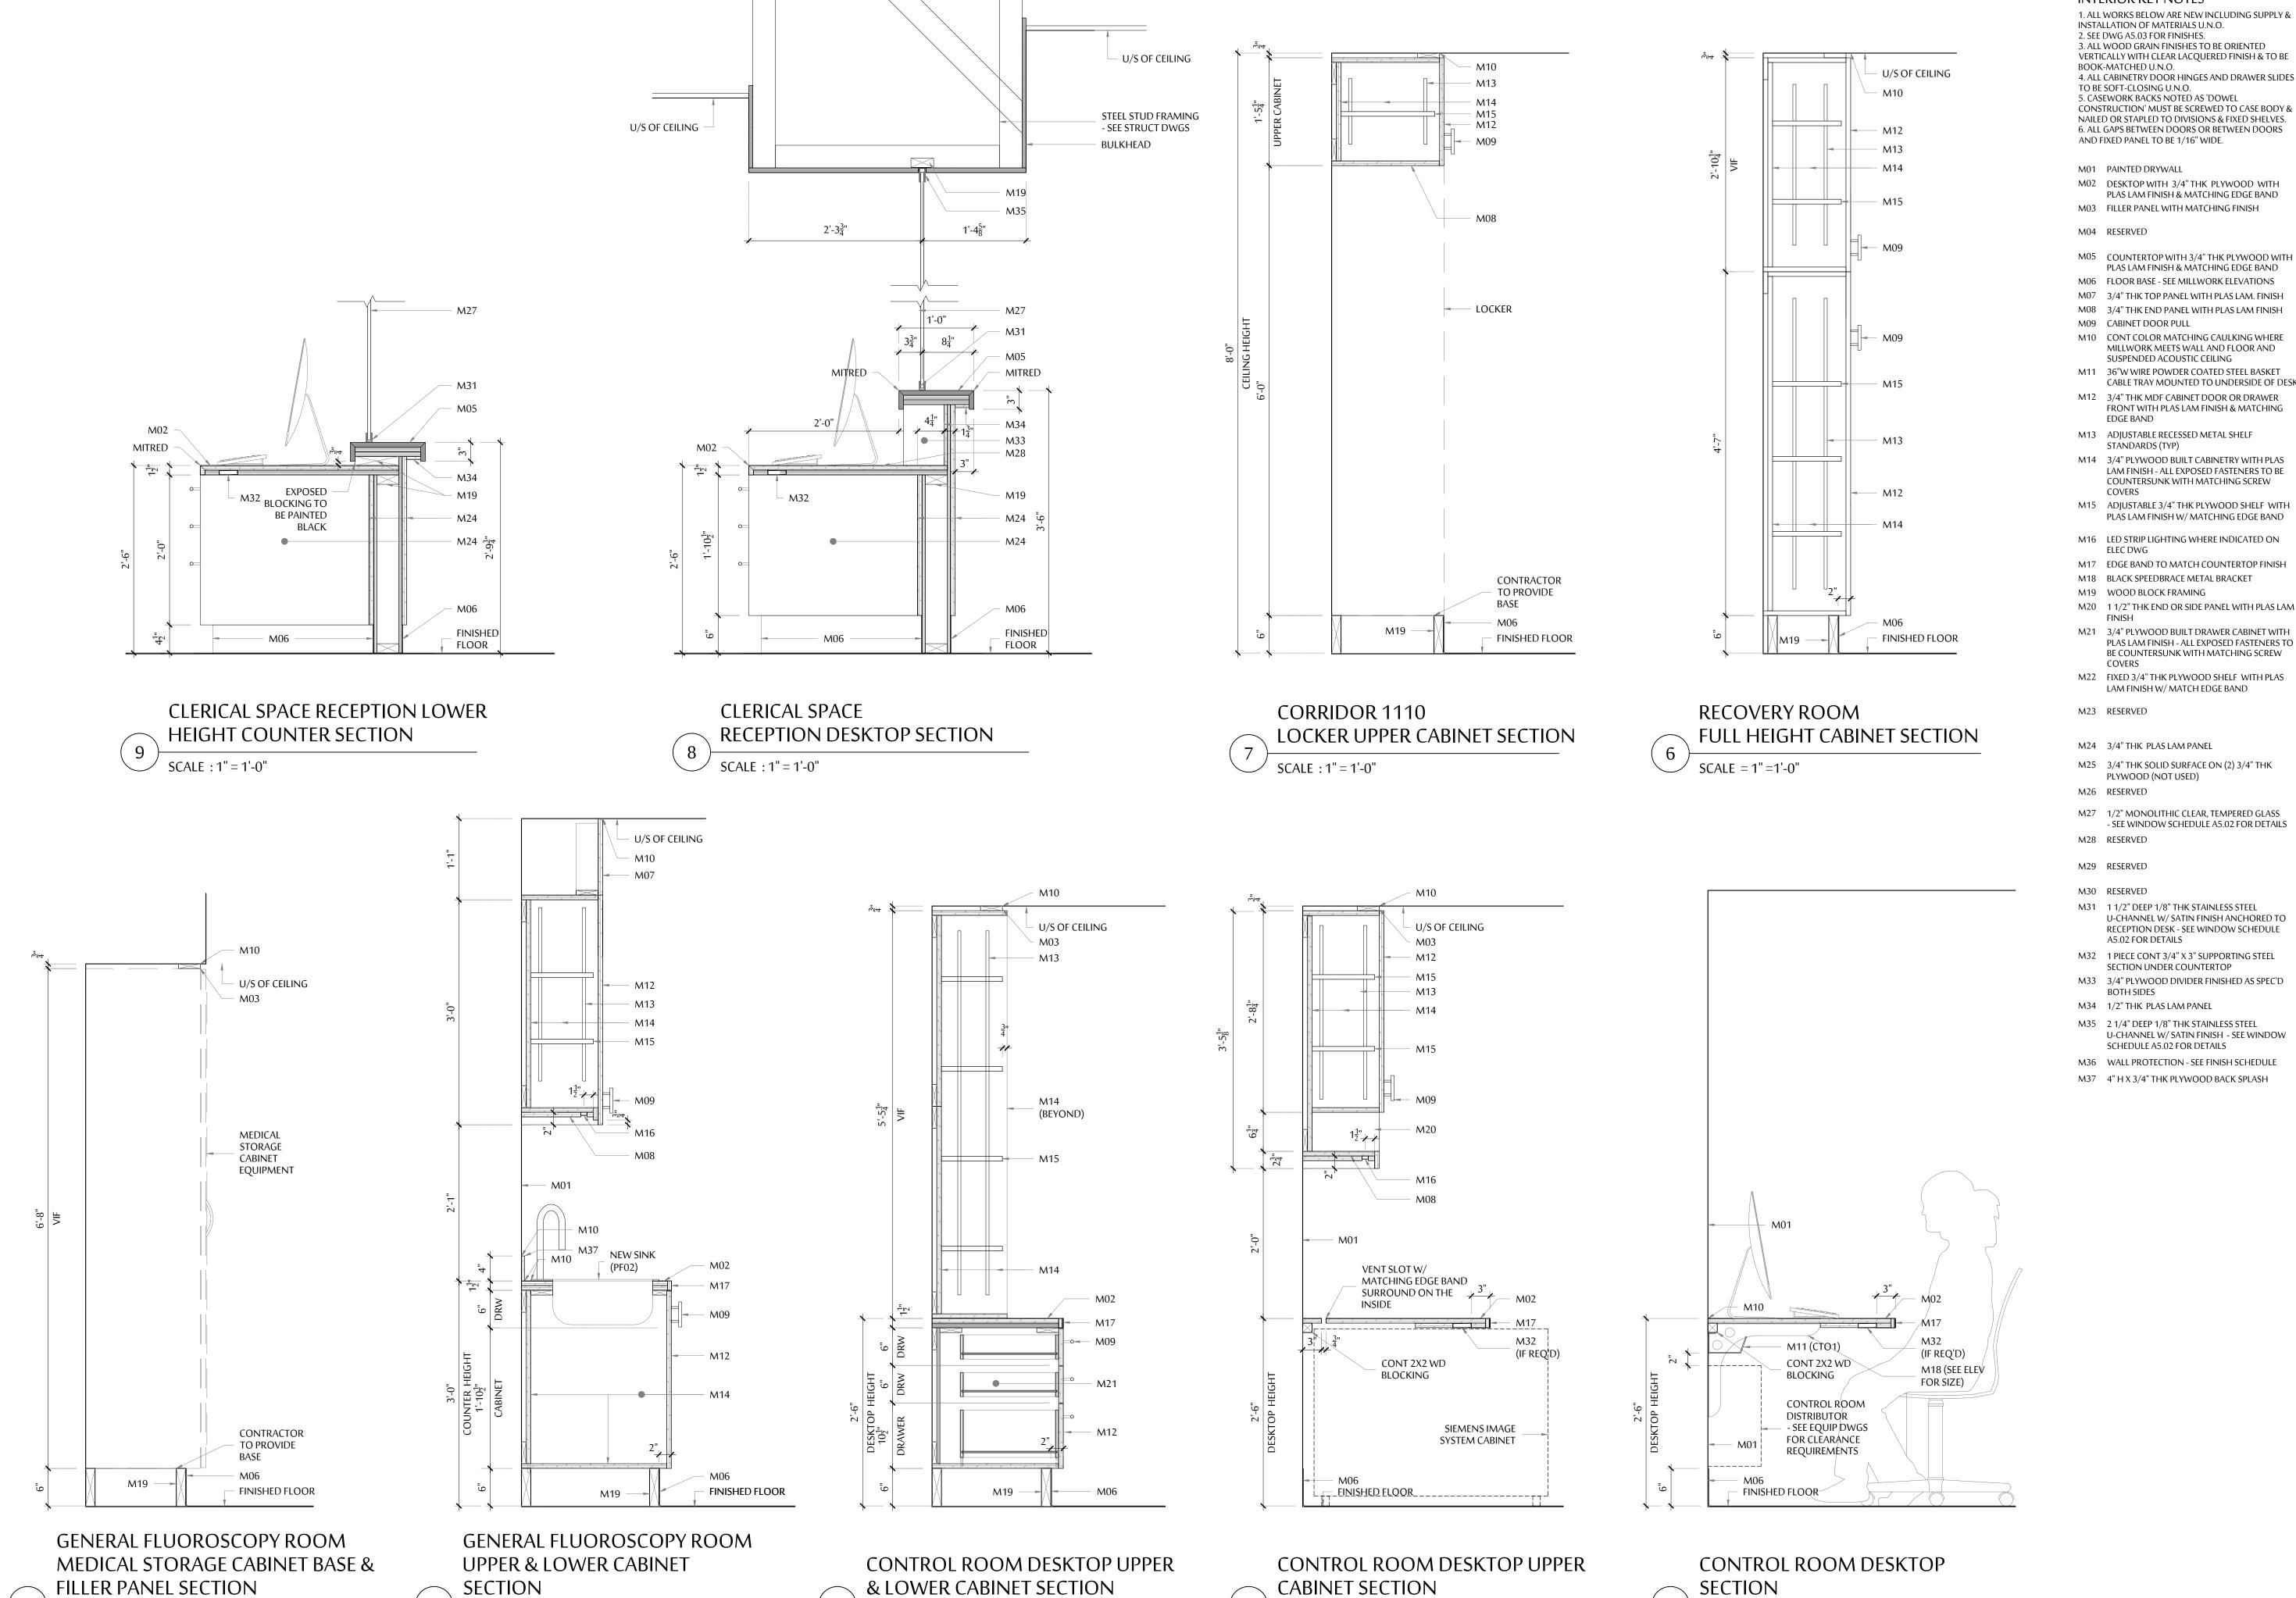


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PHASE 2 - GEN FLUORO MILLWORK PLANS & ELEVATIONS

SCALE: AS NOTED OCTOBER 2020 DRAWN:
RC
CHECKED:
DC
JOB No.: PHASE 2 A6.04 DCYT2009



SCALE : 1'' = 1'-0''

SCALE : 1'' = 1'-0''

SCALE : 1'' = 1'-0''

SCALE : 1" = 1'-0"

INTERIOR KEY NOTES

1. ALL WORKS BELOW ARE NEW INCLUDING SUPPLY & INSTALLATION OF MATERIALS U.N.O. 2. SEE DWG A5.03 FOR FINISHES. 3. ALL WOOD GRAIN FINISHES TO BE ORIENTED VERTICALLY WITH CLEAR LACQUERED FINISH & TO BE BOOK-MATCHED U.N.O. 4. ALL CABINETRY DOOR HINGES AND DRAWER SLIDES TO BE SOFT-CLOSING U.N.O. 5. CASEWORK BACKS NOTED AS 'DOWEL CONSTRUCTION' MUST BE SCREWED TO CASE BODY &

NAILED OR STAPLED TO DIVISIONS & FIXED SHELVES. 6. ALL GAPS BETWEEN DOORS OR BETWEEN DOORS

ARCHITECT:

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M01 PAINTED DRYWALL

M02 DESKTOP WITH 3/4" THK PLYWOOD WITH PLAS LAM FINISH & MATCHING EDGE BAND

PLAS LAM FINISH & MATCHING EDGE BAND M06 FLOOR BASE - SEE MILLWORK ELEVATIONS

M07 3/4" THK TOP PANEL WITH PLAS LAM. FINISH

M08 3/4" THK END PANEL WITH PLAS LAM FINISH M09 CABINET DOOR PULL M10 CONT COLOR MATCHING CAULKING WHERE

MILLWORK MEETS WALL AND FLOOR AND SUSPENDED ACOUSTIC CEILING M11 36"W WIRE POWDER COATED STEEL BASKET

CABLE TRAY MOUNTED TO UNDERSIDE OF DESK M12 3/4" THK MDF CABINET DOOR OR DRAWER FRONT WITH PLAS LAM FINISH & MATCHING

M13 ADJUSTABLE RECESSED METAL SHELF STANDARDS (TYP)

M14 3/4" PLYWOOD BUILT CABINETRY WITH PLAS LAM FINISH - ALL EXPOSED FASTENERS TO BE COUNTERSUNK WITH MATCHING SCREW

M15 ADJUSTABLE 3/4" THK PLYWOOD SHELF WITH PLAS LAM FINISH W/ MATCHING EDGE BAND

M16 LED STRIP LIGHTING WHERE INDICATED ON

M18 BLACK SPEEDBRACE METAL BRACKET

M19 WOOD BLOCK FRAMING

M20 1 1/2" THK END OR SIDE PANEL WITH PLAS LAM

M21 3/4" PLYWOOD BUILT DRAWER CABINET WITH PLAS LAM FINISH - ALL EXPOSED FASTENERS TO BE COUNTERSUNK WITH MATCHING SCREW

M22 FIXED 3/4" THK PLYWOOD SHELF WITH PLAS LAM FINISH W/ MATCH EDGE BAND

M24 3/4" THK PLAS LAM PANEL

M25 3/4" THK SOLID SURFACE ON (2) 3/4" THK

M27 1/2" MONOLITHIC CLEAR, TEMPERED GLASS - SEE WINDOW SCHEDULE A5.02 FOR DETAILS

M31 1 1/2" DEEP 1/8" THK STAINLESS STEEL U-CHANNEL W/ SATIN FINISH ANCHORED TO RECEPTION DESK - SEE WINDOW SCHEDULE A5.02 FOR DETAILS

M32 1 PIECE CONT 3/4" X 3" SUPPORTING STEEL SECTION UNDER COUNTERTOP

M33 3/4" PLYWOOD DIVIDER FINISHED AS SPEC'D

M34 1/2" THK PLAS LAM PANEL

SCALE : 1" = 1'-0"

M35 2 1/4" DEEP 1/8" THK STAINLESS STEEL U-CHANNEL W/ SATIN FINISH - SEE WINDOW SCHEDULE A5.02 FOR DETAILS

M36 WALL PROTECTION - SEE FINISH SCHEDULE

M37 4" H X 3/4" THK PLYWOOD BACK SPLASH

0 TENDER ADDENDUM 5 JULY 26, 2021 RC TENDER ADDENDUM 2 JUNE 16, 2021 RC NOT ISSUED ISSUED FOR TENDER JUNE 4, 2021 RC NOT ISSUED NOT ISSUED NOT ISSUED NOT ISSUED NOT ISSUED 1 NOT ISSUED No. REVISION

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FLUOROSCOPY

1475 EDMONTON STREET, PRINCE GEORGE BC V2M 1S2

PHASE 2 - GEN FLUORO MILLWORK SECTIONS

PHASE 2 A6.05 DCYT2009

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Name Lori Renwick, BC Sales Manager Lorirenwick@shawcable.com Email:

(250) 712-1001 Phone:

H/O Address 7198 Progress Way, Delta BC V4G 1J2

Phone: 604-946-7712 604-946-7715 1.800.663.0047 Toll Free:

Attention: Leah Joseph

Coordinator Capitol Projects

For: Northern Health Authority - University Hospital

Phone: 250-645-8744

Fax: Email:

Leah.Joseph@Northernhealth.ca

F.O.B. TERMS **DELIVERY** NUMBER

Freight Extra Net 30 days Prince George, BC 149439-Rev1

SALES TAX REVISED

Extra

7/20/2021 Thank you for your inquiry dated: Ship To: **NHA - University Hospital** 1475 Edmonton Street We are pleased to quote you the following:

Prince George, BC

QUANTITY	ITEM CODE	DESCRIPTION		UNIT	PRICE	EXTENDED PRICE	
		Evolve Tall Cabinet w/ Glass Doors Airecore/White Aluminu	ım				
1	SEA1927TGLAP	19.25"d x 26.75"w x 80"hLeft GD w/ Accessory Pack		\$	3,210.00	\$	3,210.00
1	SEA1927TTK0	No TK, 19.25"d x 26.75"w x 0"h*Cabinet Height - 80"h		\$	-	\$	-
3	SEA1927TGLDS	19.25"d x 26.75"w x 80"hLeft GD, Divided Shelves		\$	2,840.00	\$	3,520.00
3	SEA1927TTK0	No TK, 19.25"d x 26.75"w x 0"h*Cabinet Height - 80"h		\$	-	\$	-
4	SEATSAK	Seismic Anchor Kit For Airecore Tall Cabinets		\$	637.00	\$	2,548.00
1	Freight	Estimated freight charge only, valid for 30 days shipping to:	George, BC	\$	4,025.00	\$	4,025.00
			Total (Before	Applica	able Taxes)	\$ 18	3,303.00

Pricing valid for 30 days and based on the quantities specified. Prices subject to change if the purchase quantity varies from above. One time shipping to one location. Pricing is subject to change if a split or delayed shipment is requested. Claims for defects or shortages must be made within 48 hours from receipt of goods. Equipment and custom product orders are non-returnable. Please review specifications carefully before ordering.


We will be happy to supply any further information you may need and trust that you call on us to fill your order, which will receive our prompt and careful attention.


Clinton Watkins, Purchasing Contract Manager	_	July 20, 2021
PER		DATE
I am in acceptance and agreement with the above quoted product without any changes.	ct and its specifications. By signing below, I hereby authorize Bowers Medical Supply to re	elease this order
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Products that reflect a custom design and/or color other than


Colors	WILSONART	FORMICA	□NEVAMAR	PIONITI
Lamina	te Color			


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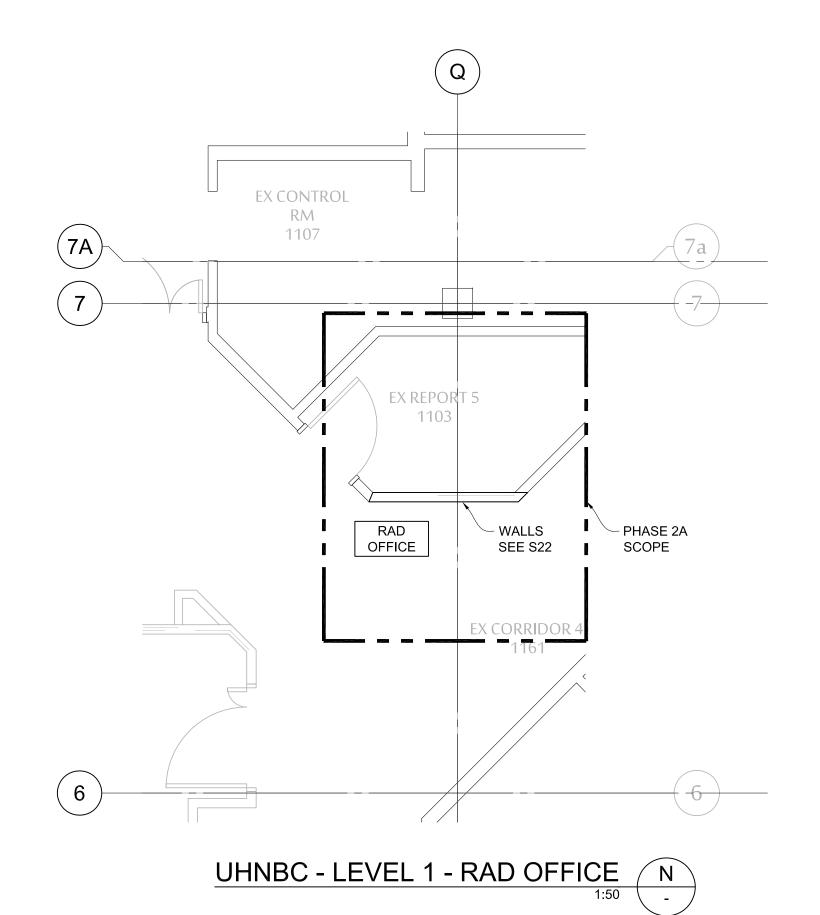
Edgeband Color WHITE BLACK FUSION MAPLE Rev. A Quote No.

SUPPLY COMPANY 149439

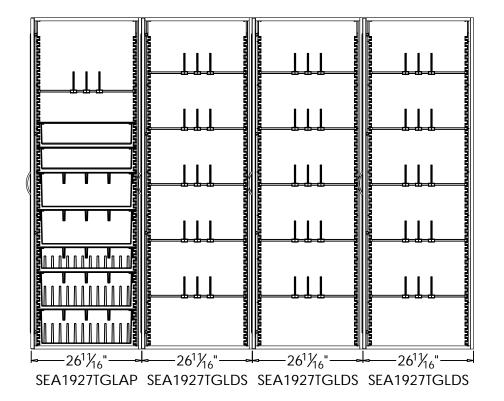BRUSHED ALUMINUM BILTMORE CHERRY Date 6/18/2021 Drawn By

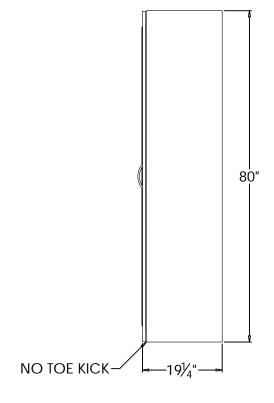

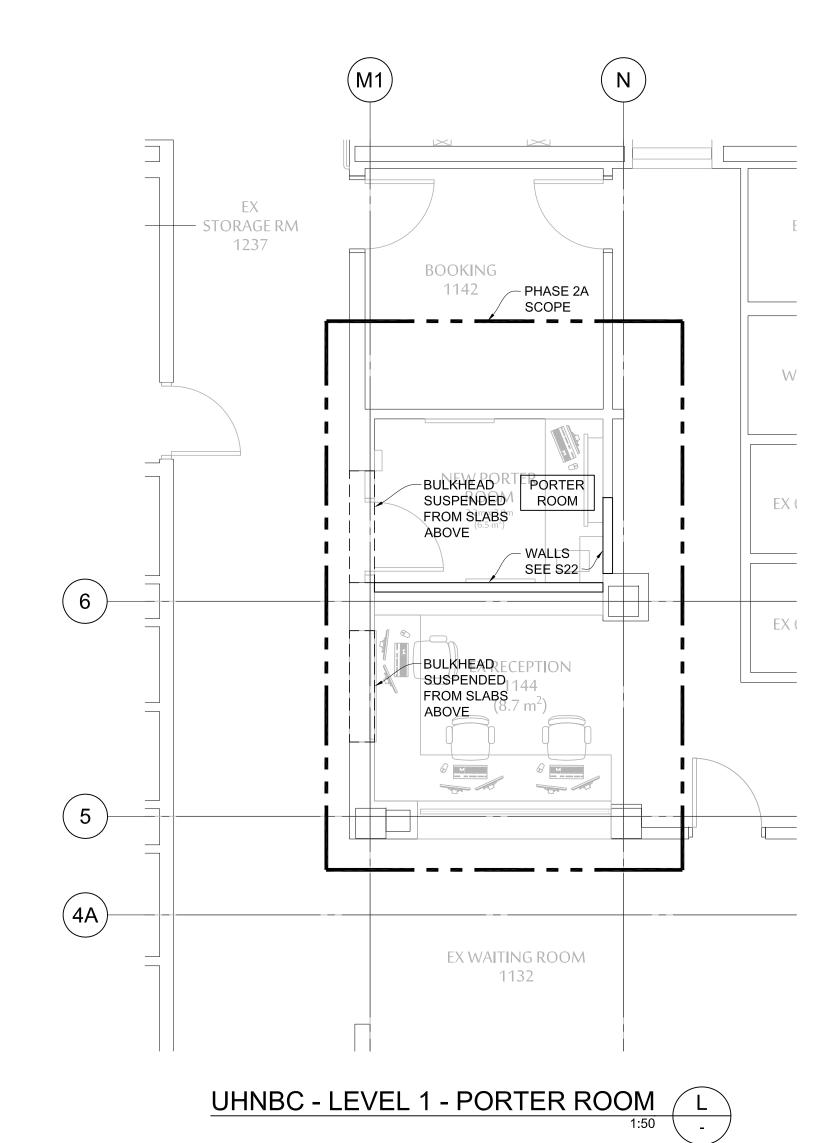

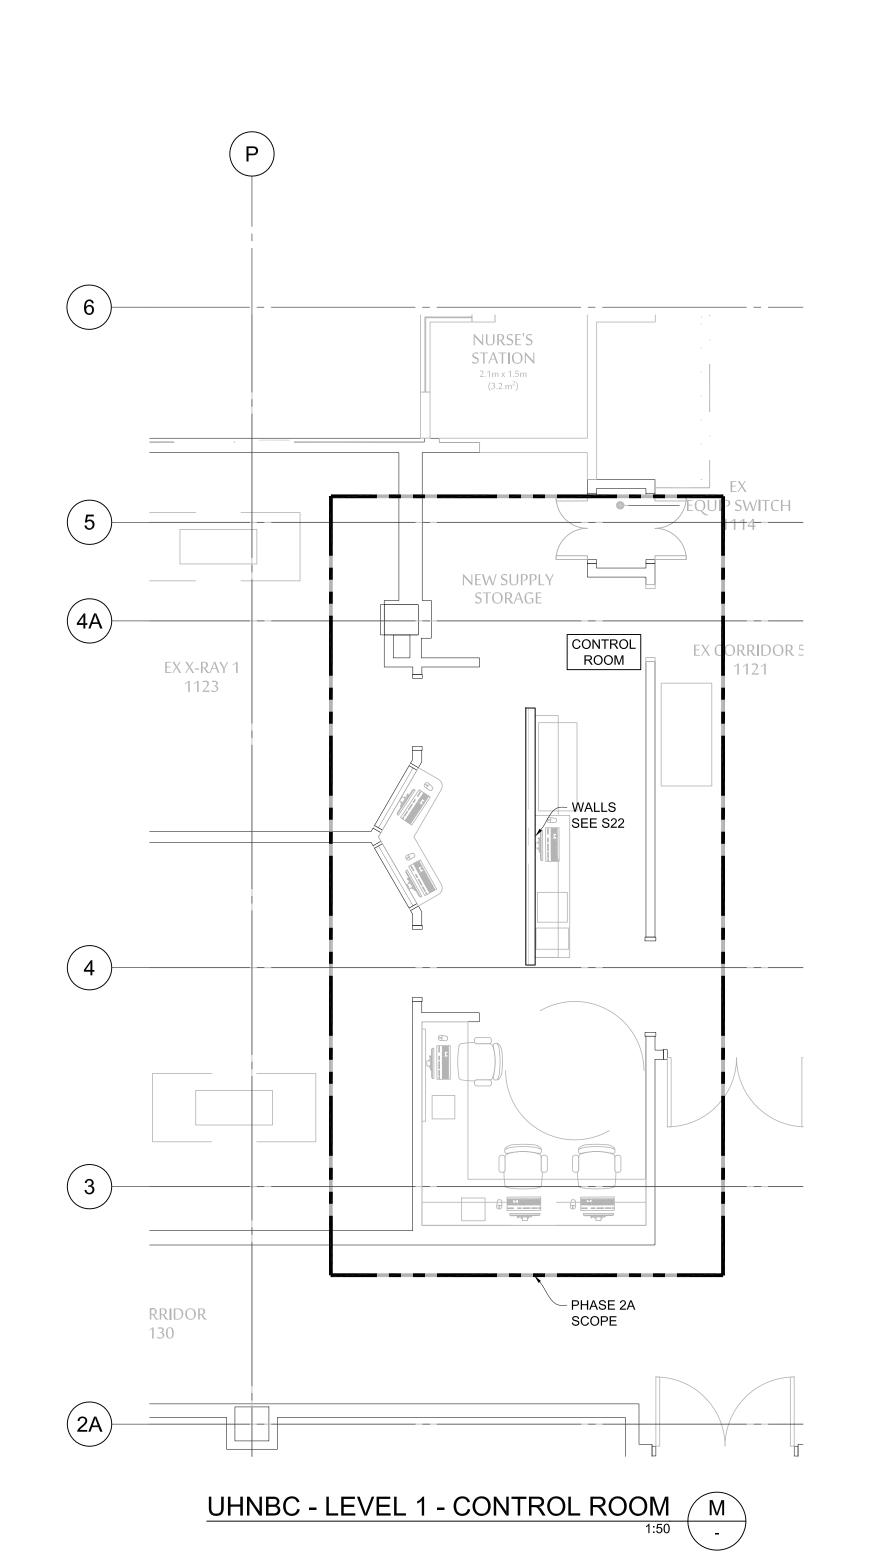



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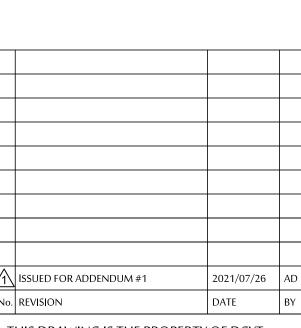
C.Y. LOH ASSOCIATES LTD Consulting Structural Engineers

1863 Powell Street
Vancouver, B.C. V5L 1H8
T: 604.254.0868
E: cyla@cyla.ca

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Prior to commencement of the Work, the Contractor shall

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PHASE 2 - GEN FLUORO CONTROL ROOM, RAD OFFICE AND PORTER ROOM

AS NOTED

DATE:
APRIL 2021

DRAWN:

APRIL 2021
DRAWN:
SAL
CHECKED:
KM
TOR NI

DRAWN:
PHASE 2
S26



Addendum

Client: Northern Health Project Number: 20_002

Project Name: UHN General Fluoro Attention: Douglas Cheung

Date: July 23, 2021

Addendum No: 2 Number of Pages: 1

Drawings


1. ADD: Refer to the attached drawings for additional mechanical scope for the Rad Office, Porter Room and Control room

End of Document

Attachments:

- M1.201
- M1.301
- M2.201
- M2.301

Jason Le, P.Eng., CEM Senior Mechanical Engineer P: 604 992 5920 E: jle@impacteng.ca

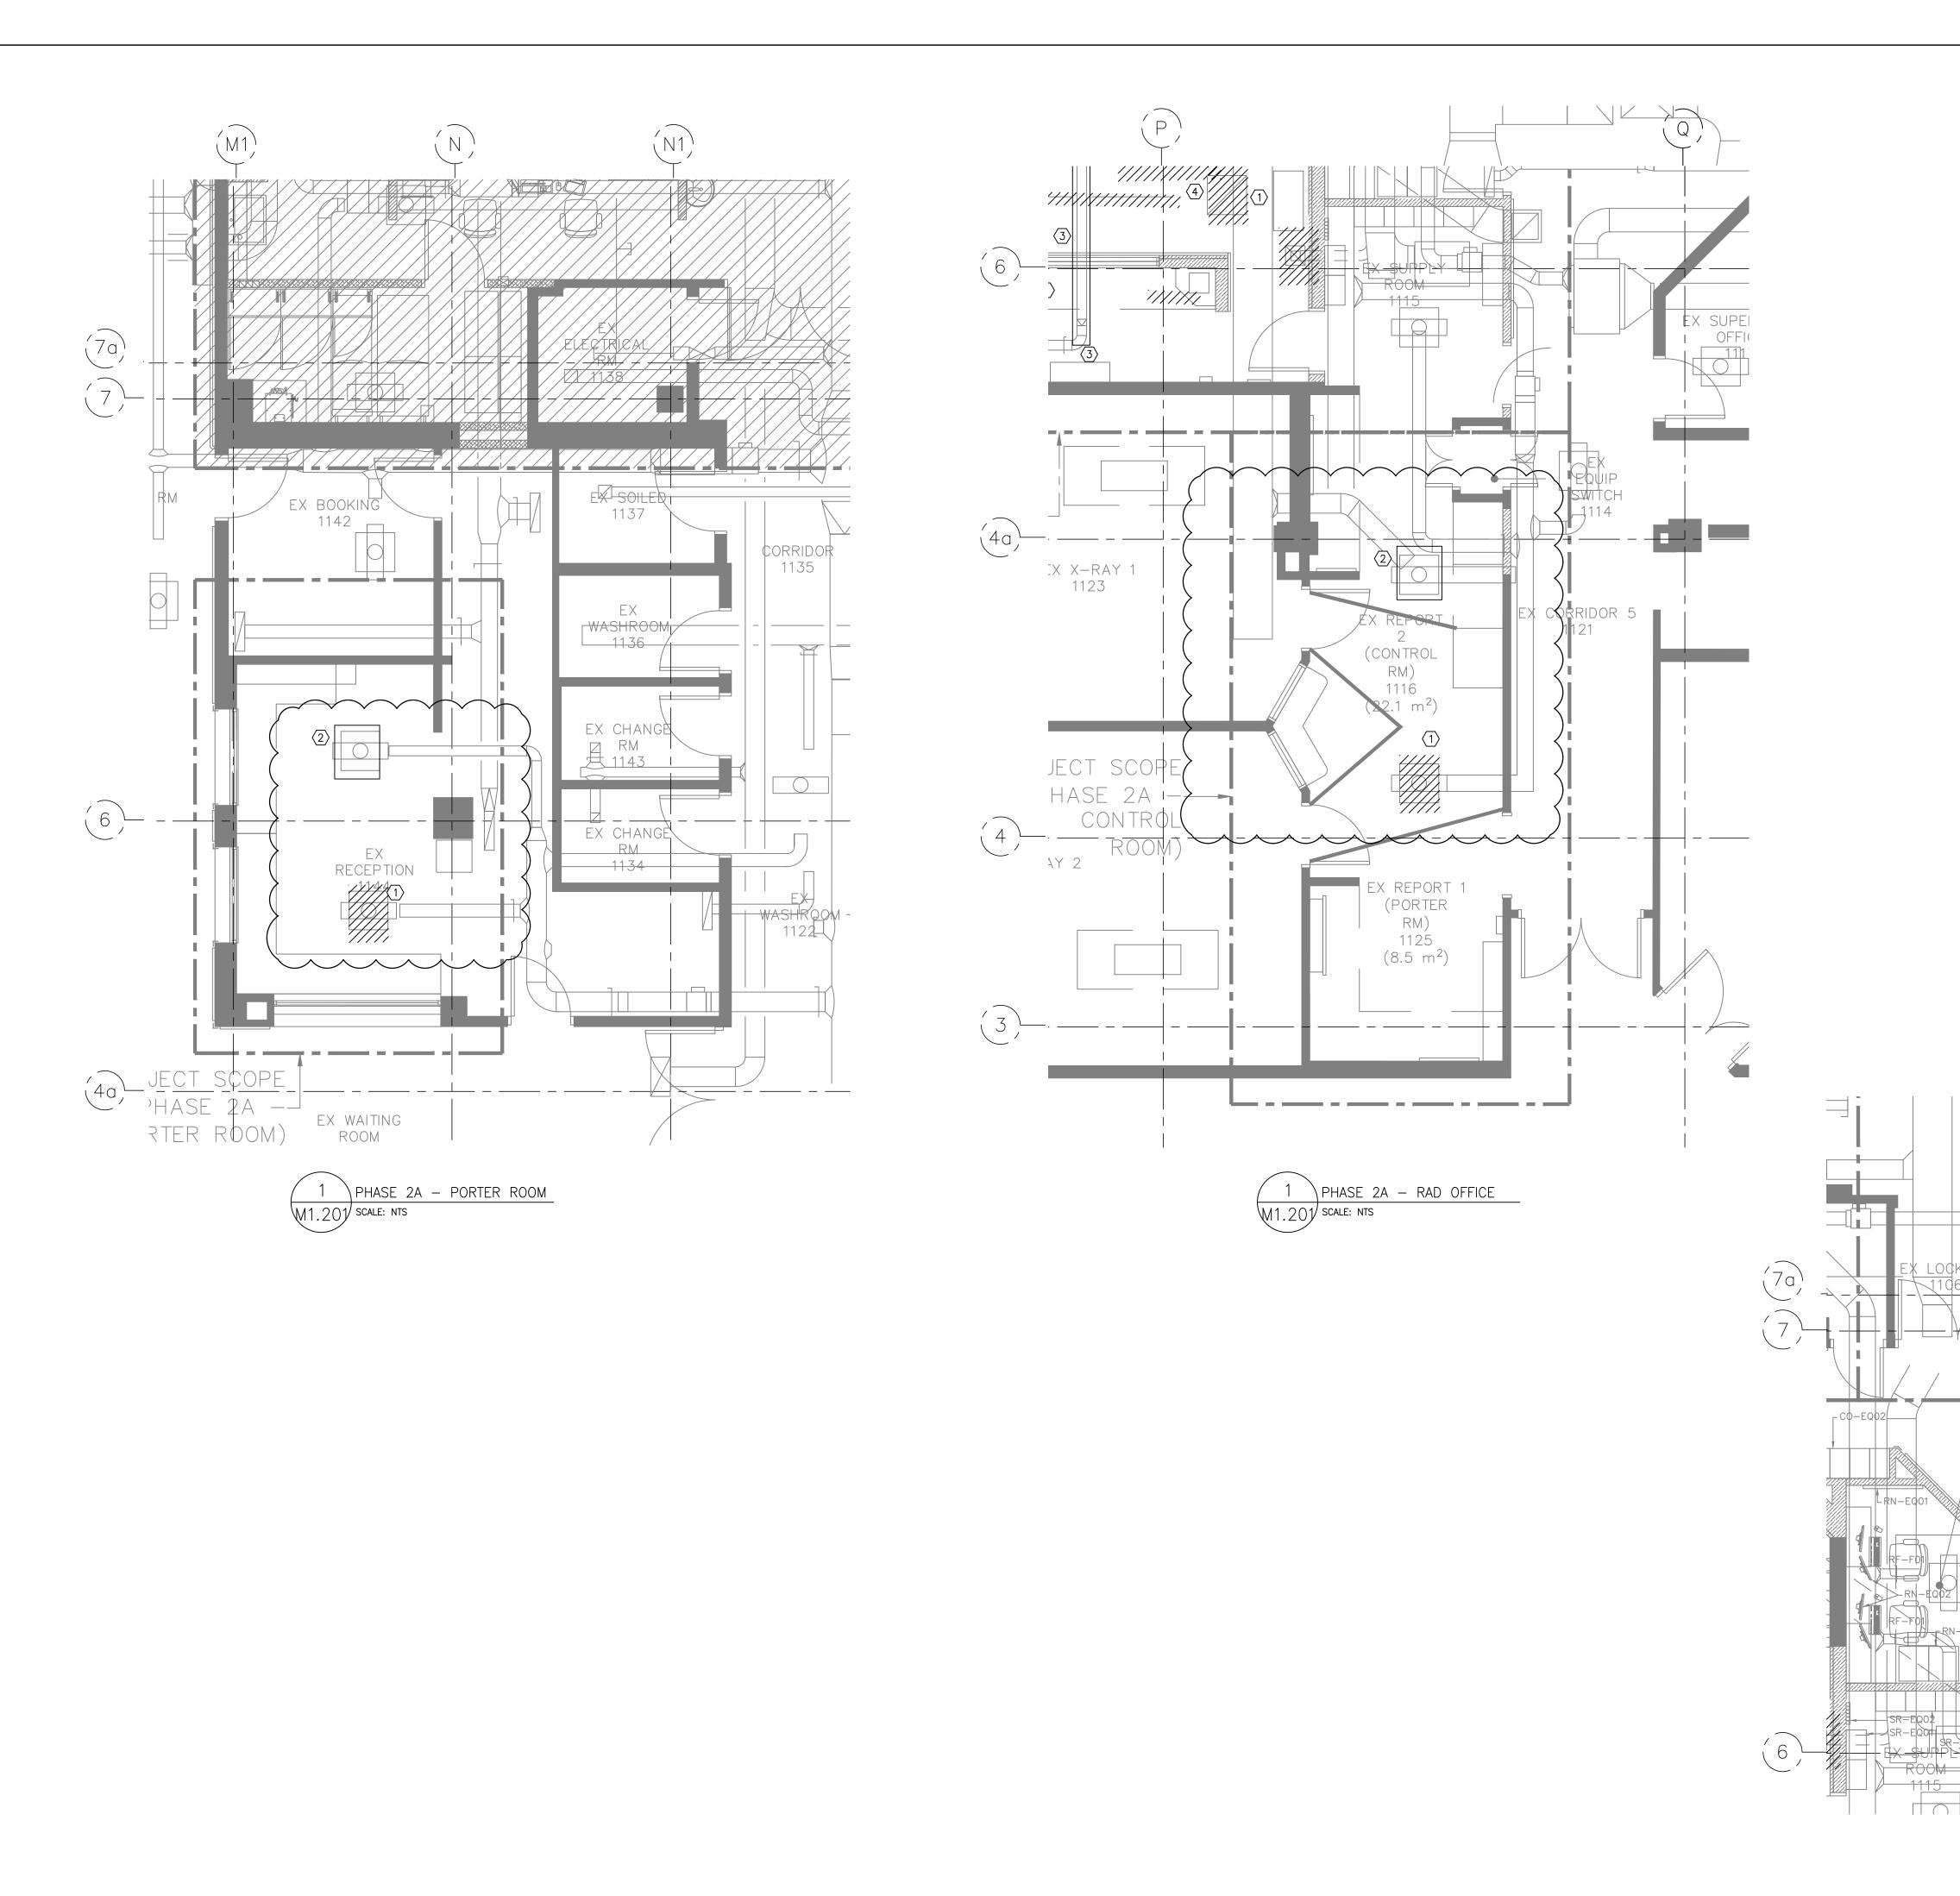

DRAWING NOTES

- 1 EXISTING DIFFUSER TO BE RELOCATED AND REPLACED WITH NEW.
- 2 EXISTING DIFFUSER TO BE REPLACED WITH NEW
- 3 EXISTING DUCT BRANCH TO BE UPSIZED. REFER TO NEW PLANS

ARCHITECTURE
HEALTHCARE.COMMERCIAL.RESIDENTIAL.INTERIOR DESIGN

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ARCHITECT :

MECHANICAL CONSULTANT :



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5	ISSUED FOR TENDER	2021.06.04
4	ISSUED FOR 80% CD	2021.05.20
3	ISSUED FOR BP	2021.05.06
2	ISSUED FOR BP REVIEW	2021.04.28
1	ISSUED FOR DD	2021.04.09
No.	REVISION	DATE

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LEVEL 1 EXISTING MECHANICAL PLAN

PHASE 2

SCALE:


1:50 DATE: JUNE 06 2021 DRAWN: KM CHECKED: M1.201

JL JOB No.: 20_002

N

1 \PHASE 2A - CONTROL ROOM

M1.201 SCALE: NTS

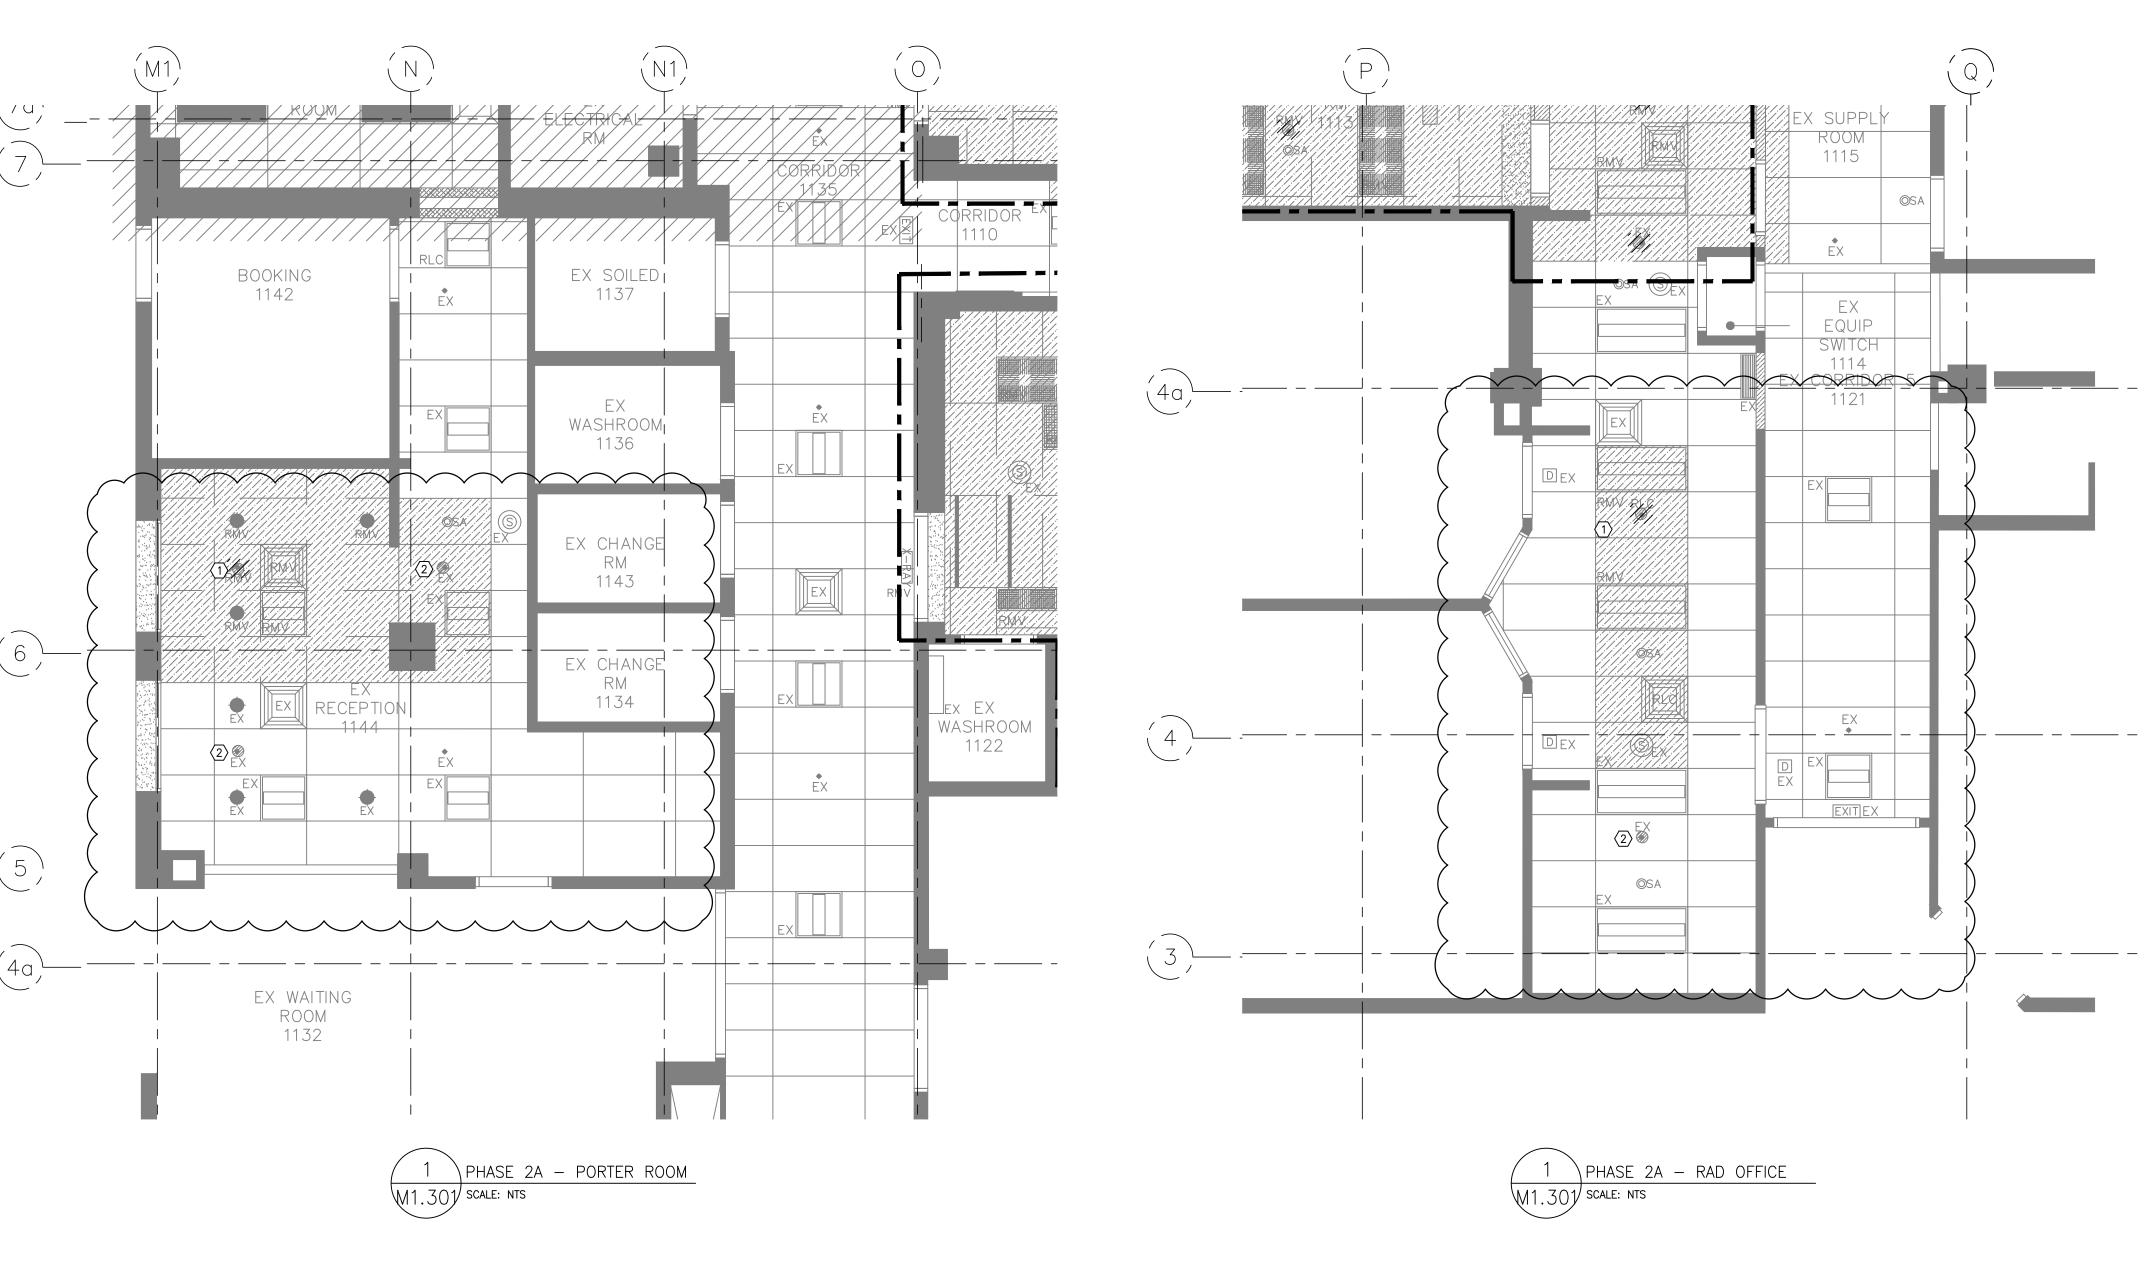

DRAWING NOTES 1 EXISTING PENDANT TO BE REMOVED. 2 EXISTING SPRINKLER PENDANT TO REMAIN

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MECHANICAL CONSULTANT

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1	ISSUED FOR DD	2021.04.09
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LEVEL 1 EXISTING FIRE SUPPRESSION PLAN

PHASE 2


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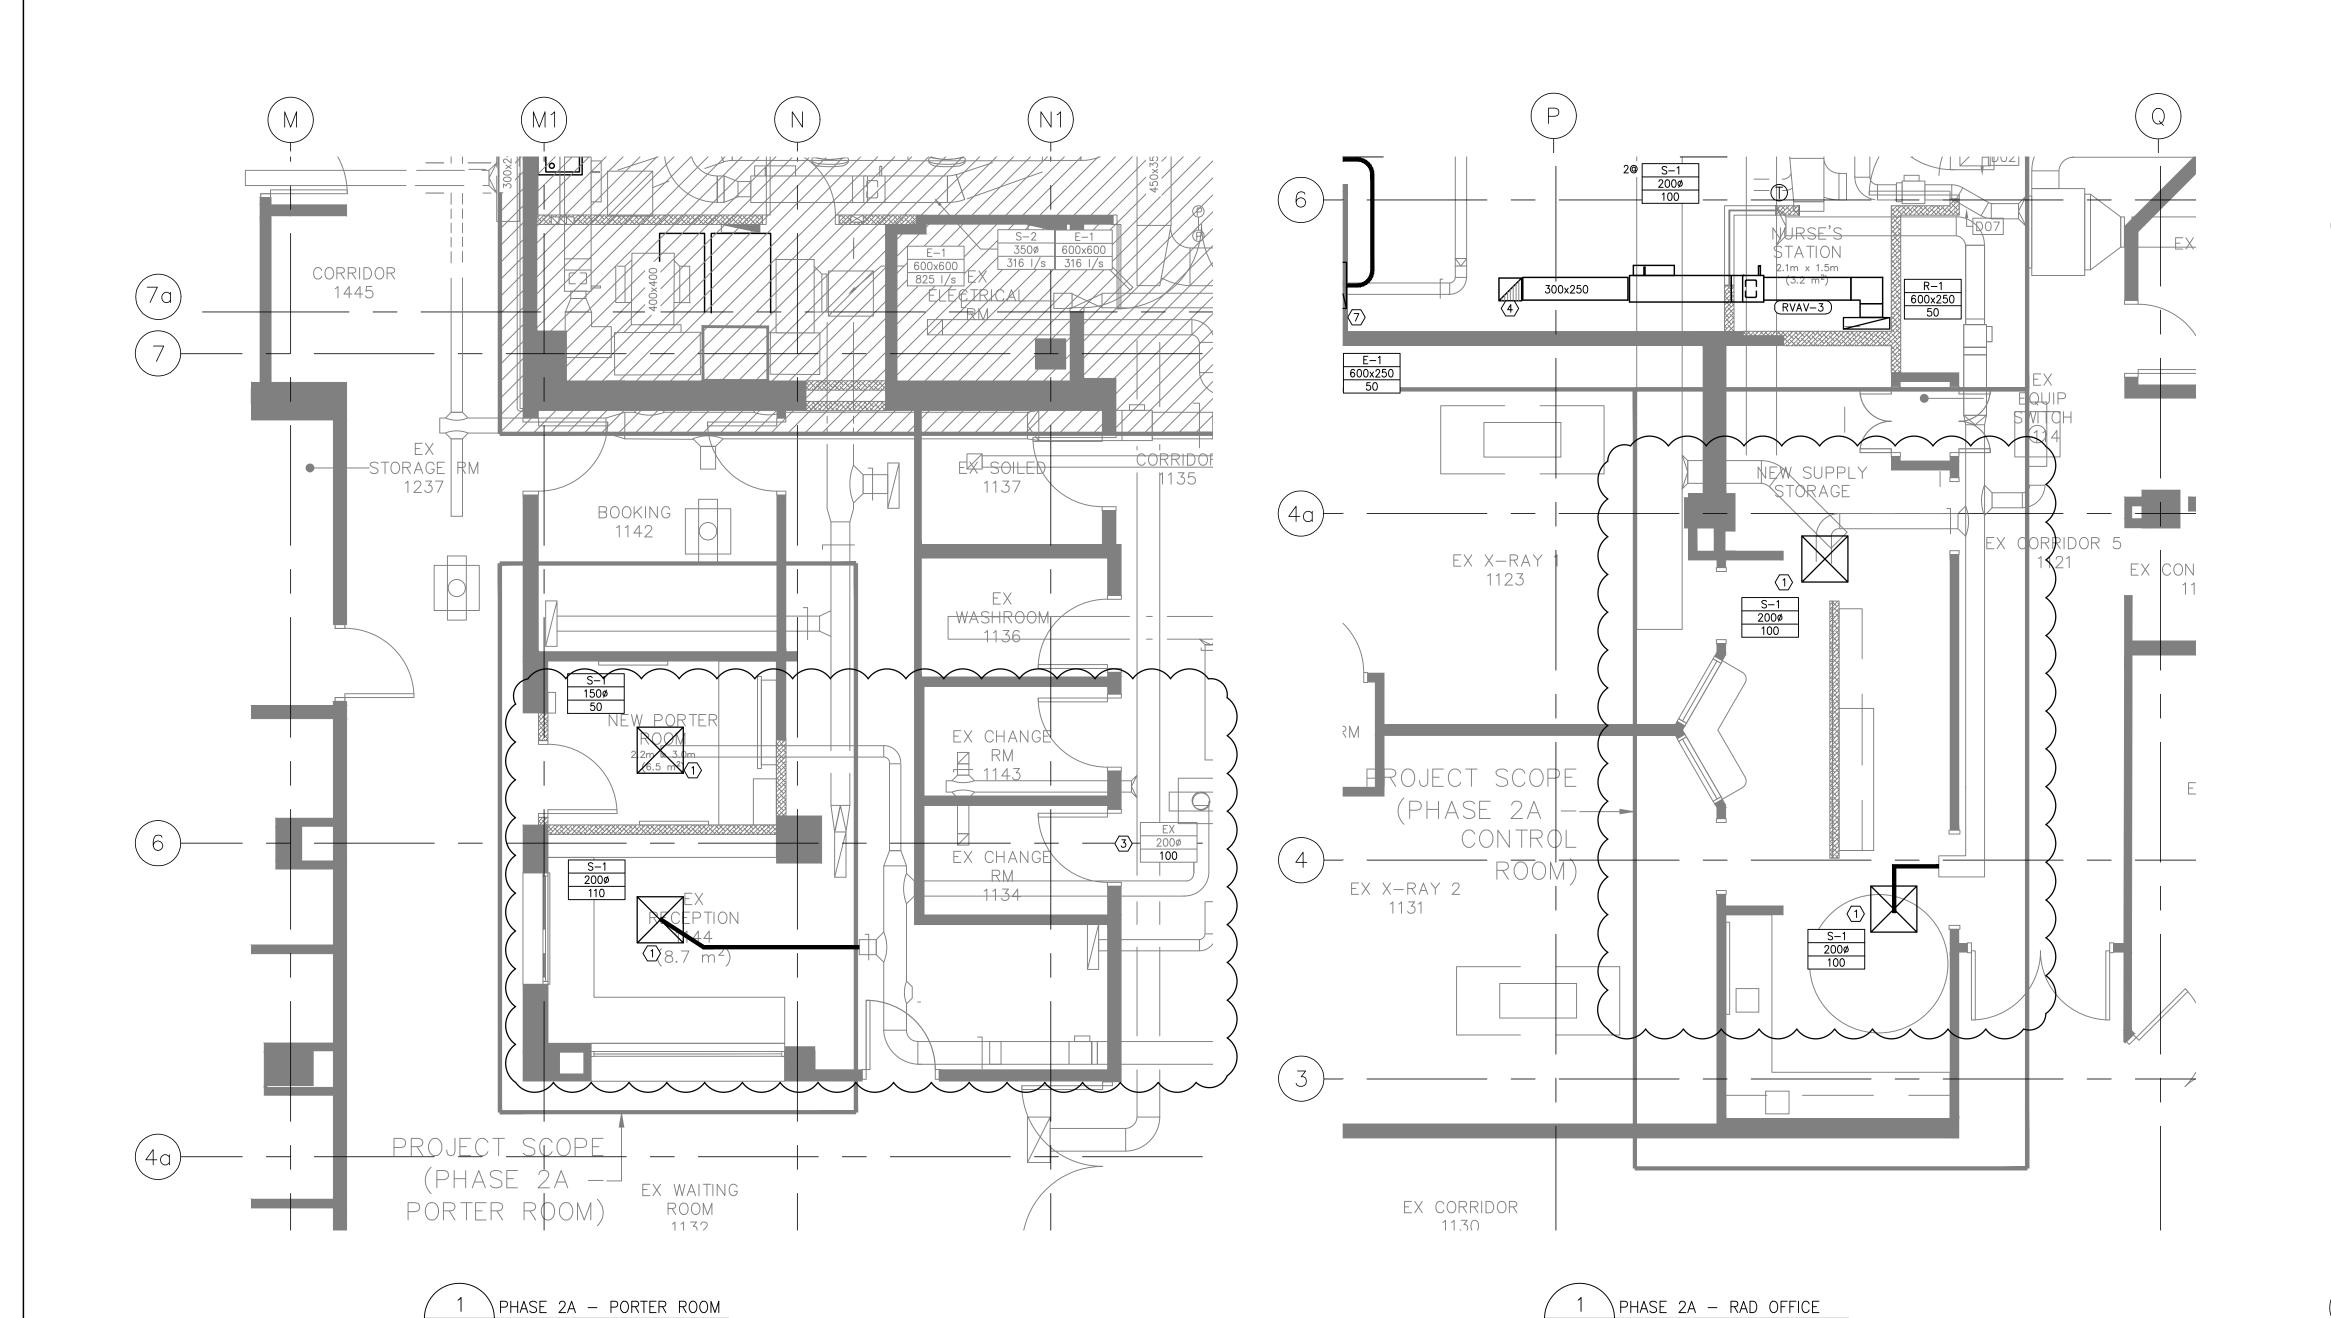
JL JOB No.: 20_002

EX OFFICE 1098 EX

1 \PHASE 2A - CONTROL ROOM

M1.301 SCALE: NTS



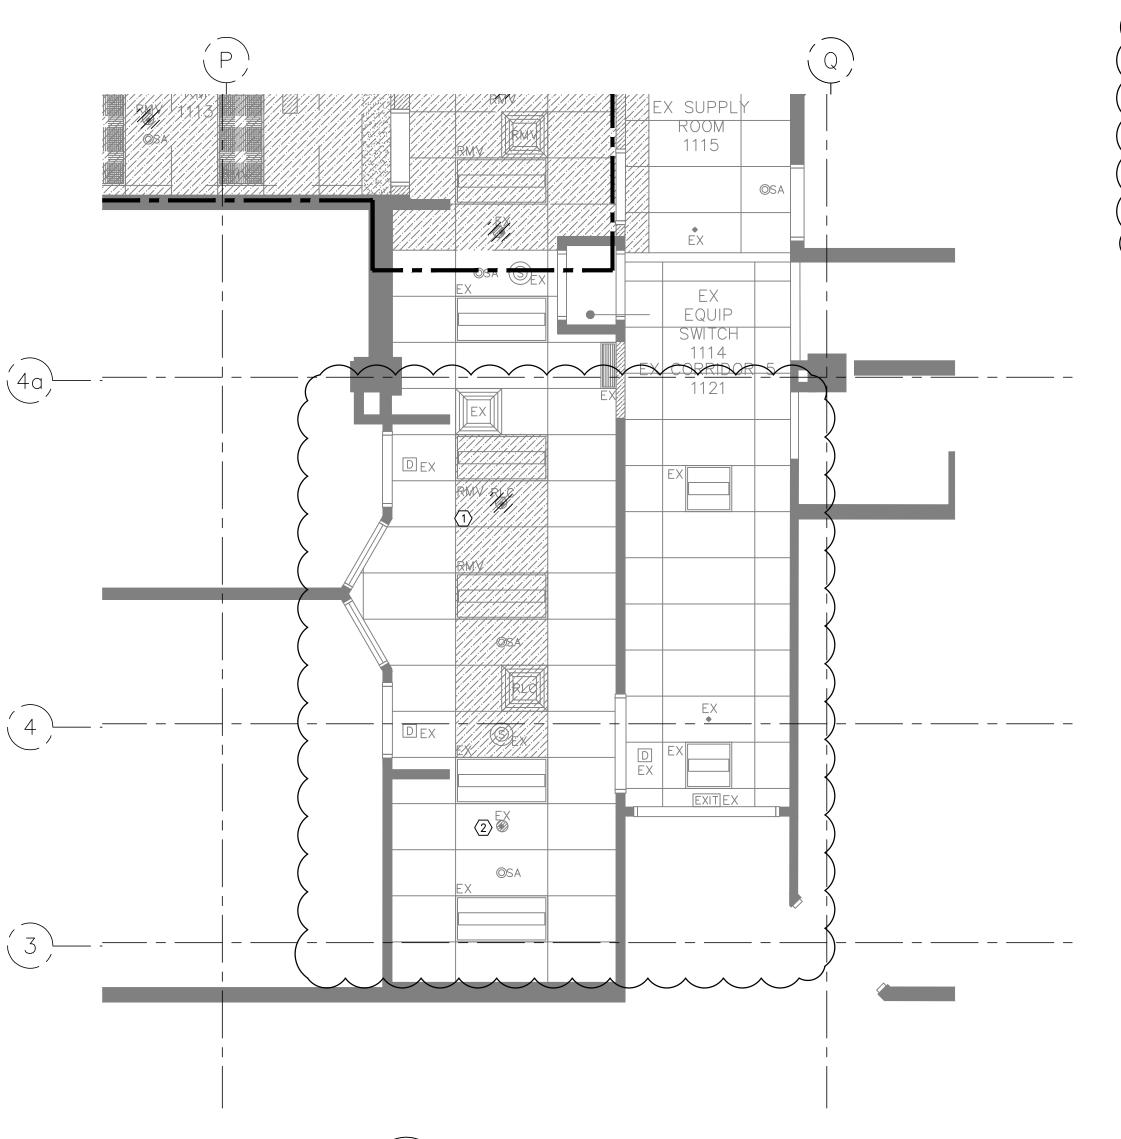

M2.201 SCALE: NTS

M2.201 SCALE: NTS

DRAWING NOTES

PROVIDE AND INSTALL NEW DIFFUSER AND MAKE CONNECTION TO EXISTING DUCT. REBALANCE AIRFLOWS INCLUDING EXISTING VAV BOX.

PROVIDE AND INSTALL NEW SUPPLY DIFFUSER C/W NEW LARGER DUCT BRANCH. REBALANCE AIRFLOWS AS SHOWN INCLUDING EXISTING VAV BOX

3 RABLANCE AIRFLOWS AS SHOWN.

DCYT

ARCHITECTURE

HEALTHCARE COMMERCIAL RESIDENTIAL INTERIOR DESIGNATION

HEALTHCARE COMMERCIAL RESIDENTIAL RESIDENTIAL

ARCHITECT :

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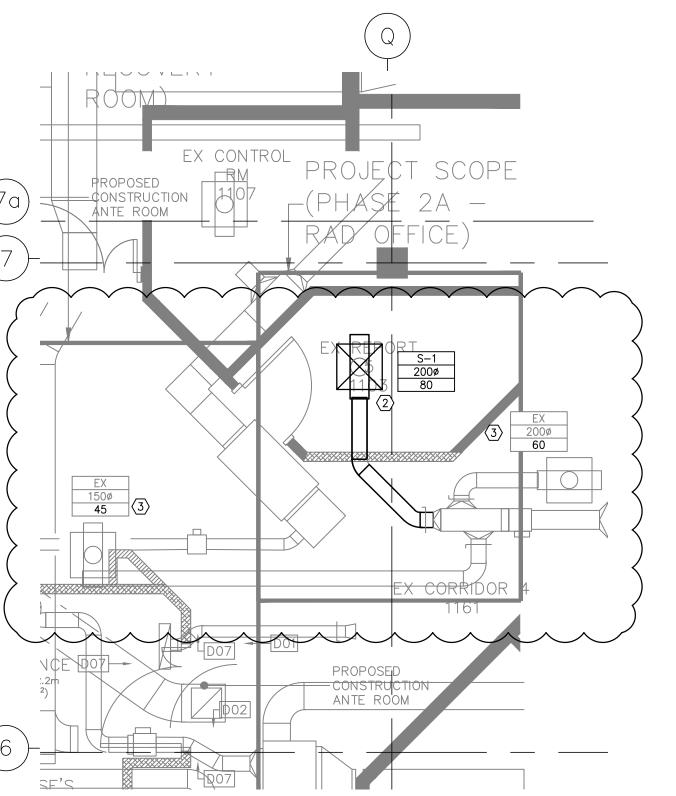
312 Main Street


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LEVEL 1 MECHANICAL PLAN

SCALE:

PHASE 2


06 2021

JUNE 06 2021
DRAWN:

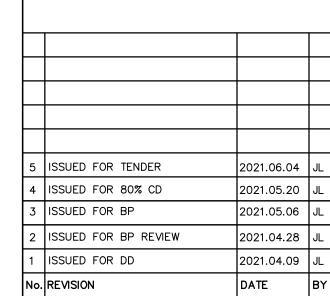
KM
CHECKED:

JL
JOB No.:
20_002

1 PHASE 2A - CONTROL ROOM M2.201 SCALE: NTS

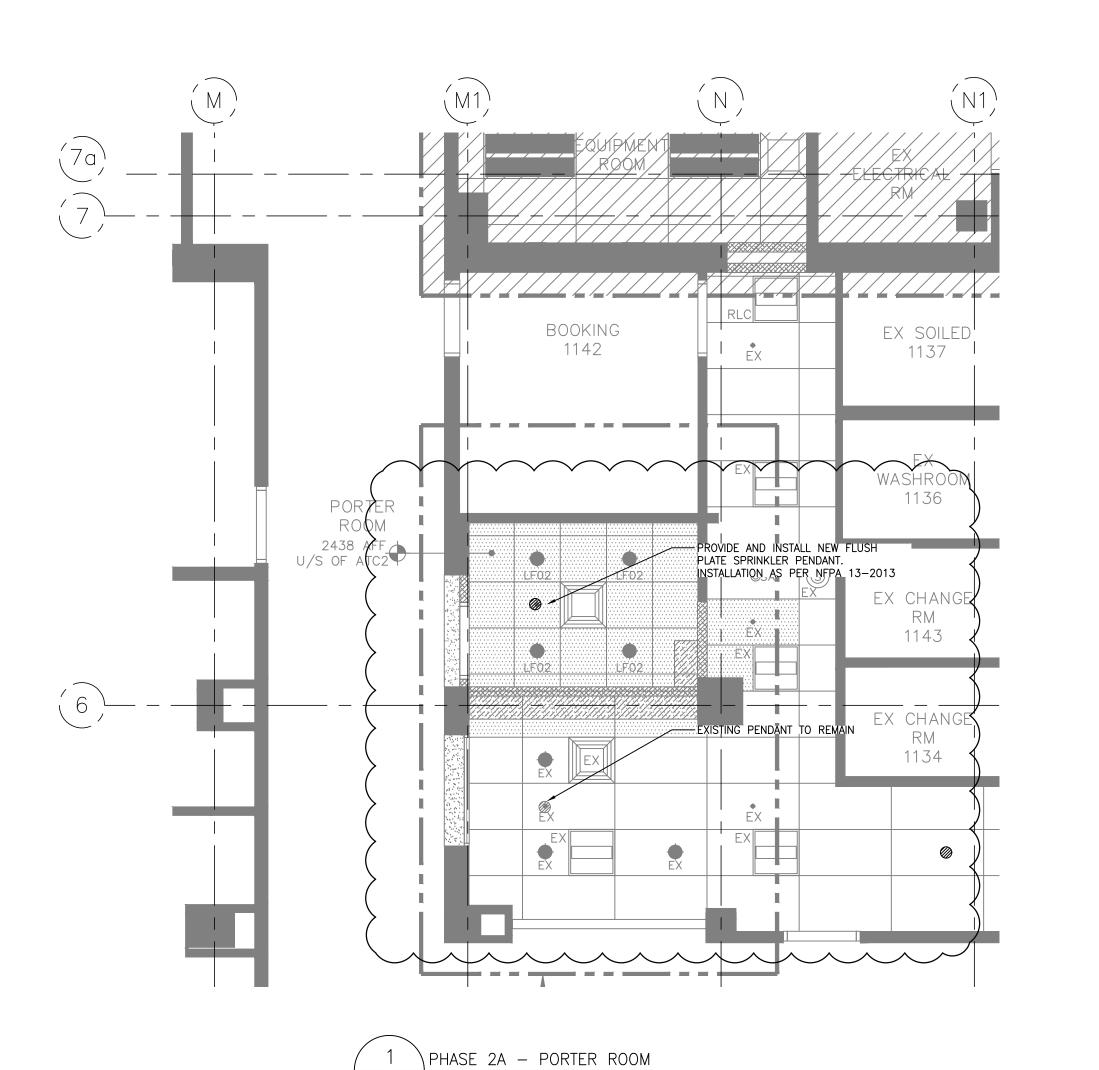

M2.301 SCALE: NTS

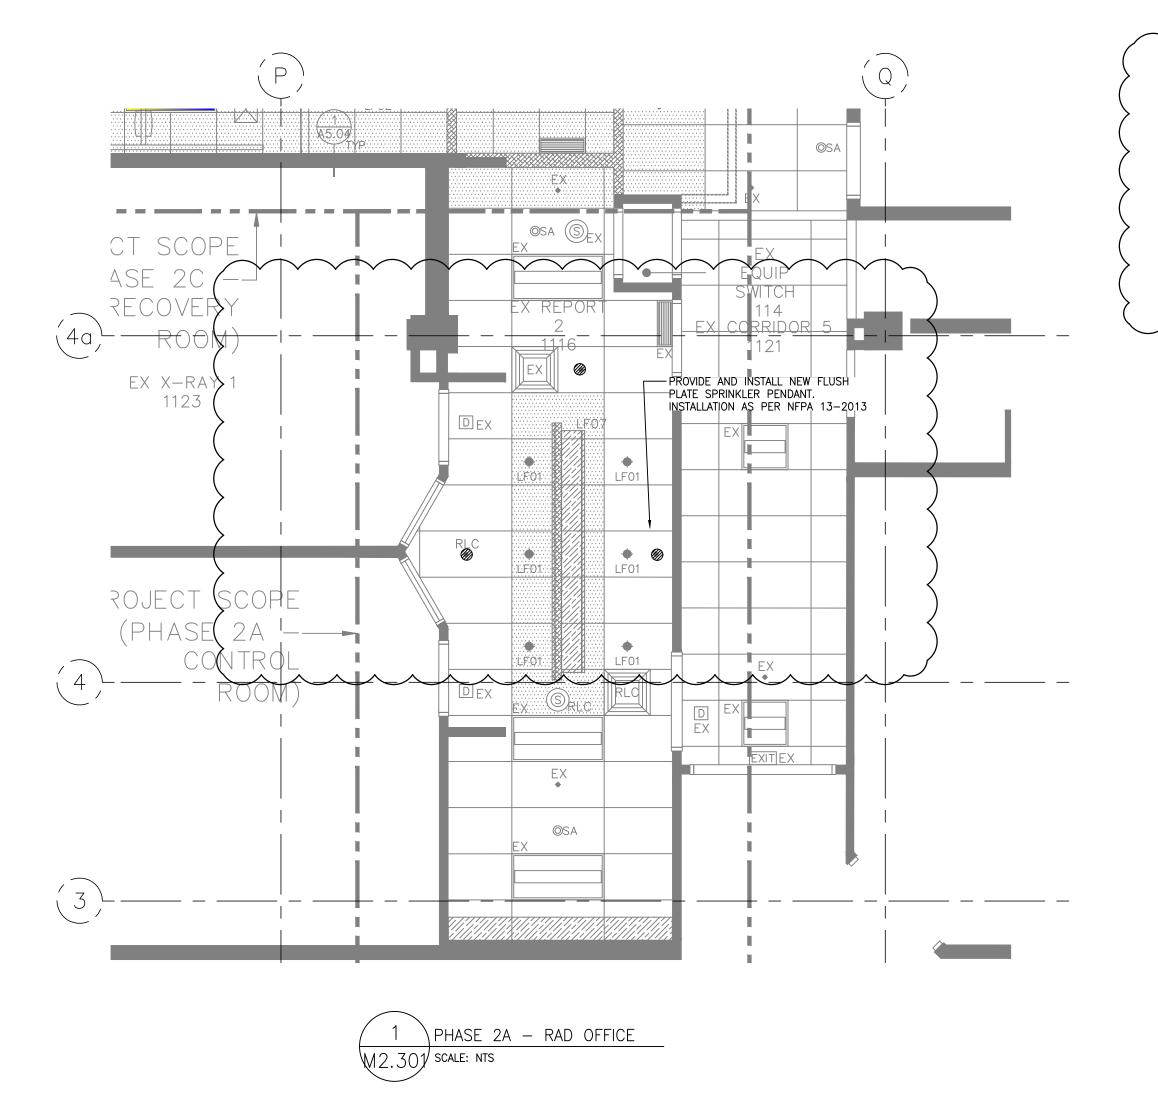

DRAWING NOTES

(A) DESIGN AND INSTALLATION TO BE AS PER NFPA-13 2013

(B) CONTRACTOR TO RETAIN A SPRINKLER ENGINEER TO DESIGN SPRINKLER LAYOUT TO SERVE THE RENOVATION AREA.

HAZARD: LIGHT HAZARD OCCUPANCY

COORDINATE WIT FMO, SHUTDOWN OF SPRINKLER ZONE IN ORDER TO OFFSET SPRINKLER MAINS. SUBMIT WORK PLAN TO FMO AND COORDINATE FIRE WATCH THROUGH DURATION OF SHUTDOWN.

WWW.DCYTARCHITECTURE.CA

ARCHITECT :

MECHANICAL CONSULTANT :



www.impacteng.ca

312 Main Street Vancouver, BC, V6A 2T2 (604) 200-9087

1 PHASE 2A - CONTROL ROOM M2.301 SCALE: NTS

5	ISSUED FOR TENDER	2021.06.04	JL
4	ISSUED FOR 80% CD	2021.05.20	JL
3	ISSUED FOR BP	2021.05.06	JL
2	ISSUED FOR BP REVIEW	2021.04.28	JL
1	ISSUED FOR DD	2021.04.09	JL
No.	REVISION	DATE	BY
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northern health

FLUOROSCOPY

REPLACEMENT

LEVEL 1 FIRE

JUNE 06 2021 DRAWN:

CHECKED:


JL JOB No.: 20_002


1475 EDMONTON STREET, PRINCE GEORGE BC V2M 1S2

SUPPRESSION PLAN PHASE

-M2.301

UHNBC

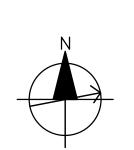

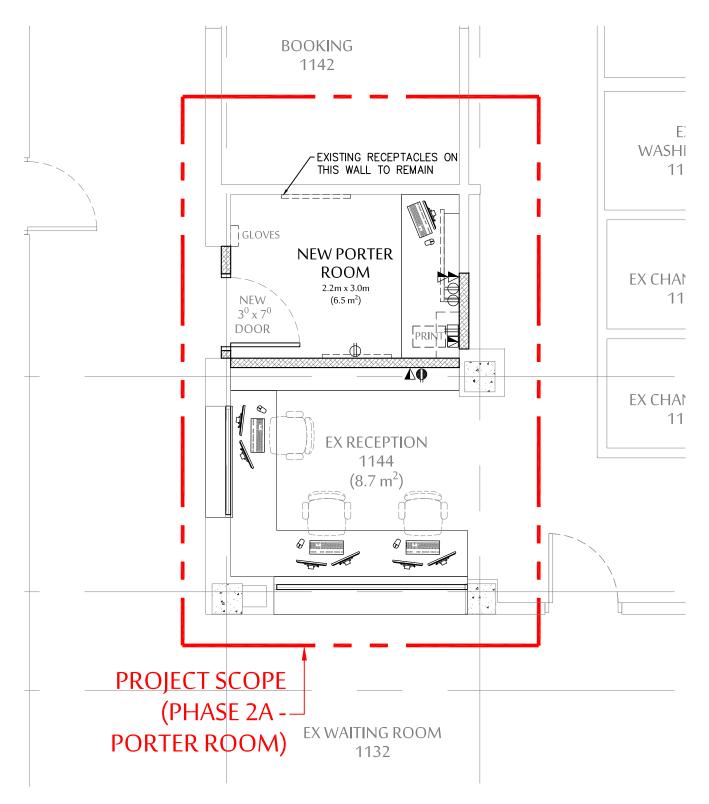



A1.19 CURTAIN

L----

EX X-RAY 1

PROJECT SCOPE

CONTROL ROOM)

EX X-RAY 2

1131

(PHASE 2A --

L----

1123

 (3.2 m^2)

NEW SUPPLY

STORAGE

EXISTING ELECTRICAL TO

REMAIN IN CONTROL AREAS

6' DIAM.

PHASE 2A - CONTROL ROOM CONSTRUCTION PLAN

← ALIGN



EX CORRIDC

STORAGE

1121

- COORDINATE ELECTRICAL INSTALLATION

WITH LEAD SHIELDING

-EXISTING RECEPTACLES ON

THIS WALL TO REMAIN



MODIFY EXISTING LIGHTING
WIRING TO BREAKOUT LIGHTS
IN PORTER ROOM

1142

REUSE EXISTING CIRCUITS FOR

NEW LIGHTING AND ADD
NEW MOTION DIMMER SWITCH

PORTER

ROOM

PROJECT SCOPE

(PHASE 2A --

PORTER ROOM) EX WAITING ROOM

♦ EX

1137

EX

1136


WASHROOM

EX CHANGE R

EX CHANGE R


1134


1143

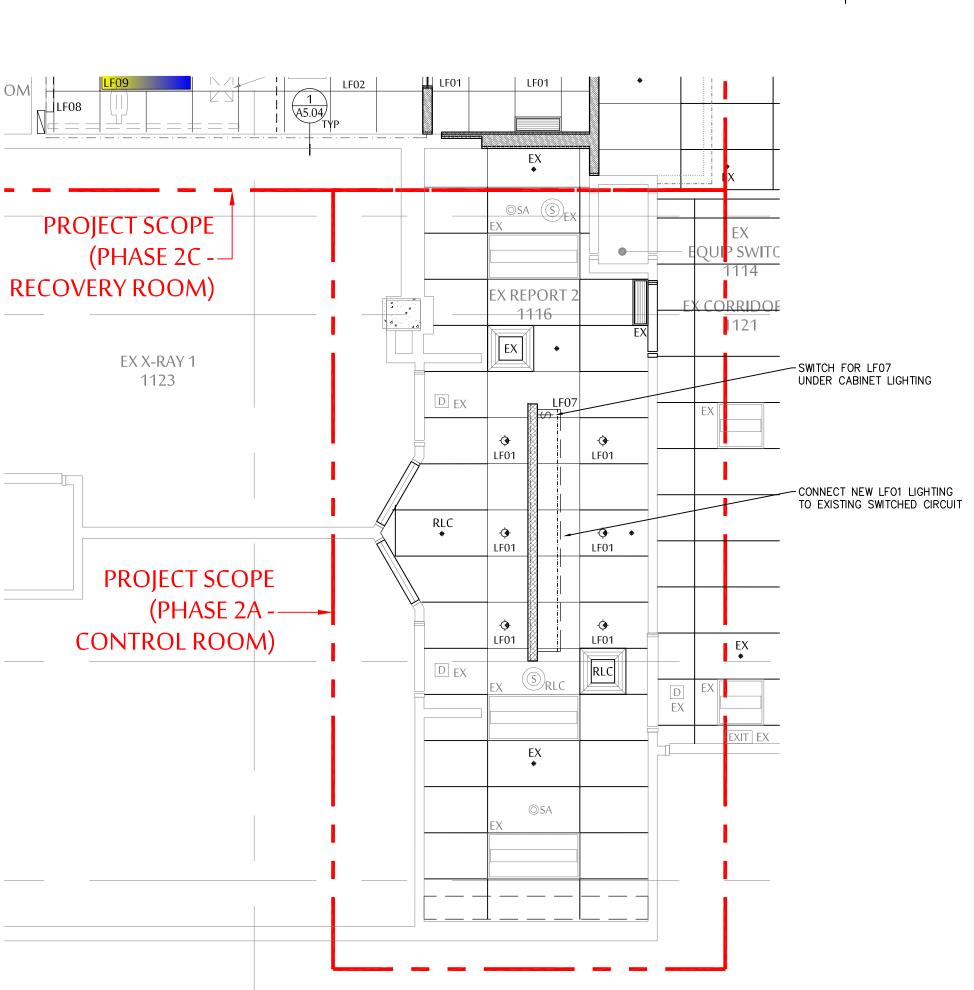

PHASE 2A - CONTROL ROOM REFLECTED CEILING PLAN


SCALE: 1 = 50

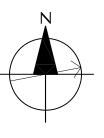

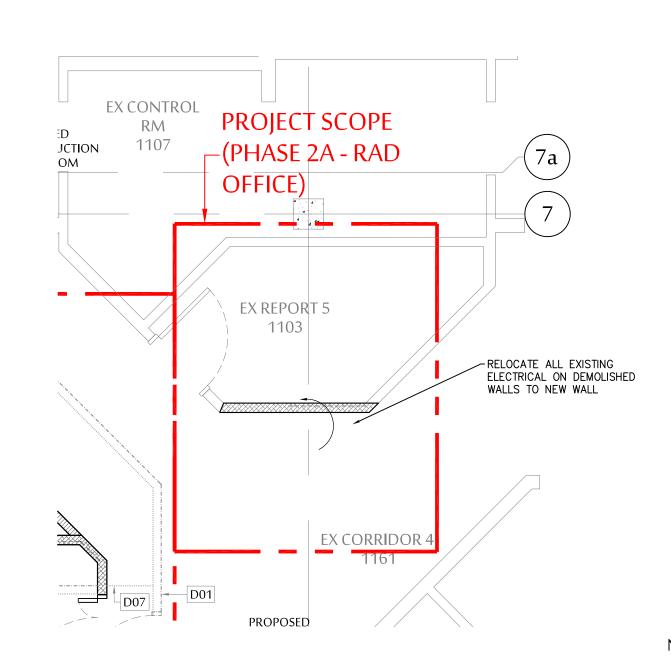





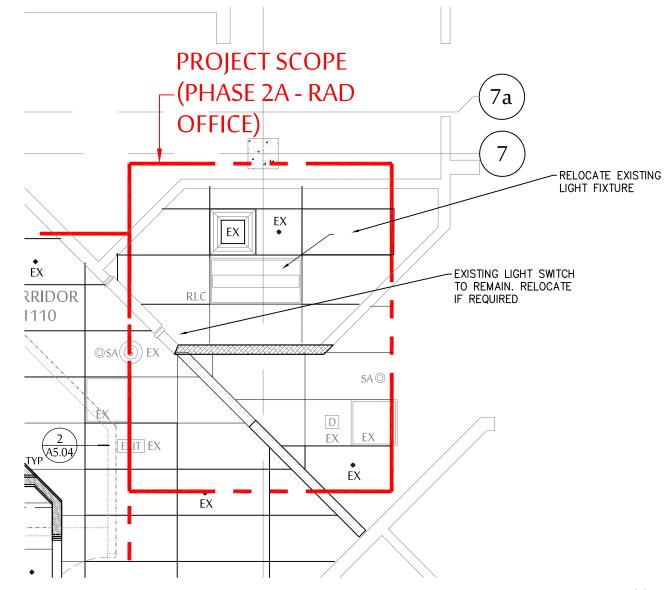

PHASE 2A - RAD OFFICE REFLECTED CEILING PLAN



NOTES:

SCALE: 1 = 50

1. REFER TO ARCHITECTURAL DRAWINGS FOR DEMOLITION PLANS AND LOCATIONS OF WORK AREAS. REMOVE ALL EXISTING ELECTRICAL EQUIPMENT ON WALLS AND CEILINGS BEING REMOVED OR MODIFIED.

2. EXISTING CIRCUITS MAY BE REUSED FOR NEW RECEPTACLES AND EQUIPMENT — SHOW CIRCUITS USED ON AS BUILT DRAWINGS. REMOVE ALL UNUSED BRANCH WIRING BACK TO NEAREST JUNCTION BOX. LABEL ANY UNUSED CIRCUITS AS 'SPARE' ON PANEL DIRECTORY AND TURN BREAKERS OFF.


3. EXISTING DATA WIRING MAY BE REUSED IF IT IS CATEGORY 6, OTHERWISE INSTALL NEW DATA WIRING. REMOVE ALL UNUSED DATA WIRING BACK TO RACK.



DCYT ARCHITECTURE HEALTHCARE. COMMERCIAL. RESIDENTIAL. INTERIOR DESIGN

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ARCHITECT:

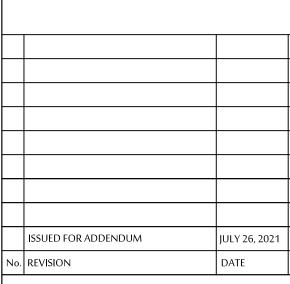

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UHNBC FLUOROSCOPY REPLACEMENT

1475 EDMONTON STREET, PRINCE GEORGE BC V2M 1S2

PHASE 2 - GEN FLUORO LEVEL 1 ADDITIONAL SCOPE

SCALE:	
1:50	
DATE:	
APRIL 2021	
DRAWN:	— DI I 4 6 F D
SY	PHASE 2
CHECKED:	$ \Gamma$ Γ Γ
DC	_ EZ.U3
JOB No.:	
NRS2674	

SCALE: 1 = 50