



H.H. Angus & Associates Limited Consulting Engineers 1127 Leslie Street, Toronto, ON, M3C 2J6 Canada www.hhangus.com | T 416 443 8200 | F 416 443 8290

## BushBohlman & Partners

**Consulting Structural Engineers** 

1550—1500 West Georgia St. Vancouver, BC V6G 2Z6


604 688 9861 bushbohlman.com


DISCREPANCIES MUST BE REPORTED IMMEDIATELY TO THE CONSULTANT BEFORE ONLY FIGURED DIMENSIONS ARE TO BE USED AND CONTRACTOR MUST CHECK ALL DIMENSIONS ON SITE.
THIS DRAWING IS PROTECTED BY COPYRIGHT.

$\triangle$			
NO.	DATE (YYYY-MM-DD)	DESCRIPTION	
	D	RAWING REVISIONS	

03	2023-12-11	ISSUED FOR TENDER	_
02	2023-11-17	ISSUED FOR 90% CD	
01	2023-10-27	ISSUED FOR 90% DD	
NO.	DATE (YYYY-MM-DD)	DESCRIPTION	
		DRAWING ISSUE	

KEYPLAN:

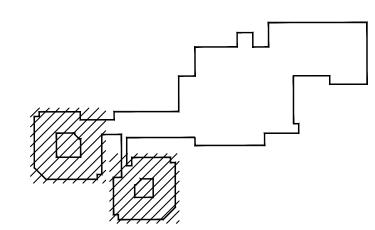

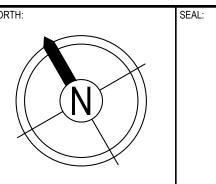


FORT ST. JOHN HOSPITAL RESIDENTIAL CARE COOLING **UPGRADE** 

HHA PROJECT NUMBER:

MECHANICAL LEGEND & DRAWING LIST

PAGE SIZE: ARCH D DRAWN BY: J.O'S. CHECKED BY: M.W.

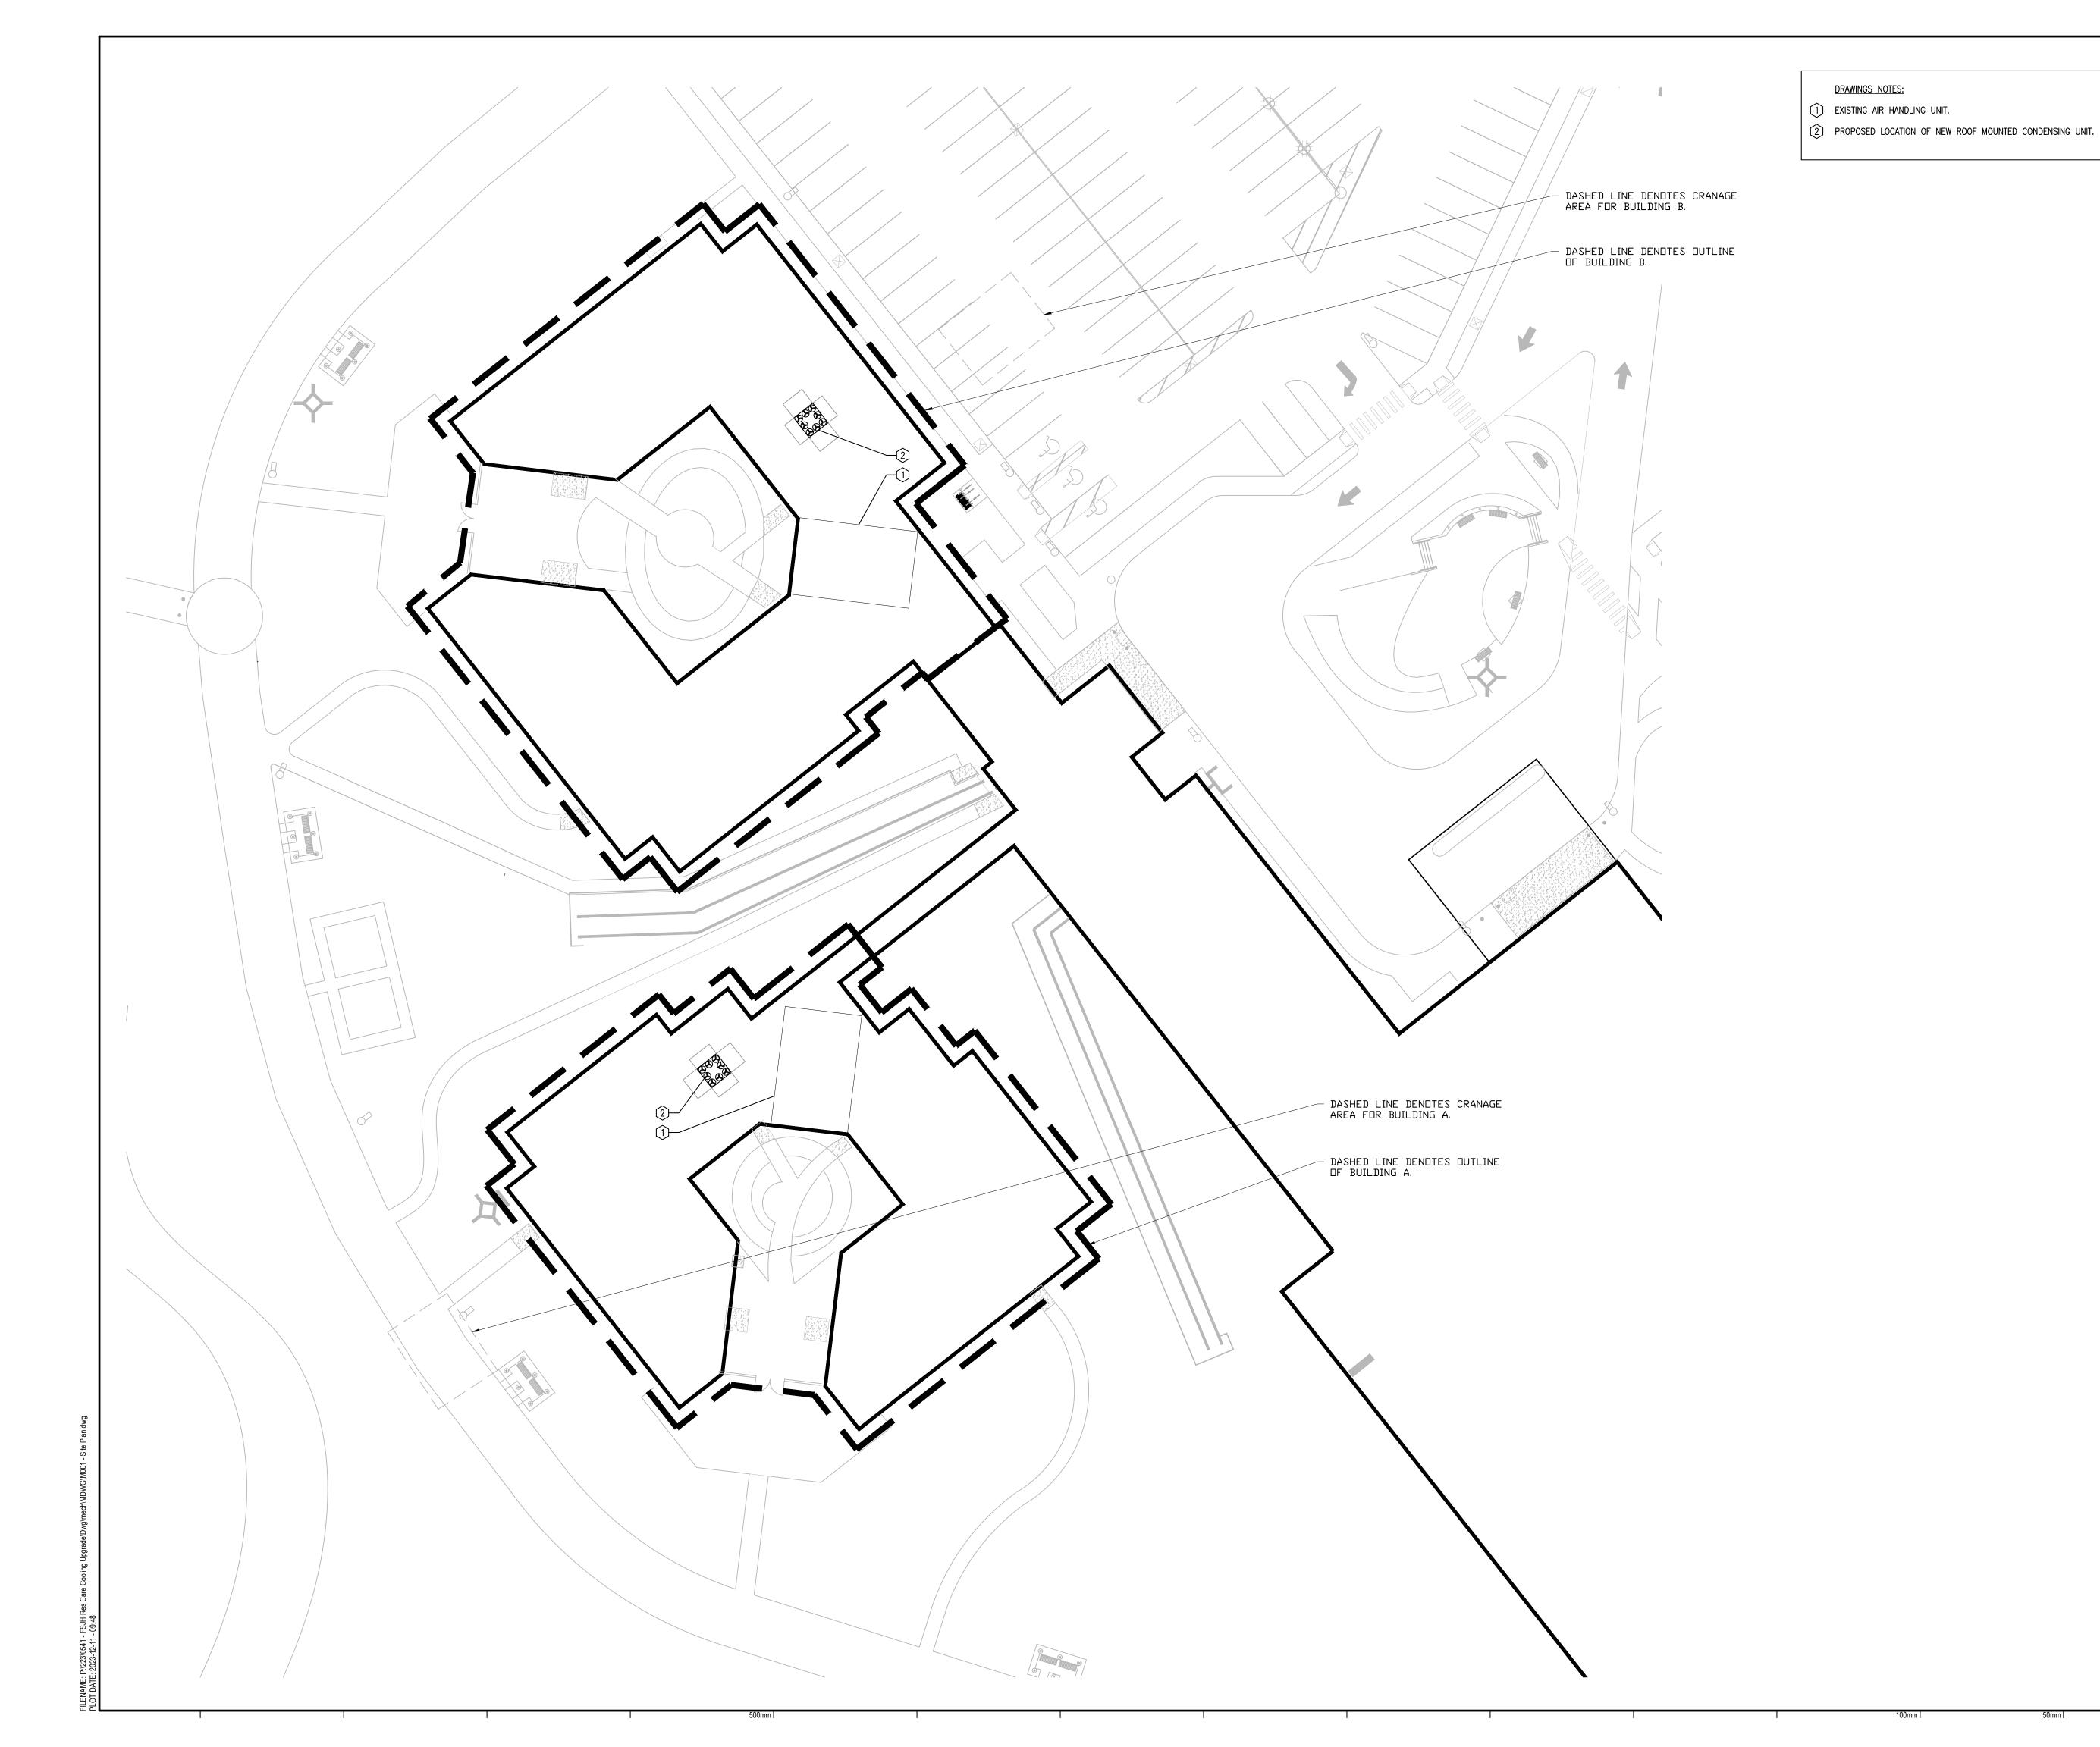



H.H. Angus & Associates Limited Consulting Engineers 1127 Leslie Street, Toronto, ON, M3C 2J6 Canada www.hhangus.com | T 416 443 8200 | F 416 443 8290

## BushBohlman & Partners

**Consulting Structural Engineers** 

1550—1500 West Georgia St. Vancouver, BC V6G 2Z6


604 688 9861 bushbohlman.com

DISCREPANCIES MUST BE REPORTED IMMEDIATELY TO THE CONSULTANT BEFORE PROCEEDING.
ONLY FIGURED DIMENSIONS ARE TO BE USED AND CONTRACTOR MUST CHECK ALL DIMENSIONS ON SITE.
THIS DRAWING IS PROTECTED BY COPYRIGHT.

NO. DATE (YYYY-MM-DD) DESCRIPTION

DRAWING REVISIONS

03	2023-12-11	ISSUED FOR TENDER	
02	2023-11-17	ISSUED FOR 90% CD	
01	2023-10-27	ISSUED FOR 90% DD	
NO.	DATE (YYYY-MM-DD)	DESCRIPTION	
		DRAWING ISSUE	

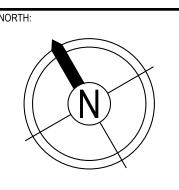


FORT ST. JOHN HOSPITAL RESIDENTIAL CARE COOLING **UPGRADE** 


HHA PROJECT NUMBER:
DRAWING TITLE:
SITE PLAN

PAGE SIZE: ARCH D

SCALE: 1:300


DRAWING NUMBER: DRAWN BY: J.O'S. CHECKED BY: M.W.

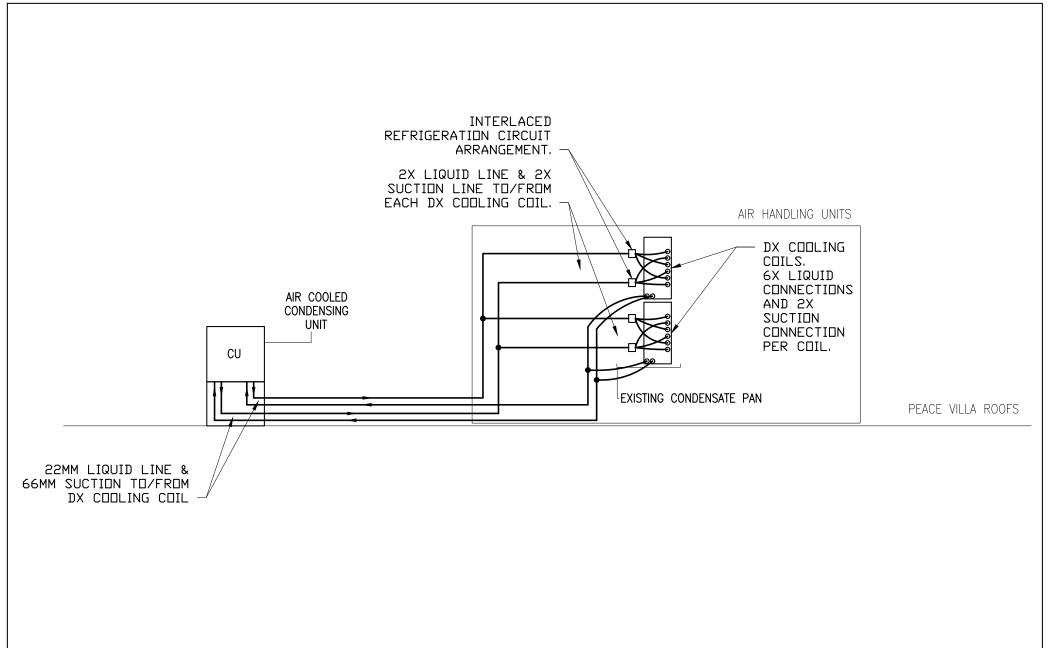

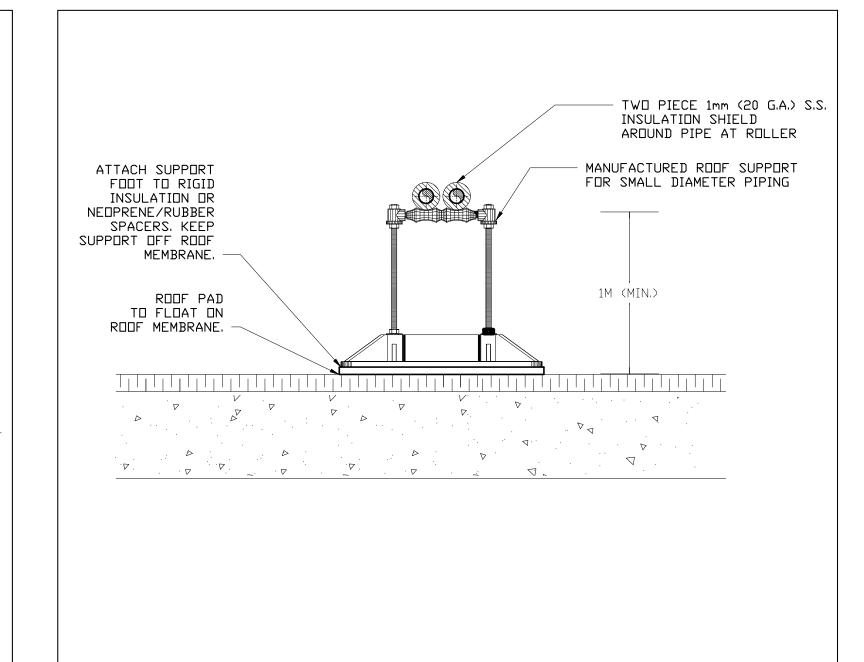

2 CONDENSING UNIT & DX COOLING COIL PIPING DETAIL M002 N.T.S.

, REFRIGERATION PIPING SUPPORT DETAIL M002 N.T.S.

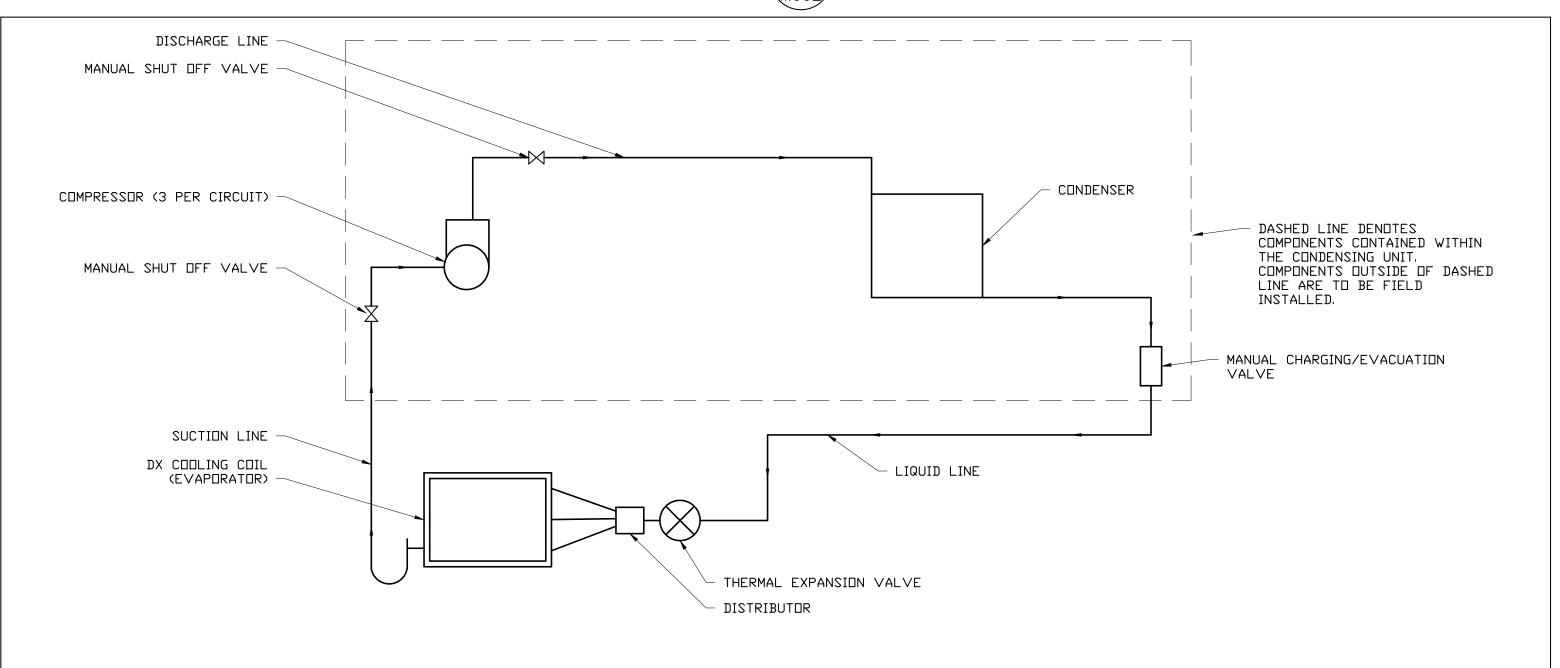

3 REFRIGERATION CIRCUIT SCHEMATIC DETAIL



H.H. Angus & Associates Limited Consulting Engineers 1127 Leslie Street, Toronto, ON, M3C 2J6 Canada www.hhangus.com | T 416 443 8200 | F 416 443 8290



Consulting Structural Engineers

1550—1500 West Georgia St. 604 688 9861 Vancouver, BC V6G 2Z6 bushbohlman.com

DISCREPANCIES MUST BE REPORTED IMMEDIATELY TO THE CONSULTANT BEFORE ONLY FIGURED DIMENSIONS ARE TO BE USED AND CONTRACTOR MUST CHECK ALL DIMENSIONS ON SITE.
THIS DRAWING IS PROTECTED BY COPYRIGHT.


$\overline{}$			
/\			
<u> </u>			
NO.	DATE (YYYY-MM-DD)	DESCRIPTION	
	П	RAWING REVISIONS	
		TO TOTAL VIOLENCE OF THE PROPERTY OF THE PROPE	
03	2023-12-11	ISSUED FOR TENDER	

NO. DATE (YYYY-MM-DD) DESCRIPTION DRAWING ISSUE

02 2023-11-17

01 2023-10-27

ISSUED FOR 90% CD ISSUED FOR 90% DD

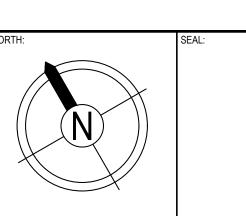



FORT ST. JOHN HOSPITAL RESIDENTIAL CARE COOLING **UPGRADE** 

HHA PROJECT NUMBER:

MECHANICAL DETAILS I

DRAWN BY: J.O'S. PAGE SIZE: ARCH D CHECKED BY: M.W.

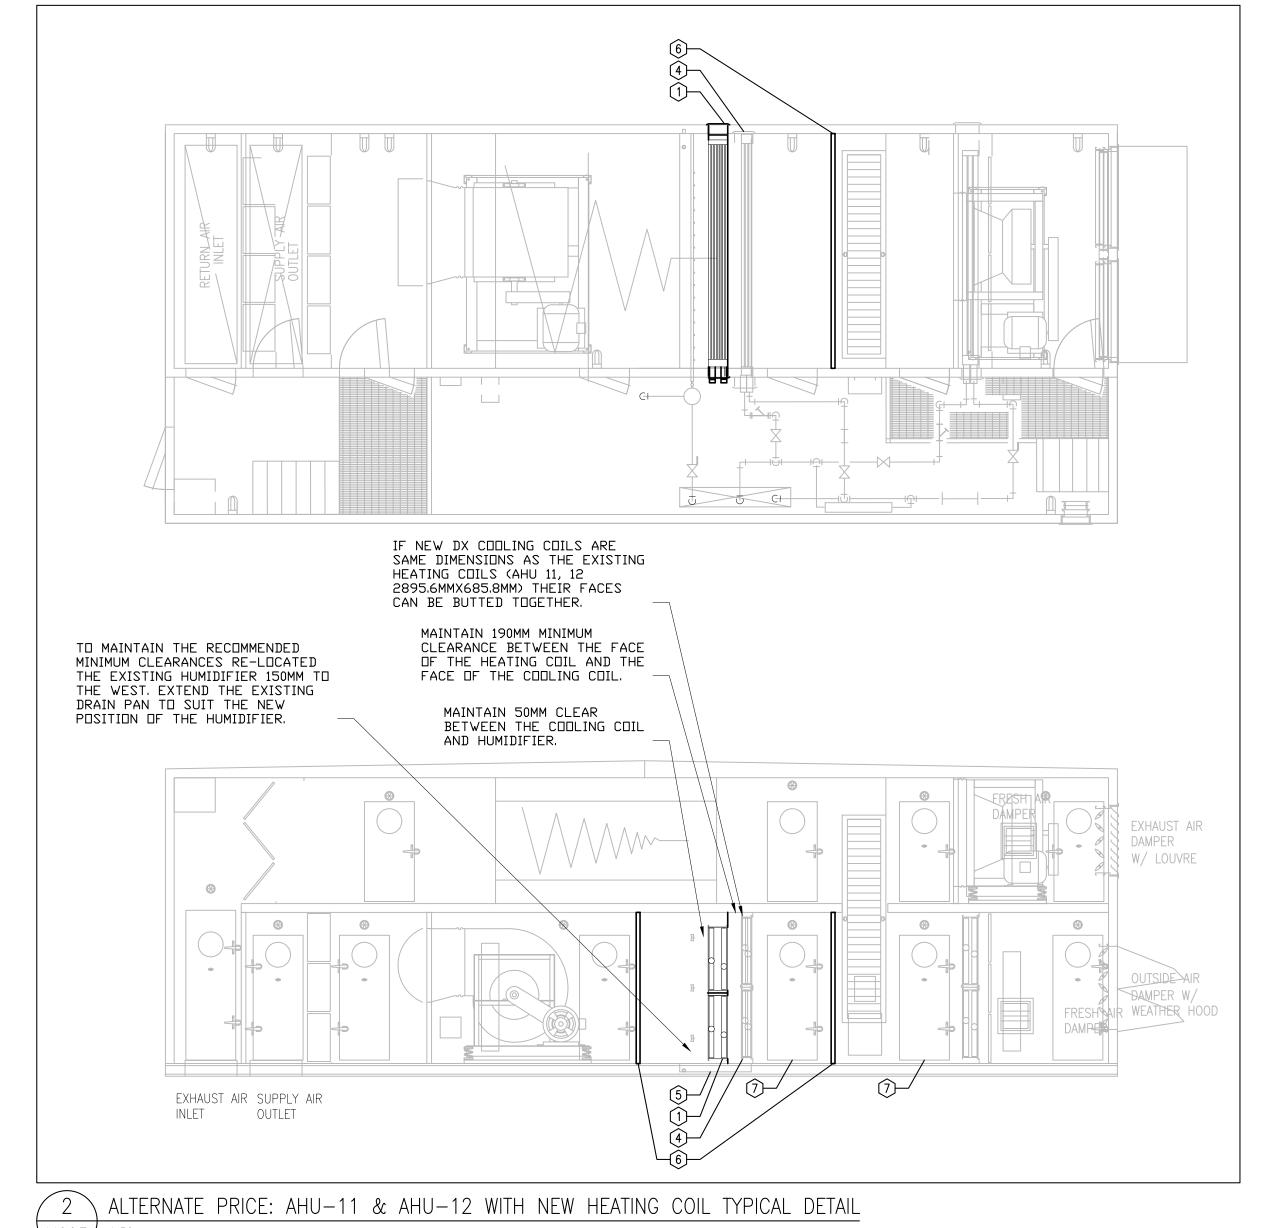

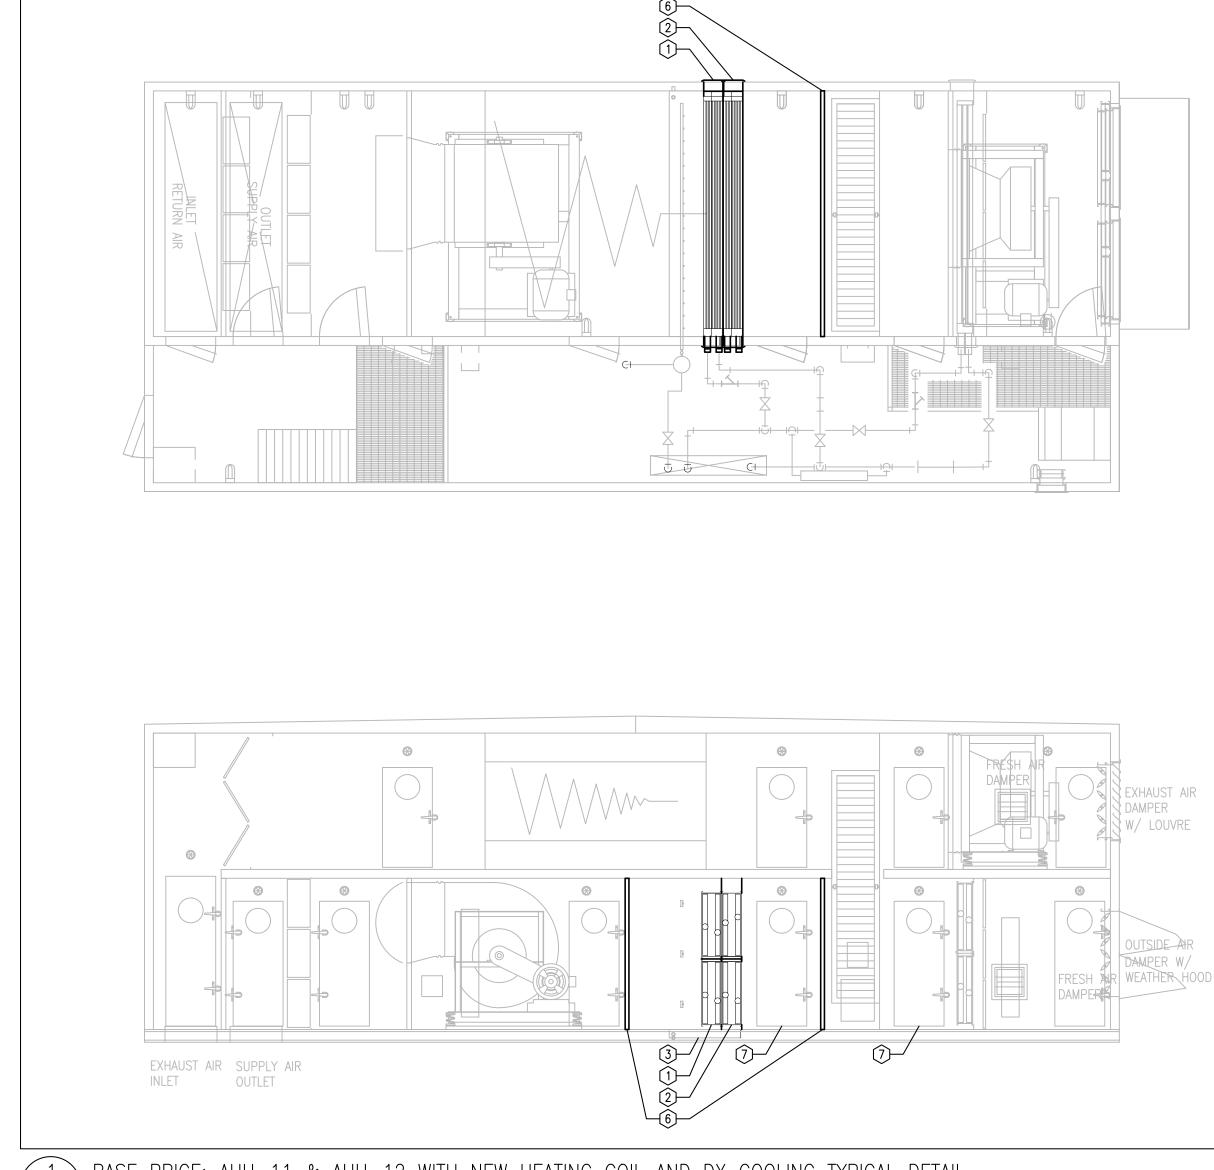

 $oxed{1}$  Base Price: AHU-11 & AHU-12 With NEW HEATING COIL AND DX COOLING TYPICAL DETAIL

DEMOLITION AND CONSTRUCTION SEQUENCING NOTES:

BIDDERS ARE TO PROVIDE TWO SEPARATE PRICES AND SCHEDULES FOR THE FOLLOWING

WORK TO BE PLANNED AND SEQUENCED TO MINIMIZE IMPACT TO THE OPERATION OF THE FACILITY AND LIMIT DOWNTIME.

### BASE PRICE:

- INSTALL A NEW CONDENSING UNIT ON EACH BUILDING. INSTALL REFRIGERATION PIPING UP TO THE AIR HANDLING UNITS, CAP OFF AND SEAL REFRIGERATION
- SHUT DOWN AIR HANDLING UNITS. SEAL OFF EACH SIDE OF THE HEATING COIL AIRTIGHT, SEAL LOCATIONS MARKED IN DETAIL 1/M003 START UP EXHAUST FAN AND RUN AT LOWER CAPACITY. EXHAUST FAN OPERATION TO BE DETERMINED IN CONJUNCTION WITH THE OWNER TO DETERMINE THE APPROPRIATE SET POINT AT THE PLANNED TIME OF SHUT DOWN.
- DISCONNECT THE EXISTING HEATING COIL CONNECTION AND CAP OFF. DEMOLISH AND REMOVE THE EXISTING HEATING COIL FROM SITE. SLIDE IN NEW DX COOLING COIL AND HEATING COIL AS A BLOCK. REINSTATE AND SEAL. CONNECT THE EXISTING HYDRONIC PIPING TO THE NEW COIL AND THE NEW REFRIGERANT PIPING TO THE NEW DX COOLING COIL.

#### ALTERNATE PRICE:

- INSTALL A NEW CONDENSING UNIT ON EACH BUILDING. INSTALL REFRIGERATION PIPING UP TO THE AIR HANDLING UNITS, CAP OFF AND SEAL REFRIGERATION
- SHUT DOWN AIR HANDLING UNITS. SEAL OFF EACH SIDE OF THE HEATING COIL AIRTIGHT, SEAL LOCATIONS MARKED IN DETAIL 2/M003 START UP EXHAUST FAN AND RUN AT LOWER CAPACITY. EXHAUST FAN OPERATION TO BE DETERMINED IN CONJUNCTION WITH THE OWNER TO DETERMINE THE APPROPRIATE SET POINT AT THE PLANNED TIME OF SHUT DOWN.
- RELOCATE THE EXISTING HUMIDIFIERS TO MAINTAIN THE MINIMUM CLEARANCES BETWEEN THE EXISTING HEATING COIL, NEW DX COOLING COIL AND EXISTING HUMIDIFIER LISTED ABOVE IN DETAIL 2/MOO3. EXTEND THE DRAIN PAN TO MATCH THE NEW POSITION OF THE HUMIDIFIER. DRIP PAN PROTRUSION DISTANCE UNDER
- HUMIDIFIER TO WARDS SUPPLY FAN TO MATCH PRE-CONSTRUCTION DISTANCE. SLIDE IN NEW DX COOLING COIL INTO THE AIR HANDLING UNIT. REINSTATE AND SEAL. CONNECT THE NEW REFRIGERANT PIPING TO THE NEW DX COOLING COIL.

#### **DRAWINGS NOTES:**

- 1 NEW HEATING COIL. RE-USE EXISTING CONNECTIONS.
- (2) NEW DX COOLING COIL.
- (3) RE-USE EXISTING DRAIN PAN.
- (4) EXISTING HEATING COIL.
- (5) MODIFY EXISTING DRAIN PAN TO NEW EQUIPMENT LAYOUT. EXTEND AS NECESSARY TO SUIT NEW POSITION OF HUMIDIFIER.
- 6 PARTITION DURING CONSTRUCTION.
- (7) ENSURE AHU DOOR IS OPEN WHILE EXHAUST FAN IS RUNNING.



H.H. Angus & Associates Limited Consulting Engineers 1127 Leslie Street, Toronto, ON, M3C 2J6 Canada www.hhangus.com | T 416 443 8200 | F 416 443 8290



**Consulting Structural Engineers** 

1550—1500 West Georgia St. Vancouver, BC V6G 2Z6

DIMENSIONS ON SITE.
THIS DRAWING IS PROTECTED BY COPYRIGHT.

bushbohlman.com DISCREPANCIES MUST BE REPORTED IMMEDIATELY TO THE CONSULTANT BEFORE


ONLY FIGURED DIMENSIONS ARE TO BE USED AND CONTRACTOR MUST CHECK ALL

604 688 9861

NO. DATE (YYYY-MM-DD) DESCRIPTION DRAWING REVISIONS

ISSUED FOR TENDER 03 2023-12-11 02 2023-11-17 ISSUED FOR 90% CD ISSUED FOR 90% DD 01 2023-10-27 NO. DATE (YYYY-MM-DD) DESCRIPTION

DRAWING ISSUE

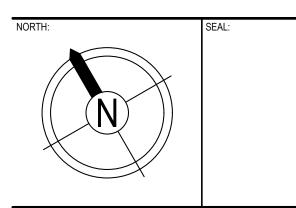

FORT ST. JOHN HOSPITAL RESIDENTIAL CARE COOLING **UPGRADE** 

2230541

HHA PROJECT NUMBER:

MECHANICAL DETAILS II

PAGE SIZE: ARCH D DRAWN BY: J.O'S. CHECKED BY: M.W.

### SPLIT SYSTEM OUTDOOR CONDENSING UNIT SCHEDULE

															PO	WER SUP	PPLY			STARTE	R		со	NTROLS	ОТ	HER REQUIREMENTS		1
TAG	COOLING COIL TAG	DESCRIPTION/ SERVICE	LOCATION	MANUFACTURER	MODEL	NOMINAL CAPACITY	REFRIGERANT	DESIGN AMBIENT TEMP.	MIN. AMBIENT TEMP. (°C)	SEER	EER	MECHANICAL REMARKS	(A)	(A)	(A)	SE			S	UPPLIED INST.	ALLED BY	Ä	- O	INTERLO BY	OCK W.F	. DISC AT F.A.	HERS	ELECTRICAL REMARKS
	COIL TAG	SERVICE				(TON)		(°F)	TEWIL (O)				MOP	MCA	FLA	PHA	무	FED FROM   ≧	NO DI	3   26   23	DIV. 26	TYF	MAI	DIV. 23	DISC. DIV. MOTO 26	MOTOR SHUT DOWN	OT	KLWAKKO
CU-2	CC-311	AHU-11 COOLING	BUILDING B ROOF	DAIKIN	RCS072D	60	R410A		7.2	12.06	10.6	NOTE 1, 2	110	101.5	575	5 3	60	PP-R1-LL1	•				•	•		DIV. 26		
CU-3	CC-312	AHU-12 COOLING	BUILDING A ROOF	DAIKIN	RCS072D	60	R410A		7.2	12.06	10.6	NOTE 1, 2	110	101.5	575	5 3	60	PP-R0-DD1	•				•	•		DIV. 26		

NOTES: 1. COOLING ONLY.

2. UNIT WEIGHT 1,601 KG MAXIMUM.

3. MOUNTED ON VIBRATION RESTRAINED SPRING ISOLATORS. TYPE FLSS.

### HYDRONIC HEATING COIL

TAG	OUTDOOR UNIT TAG	DESCRIPTION/ SERVICE	LOCATION	MANUFACTURER	MODEL	DESIGN MAX AIRFLOW (L/S)	E.S.P. (PA)	WATER P.D. (KPA)	TOTAL CAPACITY (KW)	E.A.T DB (°F)	E.W.T. (°F)	L.A.T. DB (°F)	L.W.T. (°F)	MECHANICAL REMARKS
HC-311(A/B)	CU-2	AHU-11 HEATING	AHU-11	DAIKIN	5WS1302B	10,406	54.7	3.9	328.7	-12.6	68	13.2	34.4	1
HC-312(A/B)	CU-3	AHU-12 HEATING	AHU-12	DAIKIN	5WH1202B	9,406	52.2	40.9	421.4	-22.9	68	13.7	34.2	1

NOTES: 1. 55% GLYCOL CONCENTRATION.

DX COOL	ING CO	IL .											
TAG	OUTDOOR UNIT TAG	DESCRIPTION/ SERVICE	LOCATION	MANUFACTURER	MODEL	DESIGN MAX AIRFLOW (CFM)	E.S.P. (PA)	NOMINAL TONNES	TOTAL CAPACITY (TONS)	SENSIBLE CAPACITY (TONS)	E.A.T DB/WB (°C)	L.A.T DB/WB (°C)	MECHANICAL REMARKS
CC-311(A/B)	CU-2	AHU-11 COOLING	AHU-11	DAIKIN	5EJ1004B	10,406	131.8		60.0	41.8	26.7/19.4	15.1/13.7	NOTE 1
CC-312(A/B)	CU-3	AHU-12 COOLING	AHU-12	DAIKIN	5EJ0706B	9,406	159.3		60.0	40.8	26.7/19.7	14.2/12.9	NOTE 1
NOTES: 1. TYPE "FD" REF	FRIGERANT COC	DLING COIL.						•			•		

INSTRUCTIONS FOR BIDDERS:

CONTRACTORS ARE TO PROVIDE TWO SEPARATE PRICES FOR THE FOLLOWING OPTIONS. BASE PRICE: INCLUDES PRICING FOR THE CONDENSING UNITS, DX COOLING COILS, AND HEATING COILS.

ALTERNATE PRICE: INCLUDES PRICING FOR THE CONDENSING UNITS AND DX COOLING COILS.



H.H. Angus & Associates Limited Consulting Engineers 1127 Leslie Street, Toronto, ON, M3C 2J6 Canada www.hhangus.com | T 416 443 8200 | F 416 443 8290



Consulting Structural Engineers 1550—1500 West Georgia St.


604 688 9861 Vancouver, BC V6G 2Z6 bushbohlman.com

DISCREPANCIES MUST BE REPORTED IMMEDIATELY TO THE CONSULTANT BEFORE ONLY FIGURED DIMENSIONS ARE TO BE USED AND CONTRACTOR MUST CHECK ALL DIMENSIONS ON SITE.
THIS DRAWING IS PROTECTED BY COPYRIGHT.


NO. DATE (YYYY-MM-DD) DESCRIPTION DRAWING REVISIONS

03 2023-12-11 ISSUED FOR TENDER 02 2023-11-17 ISSUED FOR 90% CD 01 2023-10-27 ISSUED FOR 90% DD

NO. DATE (YYYY-MM-DD) DESCRIPTION

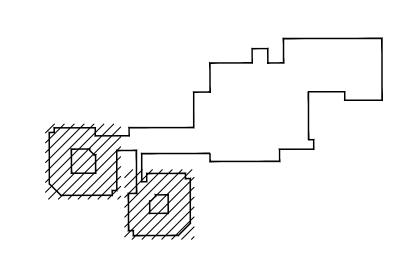

DRAWING ISSUE

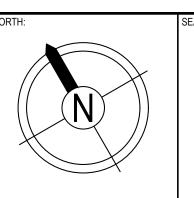


FORT ST. JOHN HOSPITAL RESIDENTIAL CARE COOLING **UPGRADE** 

HHA PROJECT NUMBER:
DRAWING TITLE: SCHEMATICS & SCHEDULES

PAGE SIZE: ARCH D
SCALE: N.T.S.
DRAWING NUMBER: DRAWN BY: J.OS CHECKED BY: M.W.

#### **DRAWINGS NOTES:**

- NEW ROOF MOUNTED CONDENSING UNIT. CONDENSING UNIT MOUNTED ON 1M HIGH ROOF CURB, BY STRUCTURAL, REFER TO STRUCTURAL DRAWINGS. UNIT OPERATING WEIGHT 1,601 KG. DASHED LINE INDICATES REQUIRED CLEARANCE.
- 22MM LIQUID & 66MM SUCTION REFRIGERANT LINES TO/FROM DX COOLING COIL TO/FROM CU UNIT. SUPPORT AS PER DETAIL 1/M002.
- 3 SUPPLY/RETURN REFRIGERANT PIPELINES TO PENETRATE INTO THE BOTTOM OF THE AIR HAŃDLING UNIT ENCLOSURE.
- CONNECT EXISTING HYDRONIC PIPING TO NEW HEATING COIL AND CONNECT NEW REFRIGERANT PIPES TO DX COOLING COIL (BASE PRICE) OR CONNECT REFRIGERANT PIPES TO DX COOLING COIL (ALTERNATE PRICE) PER DETAIL 2/M002.
- 5 SLIDE DX COOLING COIL AND HEATING COIL BLOCK (BASE PRICE) OR SLIDE DX COOLING COIL (ALTERNATE PRICE) INTO POSITION THROUGH INTO AHU. SEAL AND

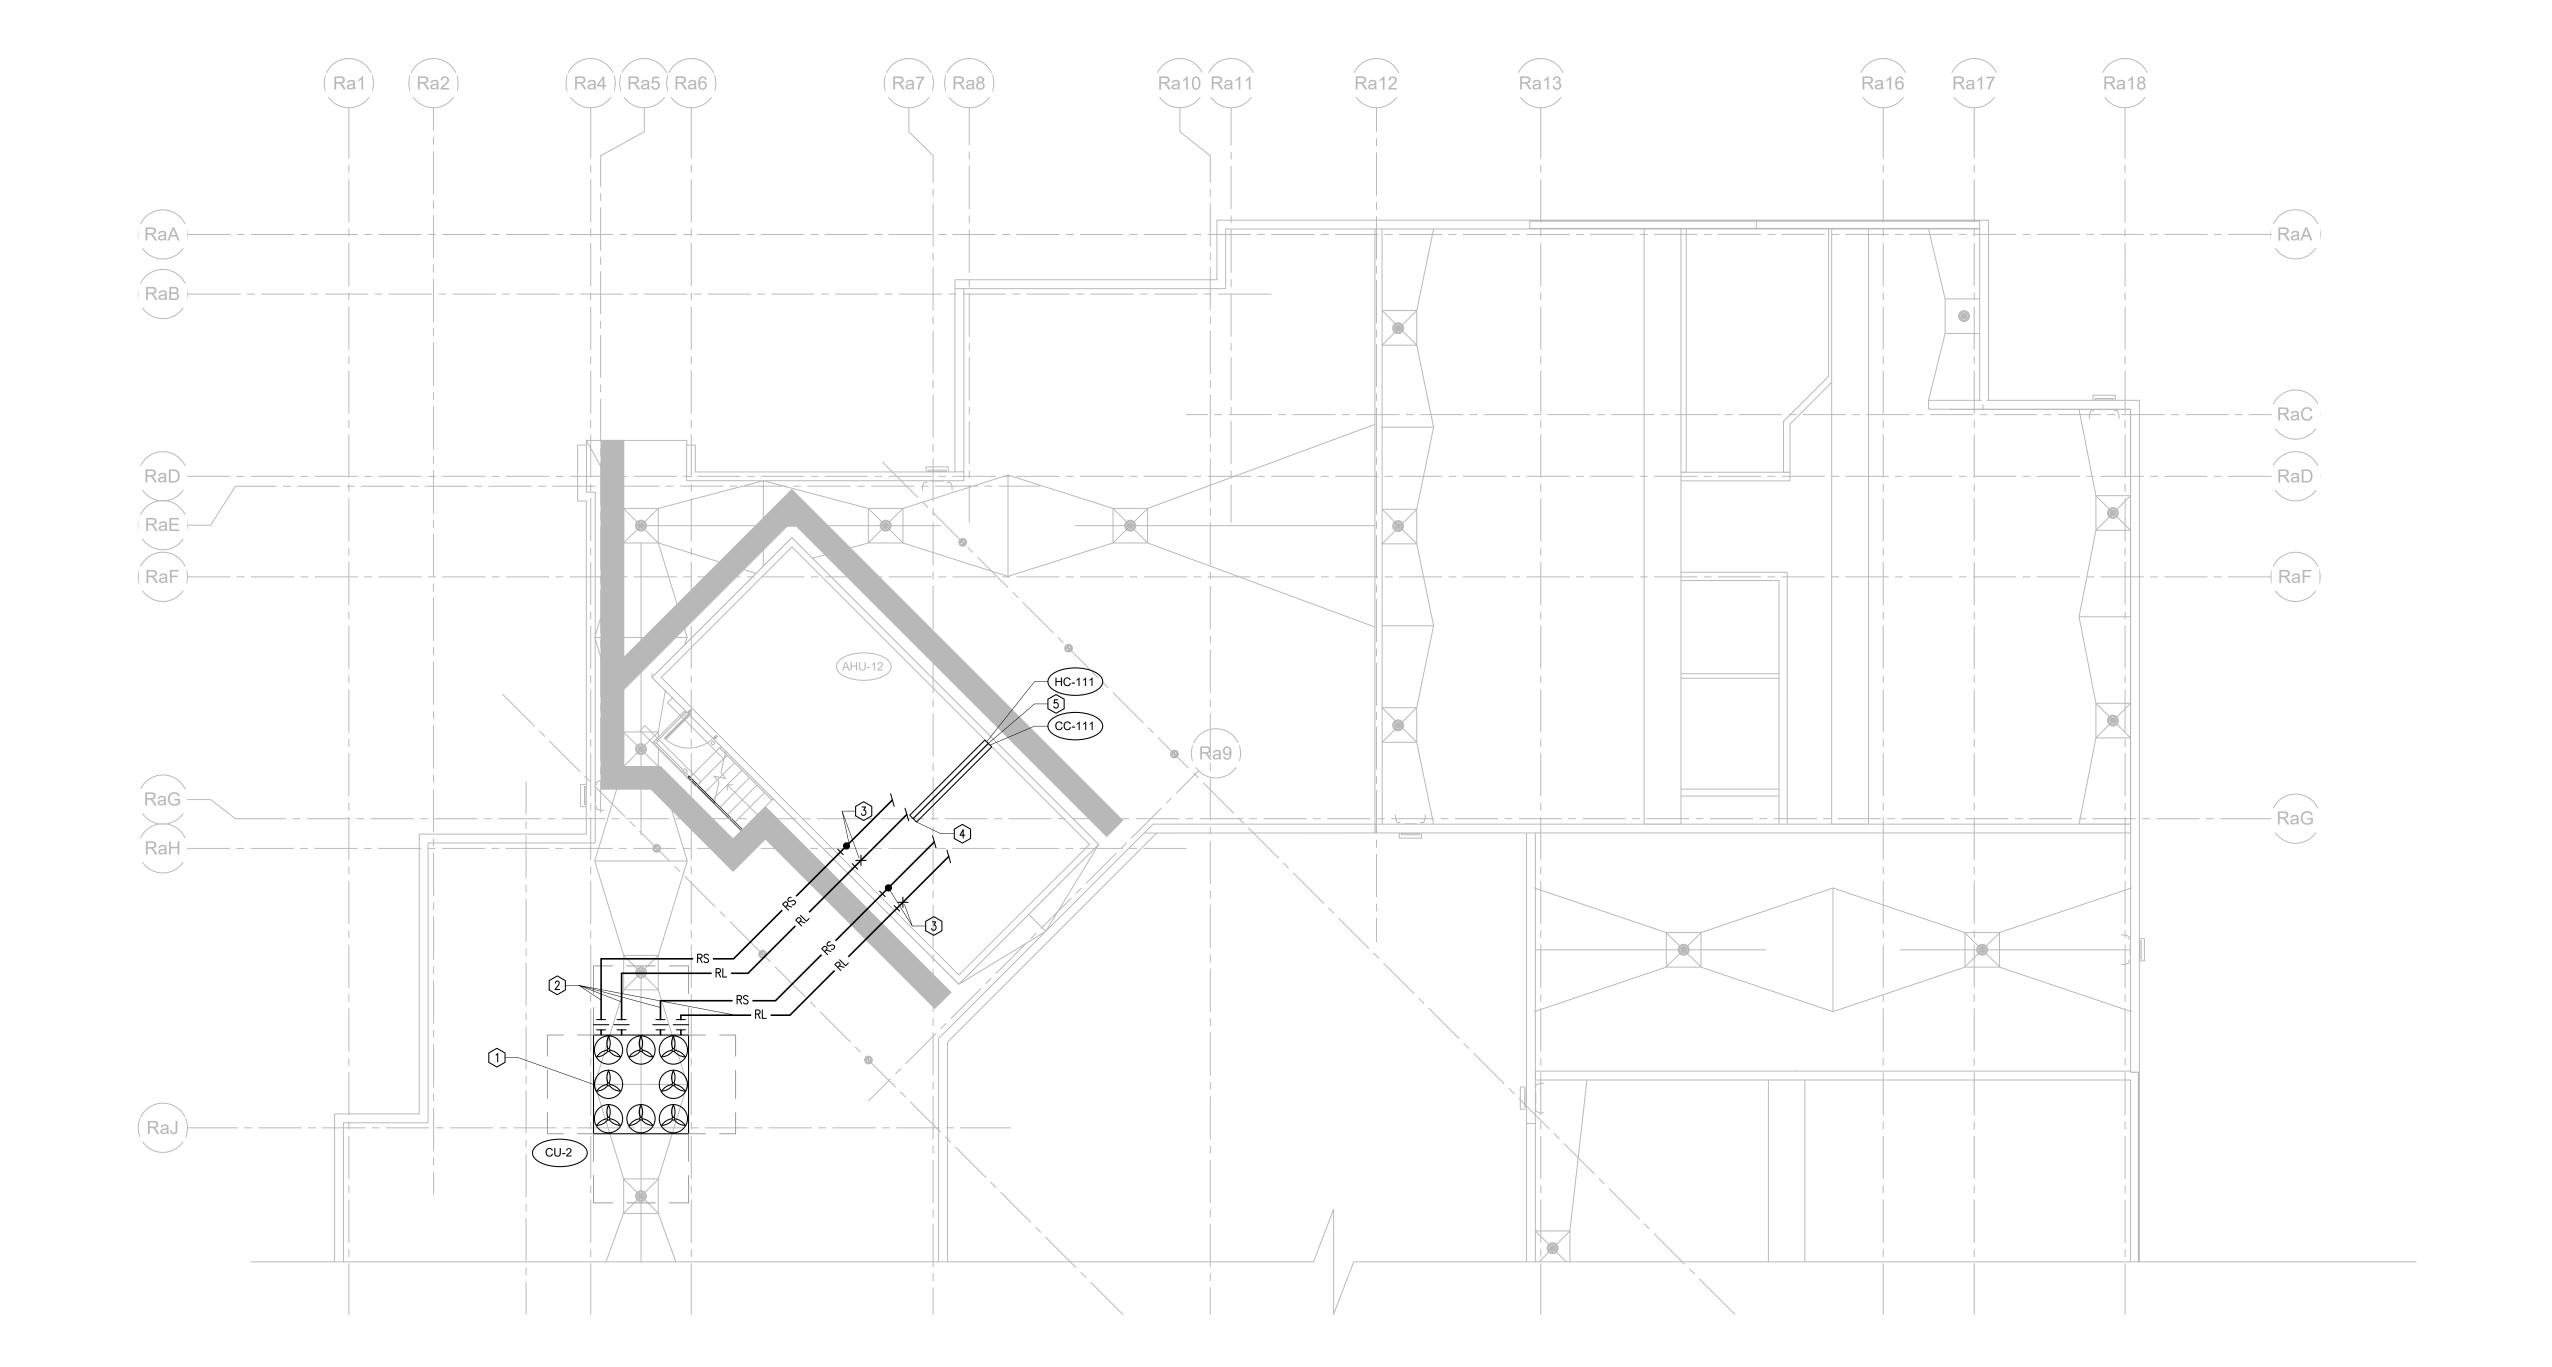



H.H. Angus & Associates Limited Consulting Engineers 1127 Leslie Street, Toronto, ON, M3C 2J6 Canada www.hhangus.com | T 416 443 8200 | F 416 443 8290



**Consulting Structural Engineers** 

1550—1500 West Georgia St. Vancouver, BC V6G 2Z6


604 688 9861 bushbohlman.com


DISCREPANCIES MUST BE REPORTED IMMEDIATELY TO THE CONSULTANT BEFORE ONLY FIGURED DIMENSIONS ARE TO BE USED AND CONTRACTOR MUST CHECK ALL DIMENSIONS ON SITE.
THIS DRAWING IS PROTECTED BY COPYRIGHT.

NO. DATE (YYYY-MM-DD) DESCRIPTION

ISSUED FOR TENDER 03 2023-12-11 02 2023-11-17 ISSUED FOR 90% CD 01 2023-10-27 ISSUED FOR 90% DD NO. DATE (YYYY-MM-DD) DESCRIPTION DRAWING ISSUE

DRAWING REVISIONS

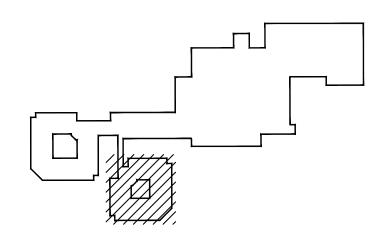

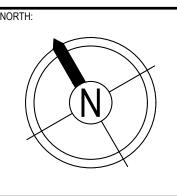

FORT ST. JOHN HOSPITAL RESIDENTIAL CARE COOLING UPGRADE


HHA PROJECT NUMBER:
DRAWING TITLE:

BUILDING A - ROOF LEVEL - NEW MECHANICAL PLAN


DRAWN BY: J.O'S. CHECKED BY: M.W.

#### **DRAWINGS NOTES:**

- NEW ROOF MOUNTED CONDENSING UNIT. CONDENSING UNIT MOUNTED ON 1M HIGH ROOF CURB, BY STRUCTURAL, REFER TO STRUCTURAL DRAWINGS. UNIT OPERATING WEIGHT 1,601 KG. DASHED LINE INDICATES REQUIRED CLEARANCE.
- 22MM LIQUID & 66MM SUCTION REFRIGERANT LINES TO/FROM DX COOLING COIL TO/FROM CU UNIT. SUPPORT AS PER DETAIL 1/M002.
- 3 SUPPLY/RETURN REFRIGERANT PIPELINES TO PENETRATE INTO THE BOTTOM OF THE AIR HANDLING UNIT ENCLOSURE.
- CONNECT EXISTING HYDRONIC PIPING TO NEW HEATING COIL AND CONNECT NEW REFRIGERANT PIPES TO DX COOLING COIL (BASE PRICE) OR CONNECT REFRIGERANT PIPES TO DX COOLING COIL (ALTERNATE PRICE) PER DETAIL 2/M002.
- SLIDE DX COOLING COIL AND HEATING COIL BLOCK (BASE PRICE) OR SLIDE DX COOLING COIL (ALTERNATE PRICE) INTO POSITION THROUGH INTO AHU. SEAL AND

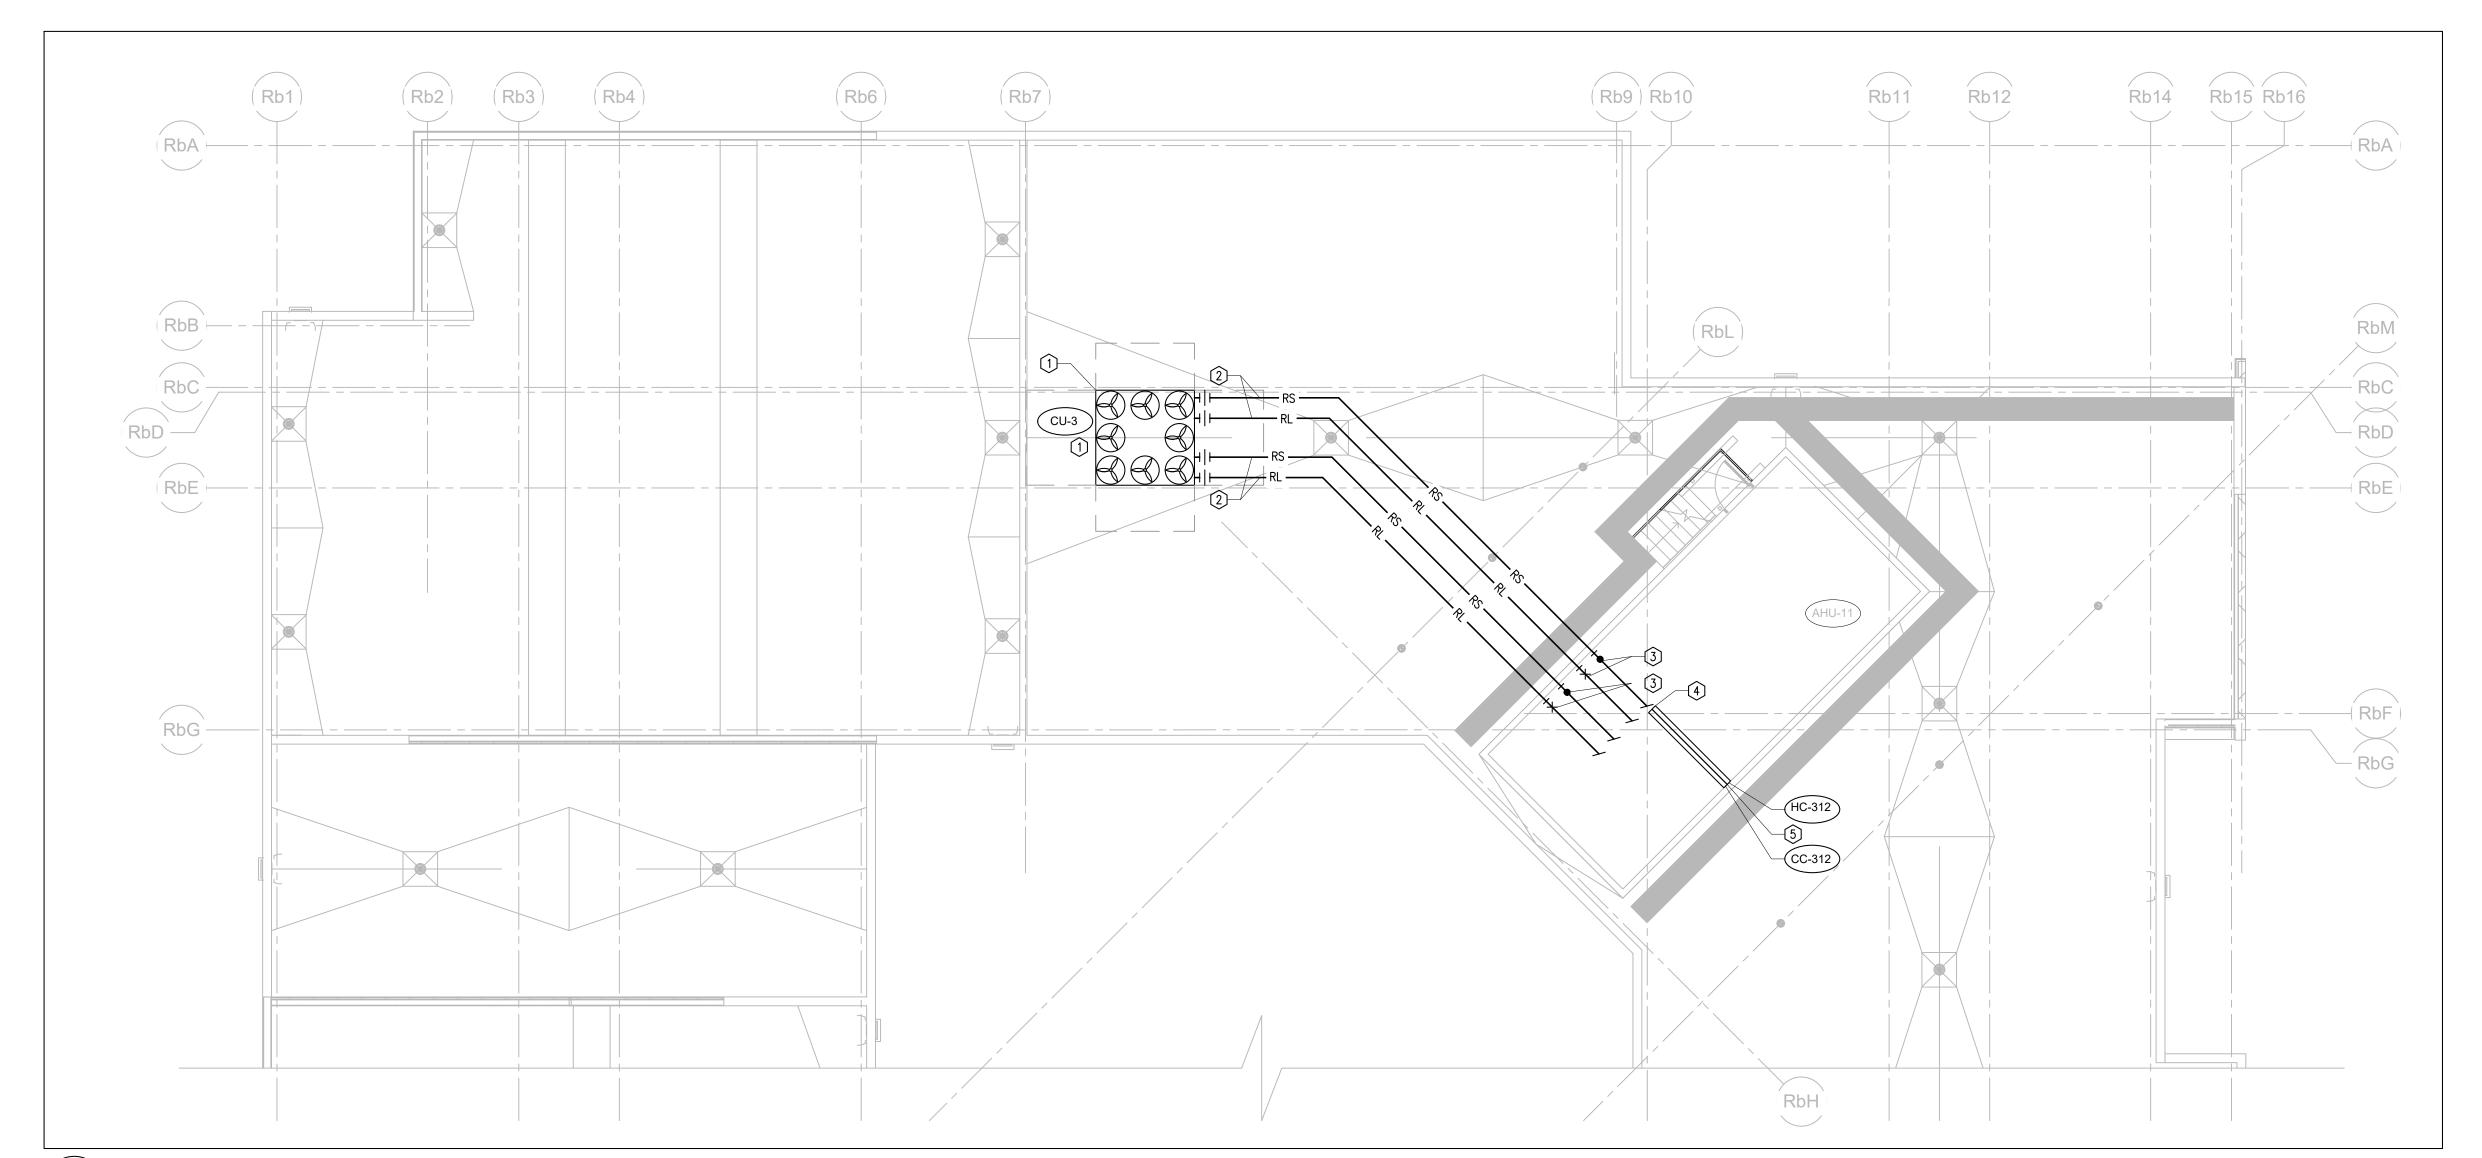

1 BUILDING B - ROOF LEVEL - NEW MECHANCIAL PLAN

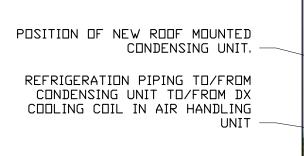



2 CONDENSING UNIT ON BUILDING B ROOF M101 N.T.S.

HHAngus H.H. Angus & Associates Limited Consulting Engineers 1127 Leslie Street, Toronto, ON, M3C 2J6 Canada

www.hhangus.com | T 416 443 8200 | F 416 443 8290

# BushBohlman & Partners

Consulting Structural Engineers 1550—1500 West Georgia St.


Vancouver, BC V6G 2Z6


604 688 9861 bushbohlman.com

DISCREPANCIES MUST BE REPORTED IMMEDIATELY TO THE CONSULTANT BEFORE ONLY FIGURED DIMENSIONS ARE TO BE USED AND CONTRACTOR MUST CHECK ALL DIMENSIONS ON SITE.
THIS DRAWING IS PROTECTED BY COPYRIGHT.

NO. DATE (YYYY-MM-DD) DESCRIPTION DRAWING REVISIONS

03	2023-12-11	ISSUED FOR TENDER
02	2023-11-17	ISSUED FOR 90% CD
01	2023-10-27	ISSUED FOR 90% DD
NO.	DATE (YYYY-MM-DD)	DESCRIPTION
		DRAWING ISSUE

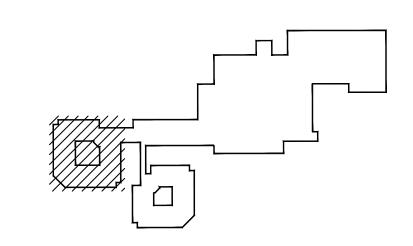

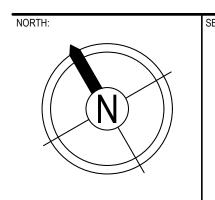

FORT ST. JOHN HOSPITAL RESIDENTIAL CARE COOLING UPGRADE

HHA PROJECT NUMBER:

BUILDING B - ROOF LEVEL - NEW MECHANICAL PLAN

PAGE SIZE: ARCH D DRAWN BY: J.O'S. CHECKED BY: M.W.