# UHNBC(University Hospital of Northern BC)- NAPRA Pharmacy Renovation

Project Number: 144320228

<u>ADDRESS</u>: 1475 Edmonton St, Prince George, BC V2M 1S2

**LEGAL DESCRIPTION:** Lot: A District Lot: 343 Plan: EPP61060 except Plan EPP61362 PID: 030-387-884 AREA-JURISDICTION-ROLL: 26-226-00-02119.500



#### **CONSULTANTS**

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	DRAWING LIST
NO.	DRAWING NAME
ARCHITECTURAL	
GI001	TITLE SHEET & LIST OF DRAWINGS
GI002	SITE PLAN, GENERAL NOTES, CONSTRUCTION ASSEMBLIES & ABBREVIATIONS
AD101	LEVEL 0 - EXISTING AND DEMOLITION FLOOR PLAN
AD151	LEVEL 0 - EXISTING AND DEMOLITION CEILING PLAN
AE001	LEVEL 0 - FLOOR PHASING & HOARDING PLAN AND LIFE SAFETY PLAN
AE101	LEVEL 0 - RENOVATION PLAN
AE102	LEVEL 1 - RENOVATION PLAN
AE103	LEVEL 2 - RENOVATION PLAN
AE104	LEVEL 3 - RENOVATION PLAN
AE105	UPPER ROOF - RENOVATION PLAN
AE111	LEVEL 0 - ENLARGED EQUIPMENT & FURNITURE PLAN AND SCHEDULES
AE112	LEVEL 0 - FINISHES PLANS & ROOM FINISH SCHEDULE
AE151	LEVEL 0 - REFLECTED CEILING PLAN
AE201	INTERIOR ELEVATIONS
AE202	INTERIOR ELEVATIONS
AE302	MILLWORK DETAILS
AE901	3D REPRESENTATIONS & ISOMETRICS

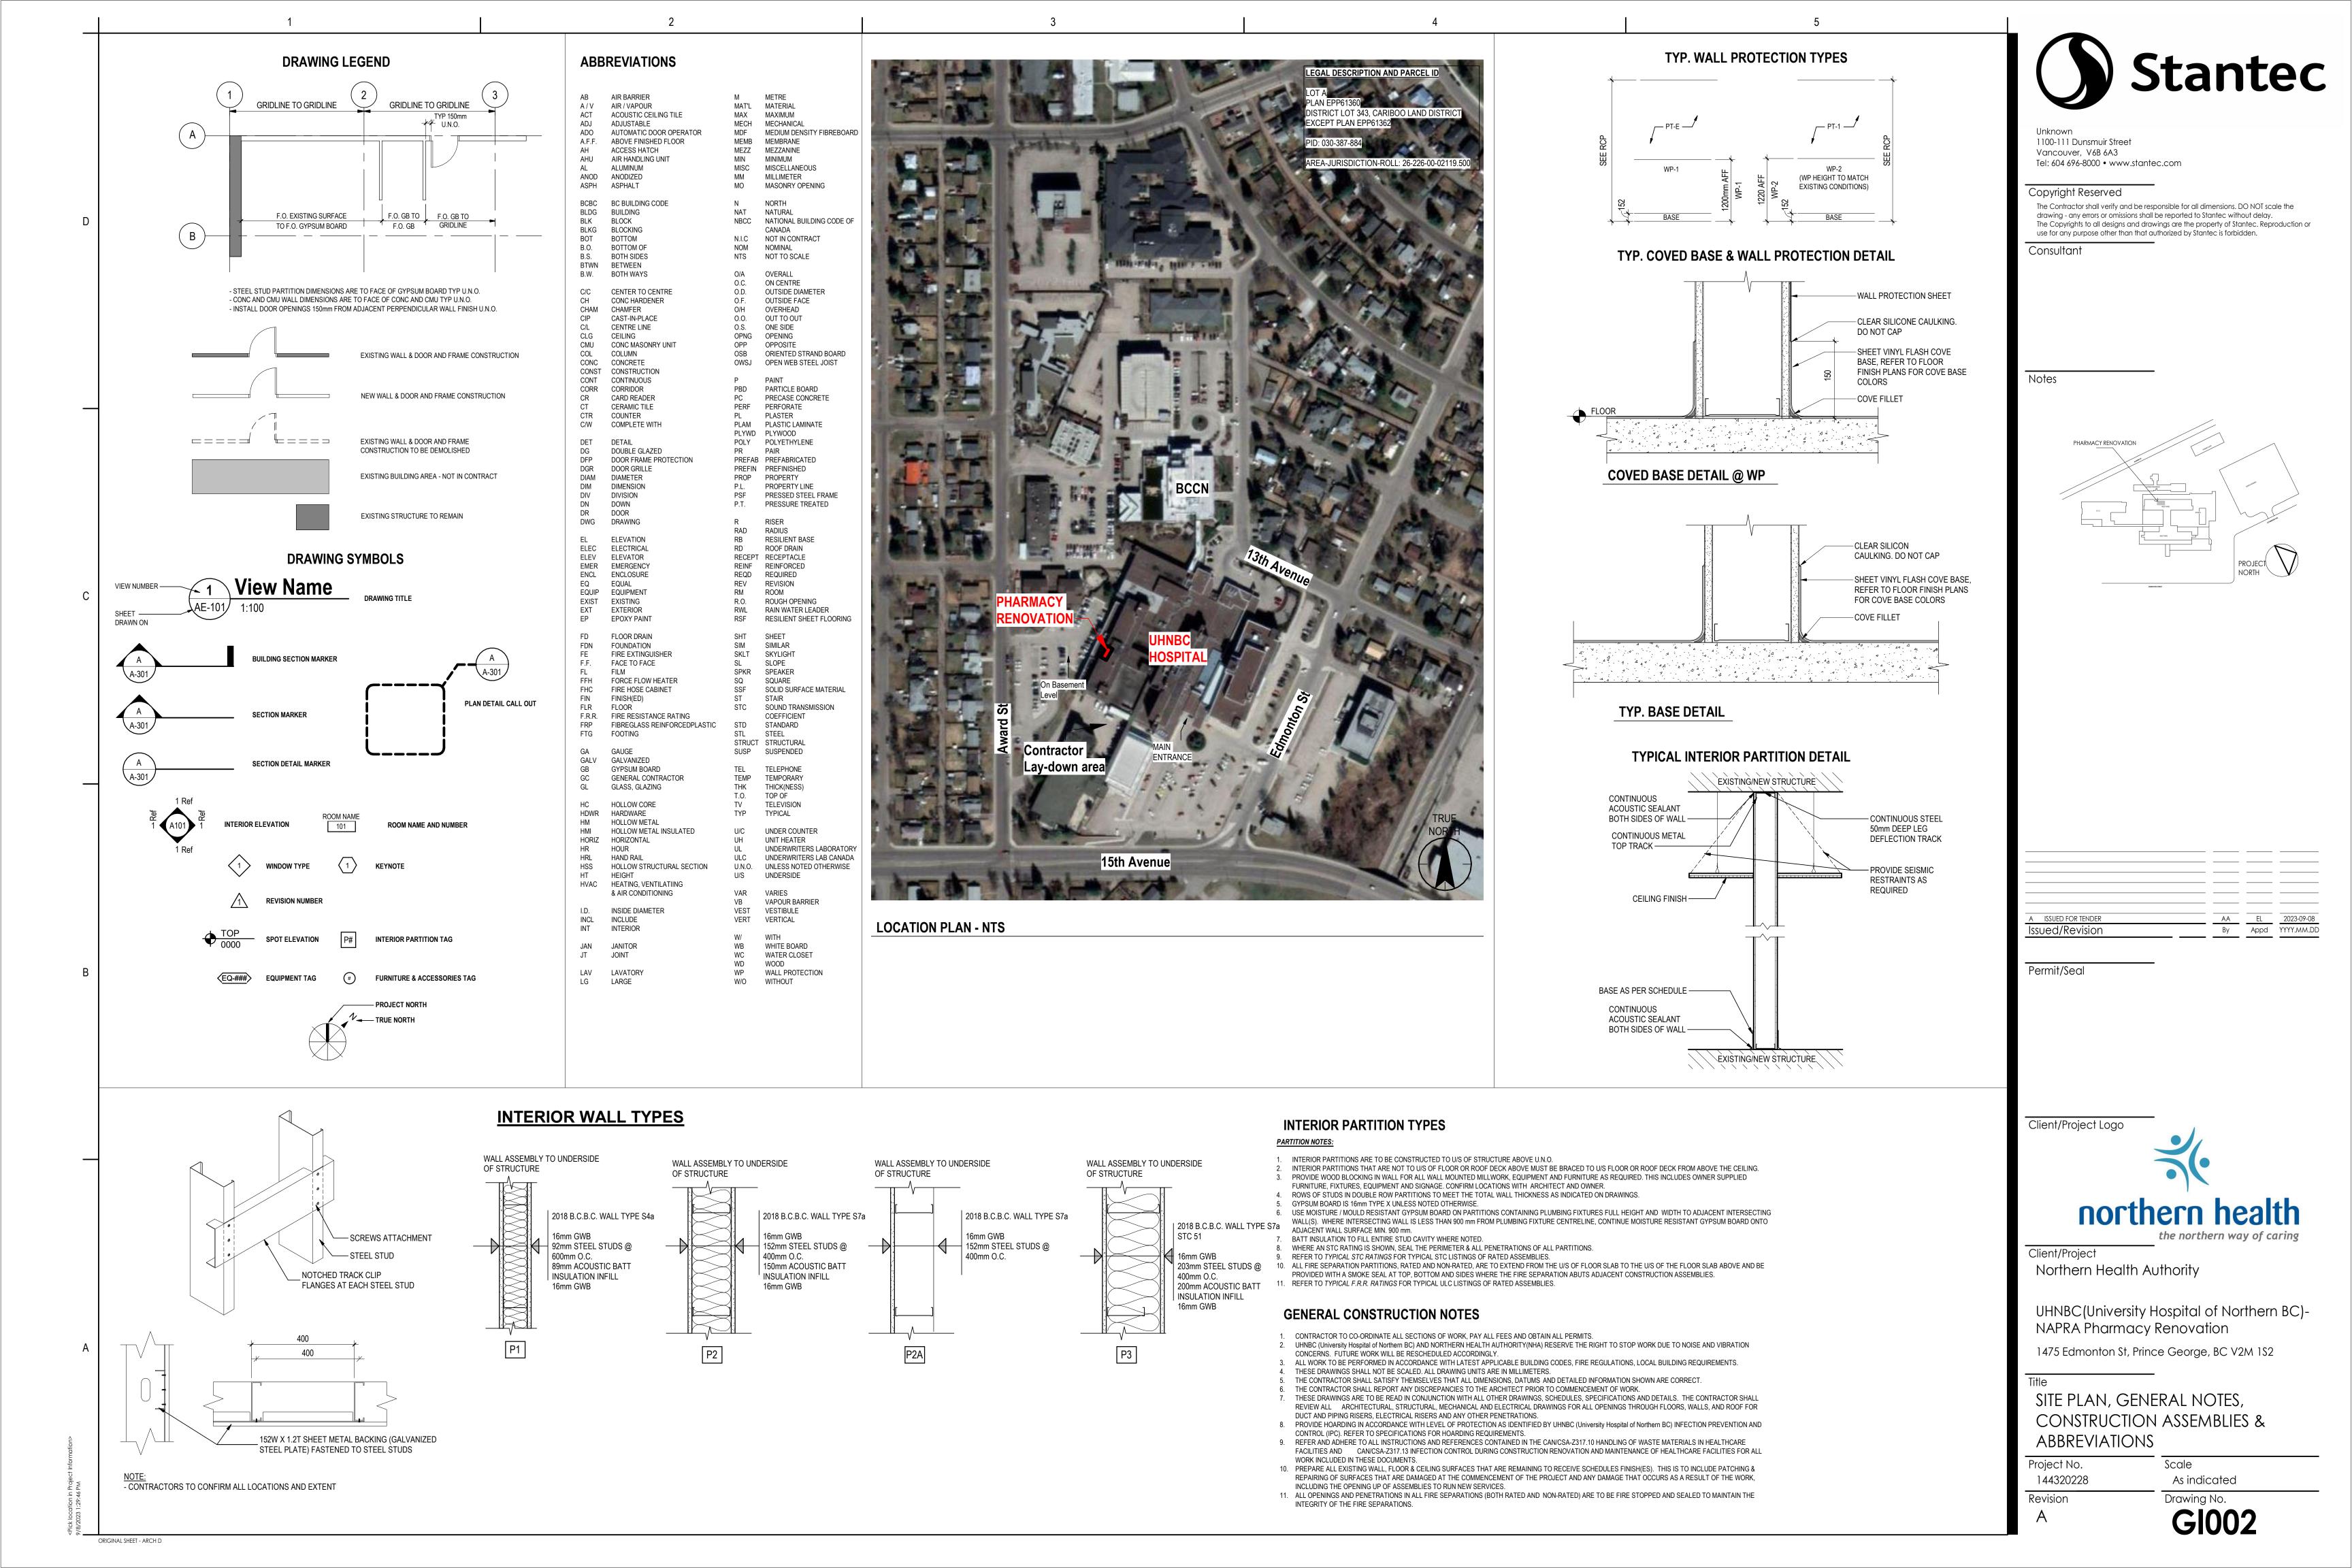
	DRAWING LIST
NO.	DRAWING NAME
MECHANICAL	
M001	SYMBOLS AND ABBREVIATIONS
M002	SYMBOLS, ABBREVIATIONS KEY PLAN, AND GENERAL NOTES
M100	LEVEL 0 - HVAC ENVIRONMENTAL CONTROLS
M101	LEVEL 0 - HVAC - DEMO
M102	LEVEL 0 - HVAC - OVERVIEW
M103	LEVEL 0 - HVAC - NEW
M104	LEVEL 0 - HYDRONIC - NEW
M105	LEVEL 1 - HVAC - NEW
M106	LEVEL 2, LEVEL 3, & UPPER ROOF - HVAC - NEW
M200	LEVEL 0 - PLUMBING OVERVIEW
M201	LEVEL 0 - SANITARY PLUMBING - DEMO & NEW
M202	LEVEL 0 - PLUMBING - DEMO & NEW
M300	LEVEL 0 - FIRE PROTECTION PLAN
M400	MECHANICAL DETAILS
M401	MECHANICAL DETAILS
M402	MECHANICAL SCHEMATICS
M403	MECHANICAL SCHEMATICS
M500	MECHANICAL SCHEDULES
M501	MECHANICAL SCHEDULES

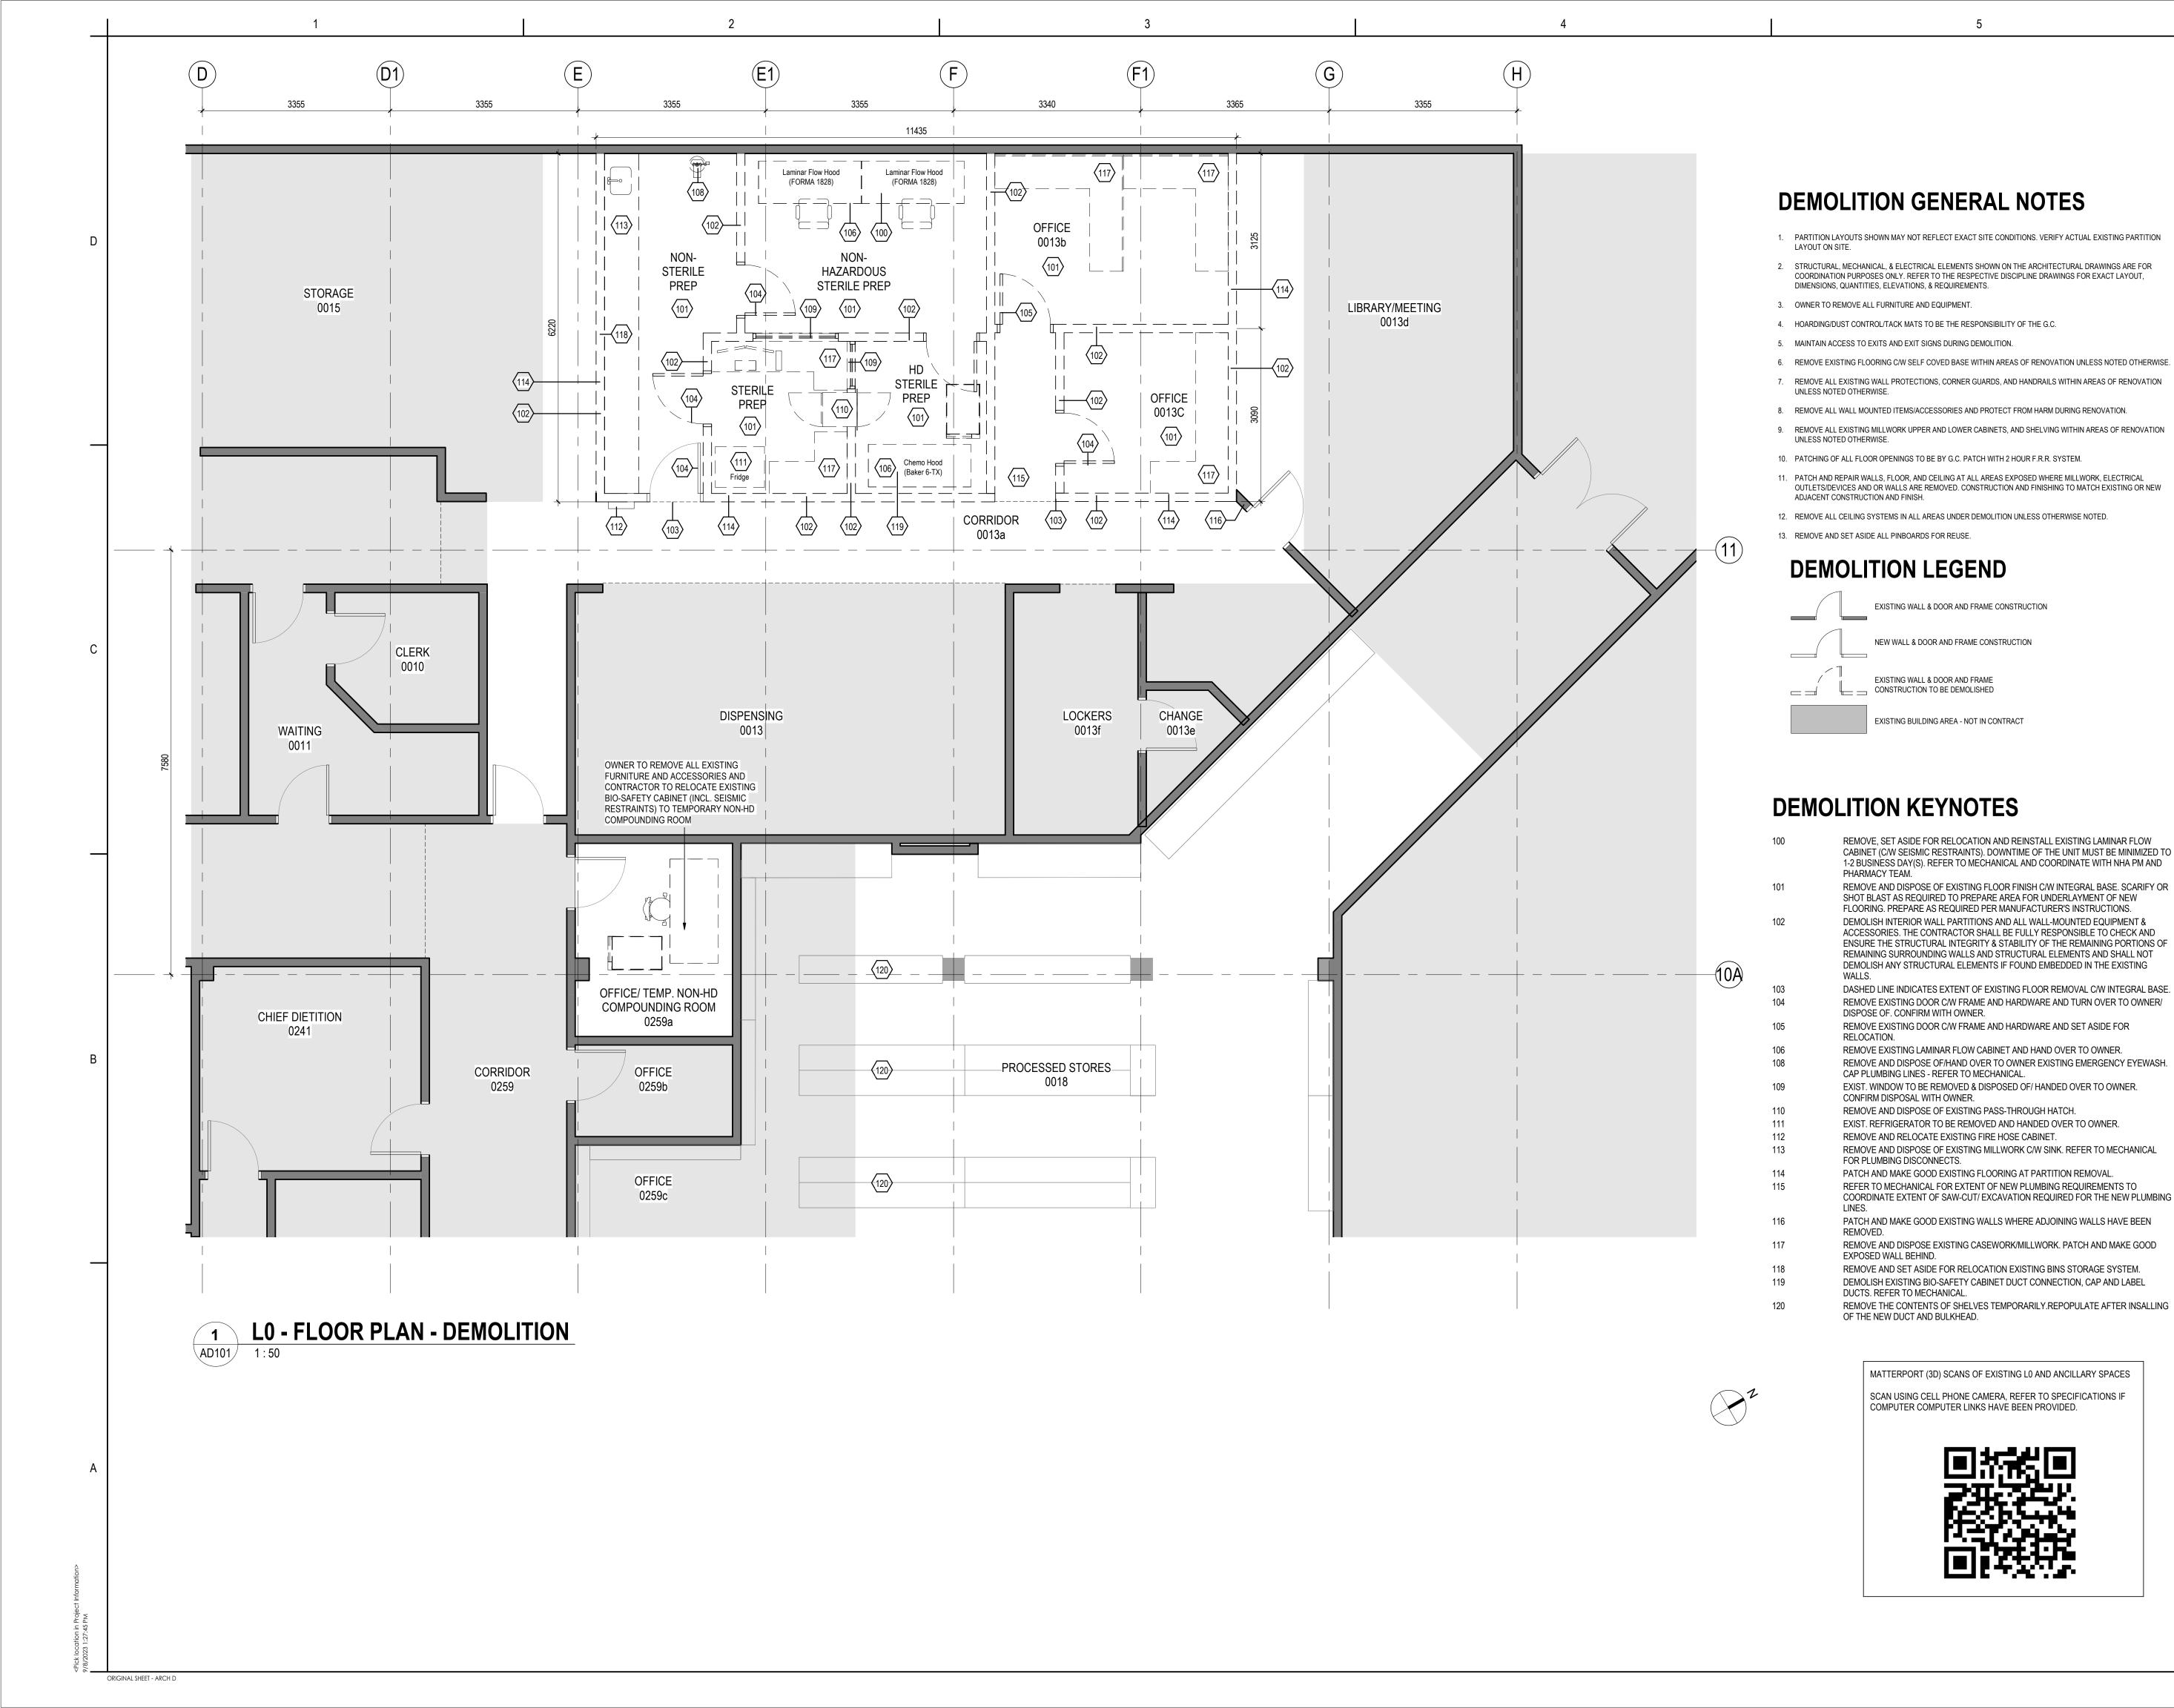
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NO.	DRAWING NAME
ELECTRICAL	
E001	COVER PAGE
E010	SYSTEM OVERVIEW
E100	POWER AND SYSTEMS FLOOR PLAN - PHARMACY
E101	POWER & SYSTEMS FLOOR PLAN - ROOF PLANS
E200	LIGHTING PLAN - PHARMACY
E300	PANEL SCHEDULES
E301	LUMINAIRE AND MECHANICAL SCHEDULES
E400	ELECTRICAL DETAILS
STRUCTURAL	
S001	GENERAL NOTES
S101	LEVEL 1 PLAN
S102	ROOF PLANS

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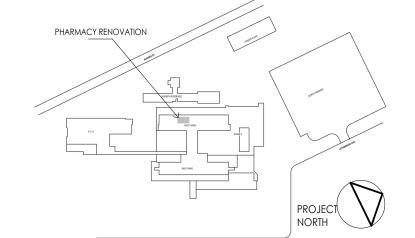
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LEVEL 0 - EXISTING AND DEMOLITION FLOOR PLAN

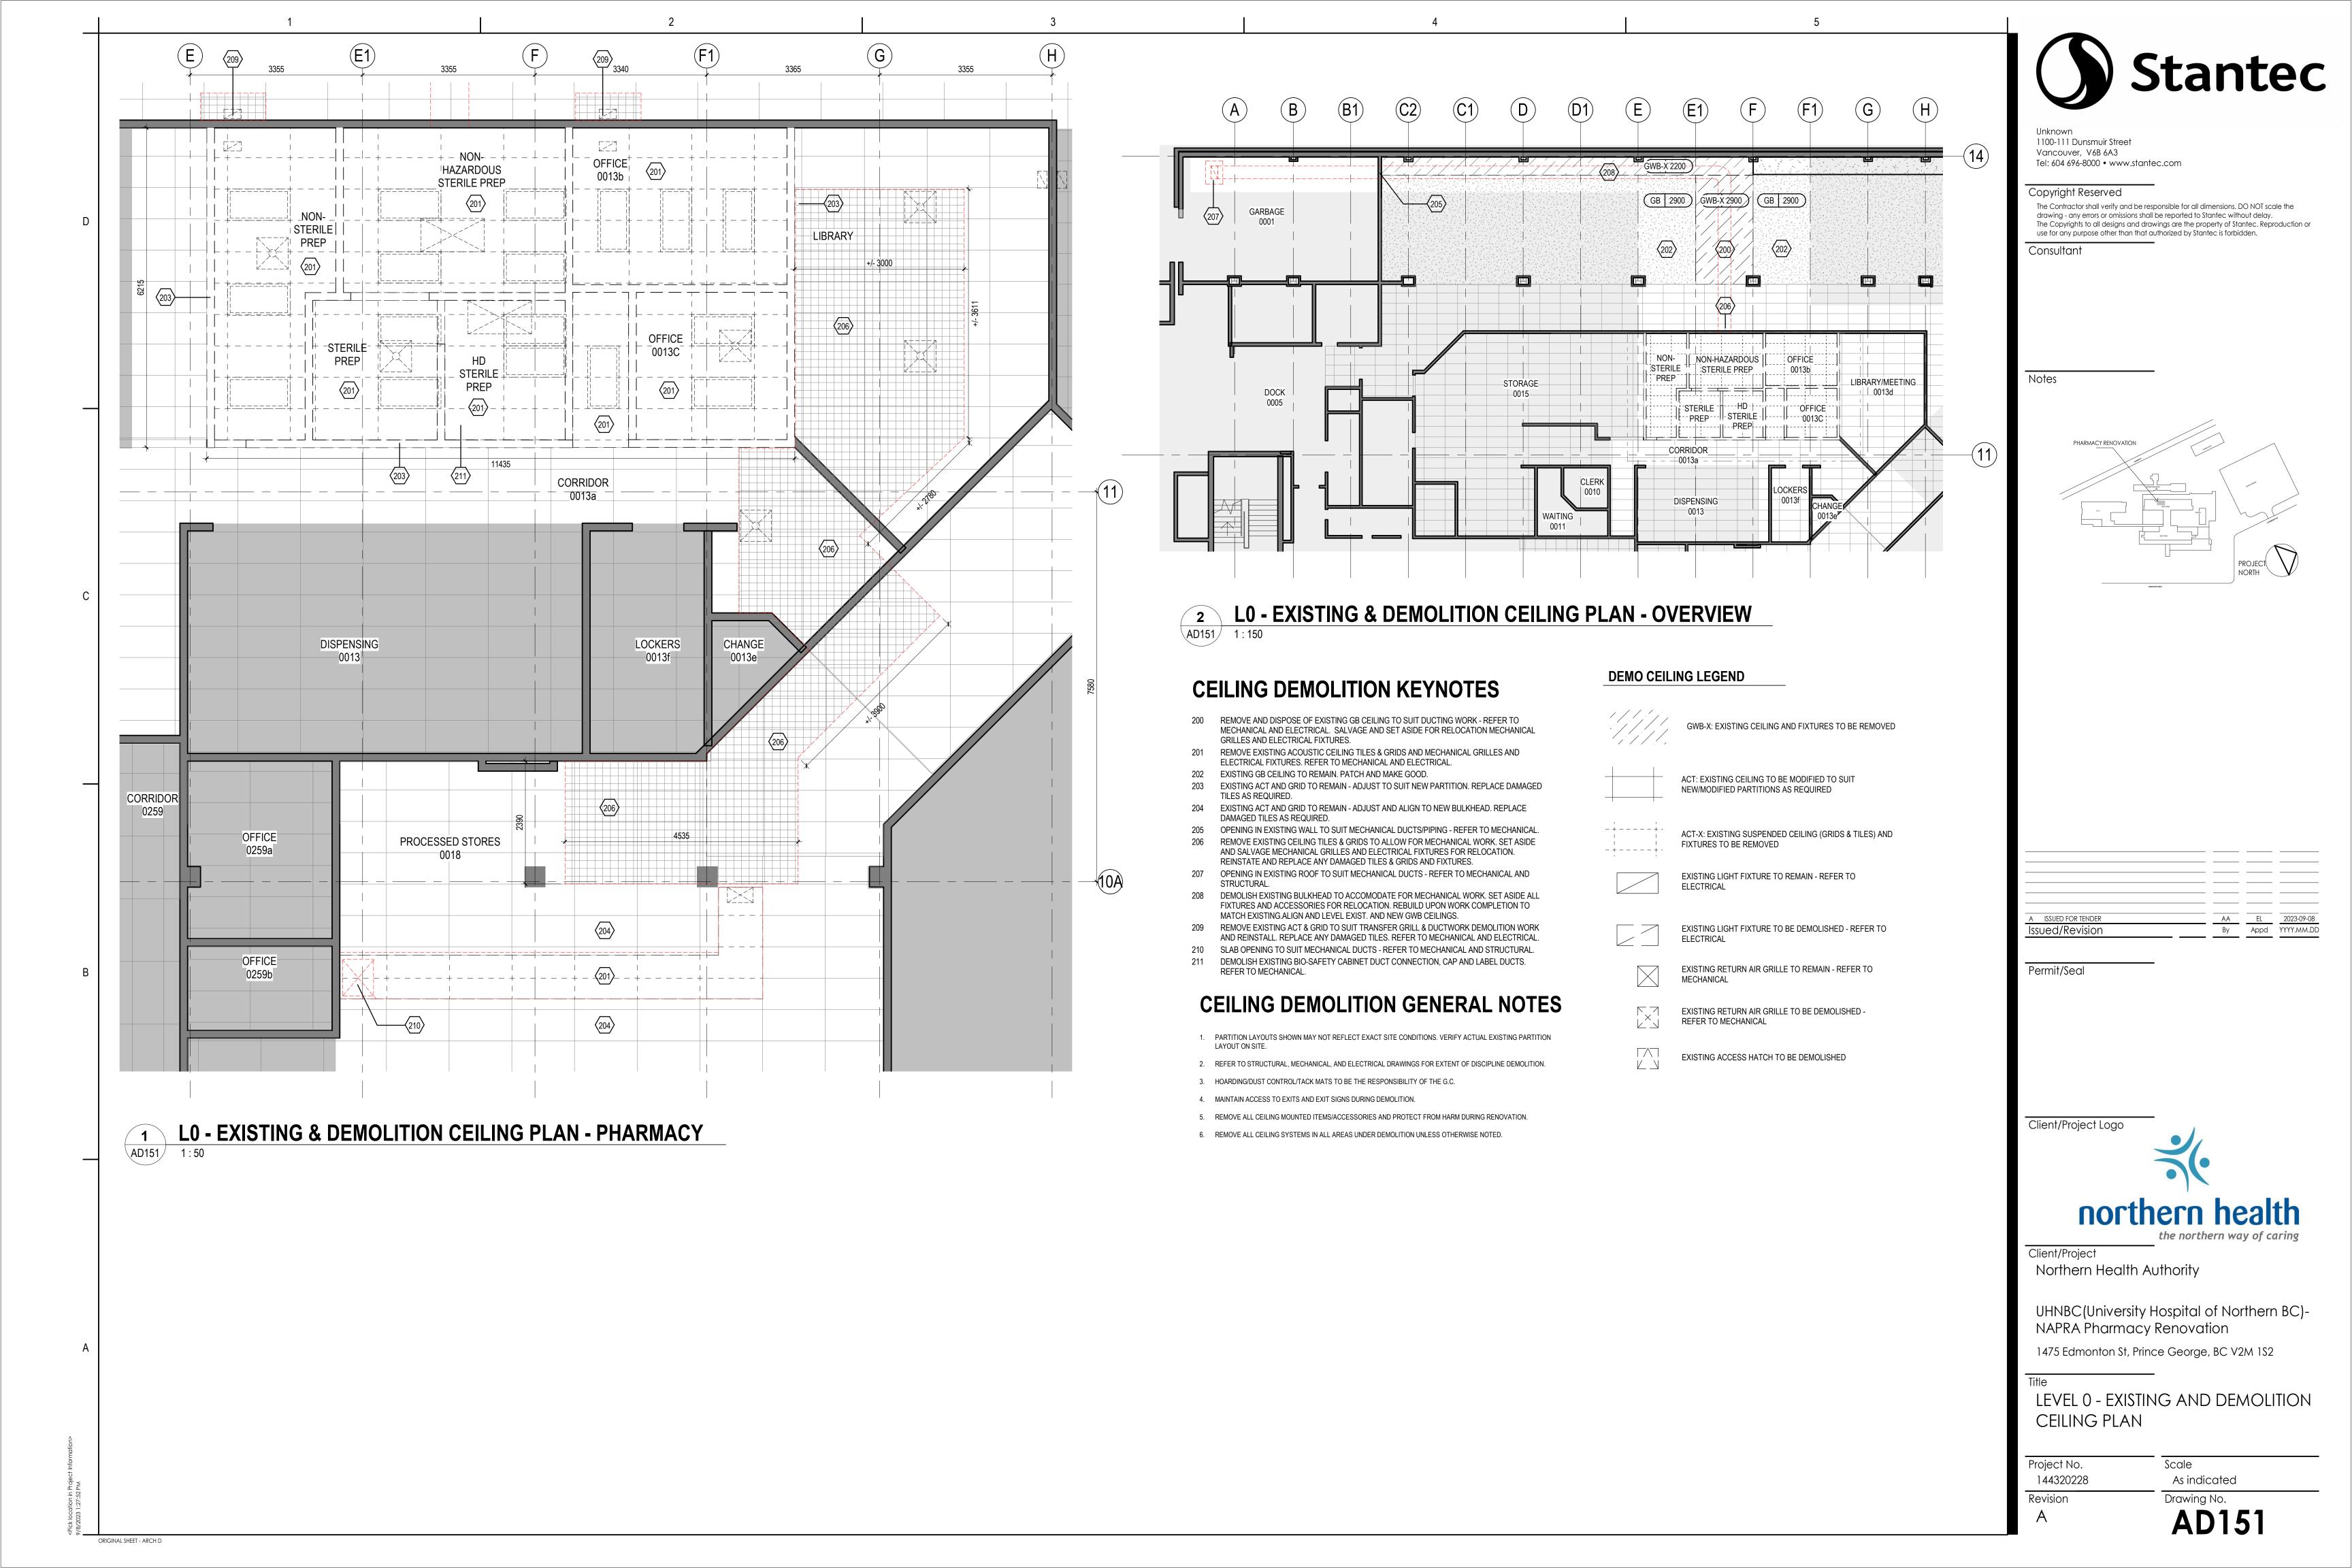
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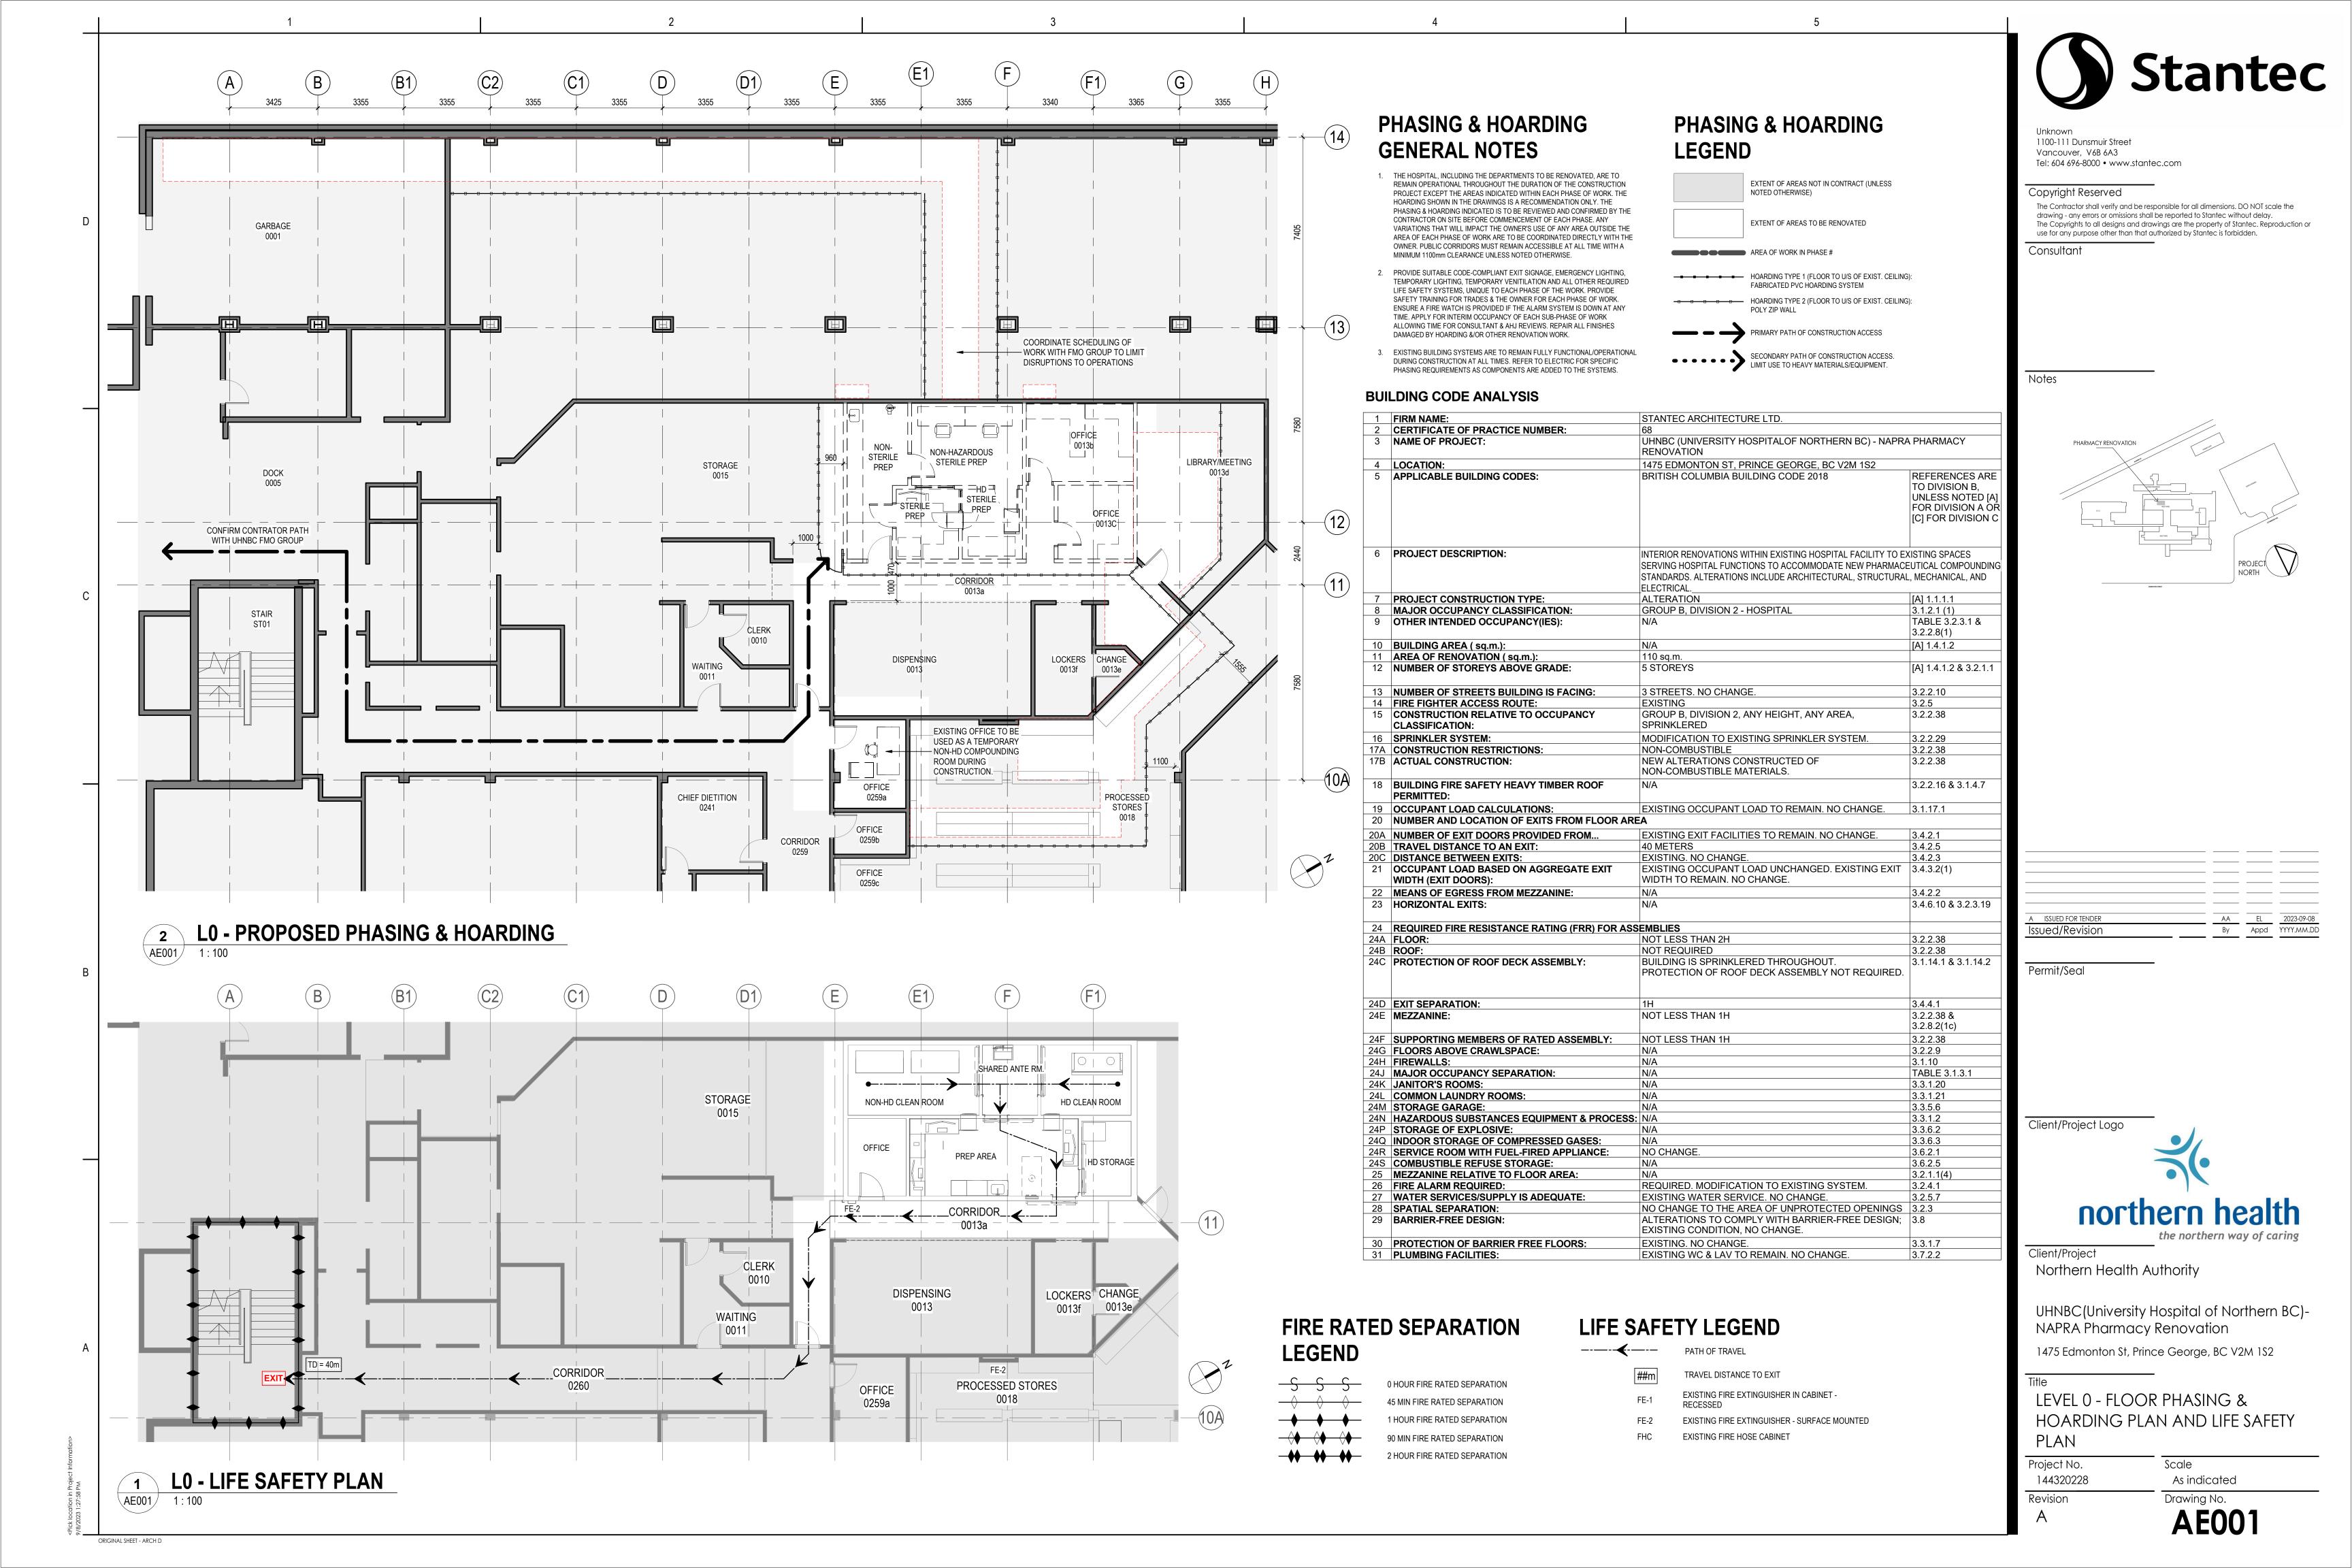
Project No. 144320228 Revision

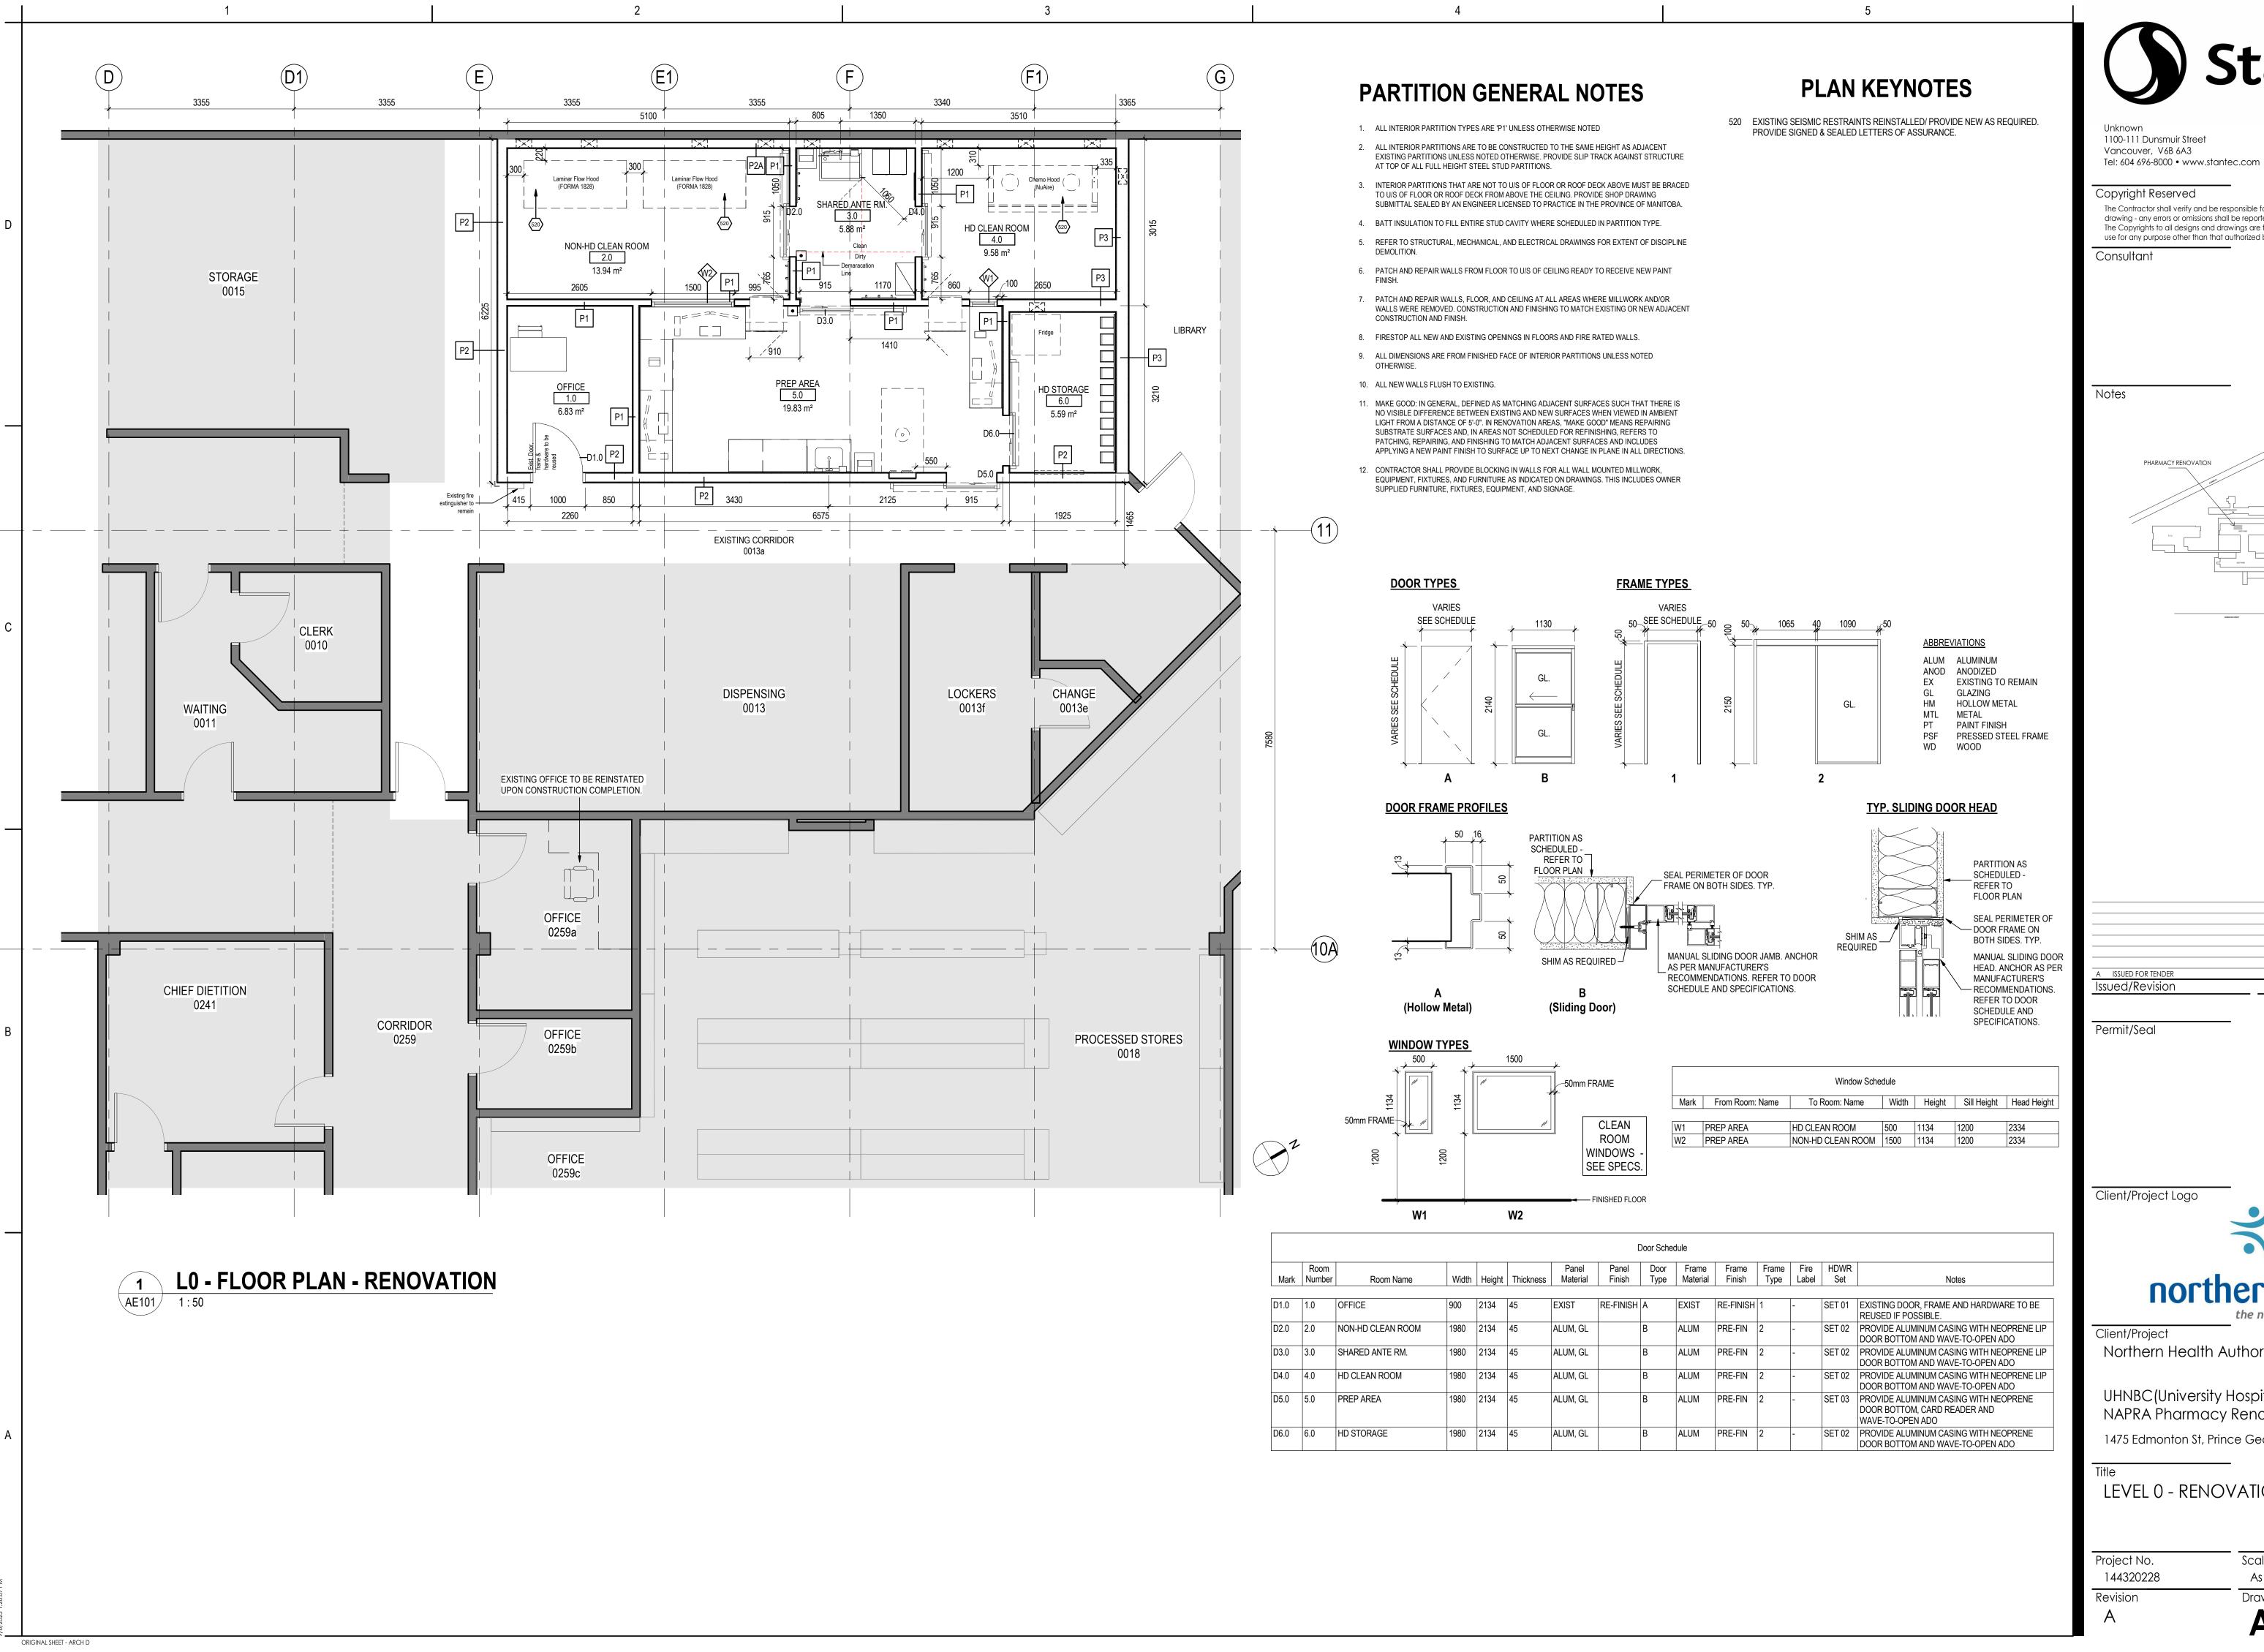
As indicated

Drawing No.

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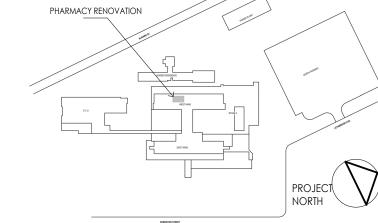








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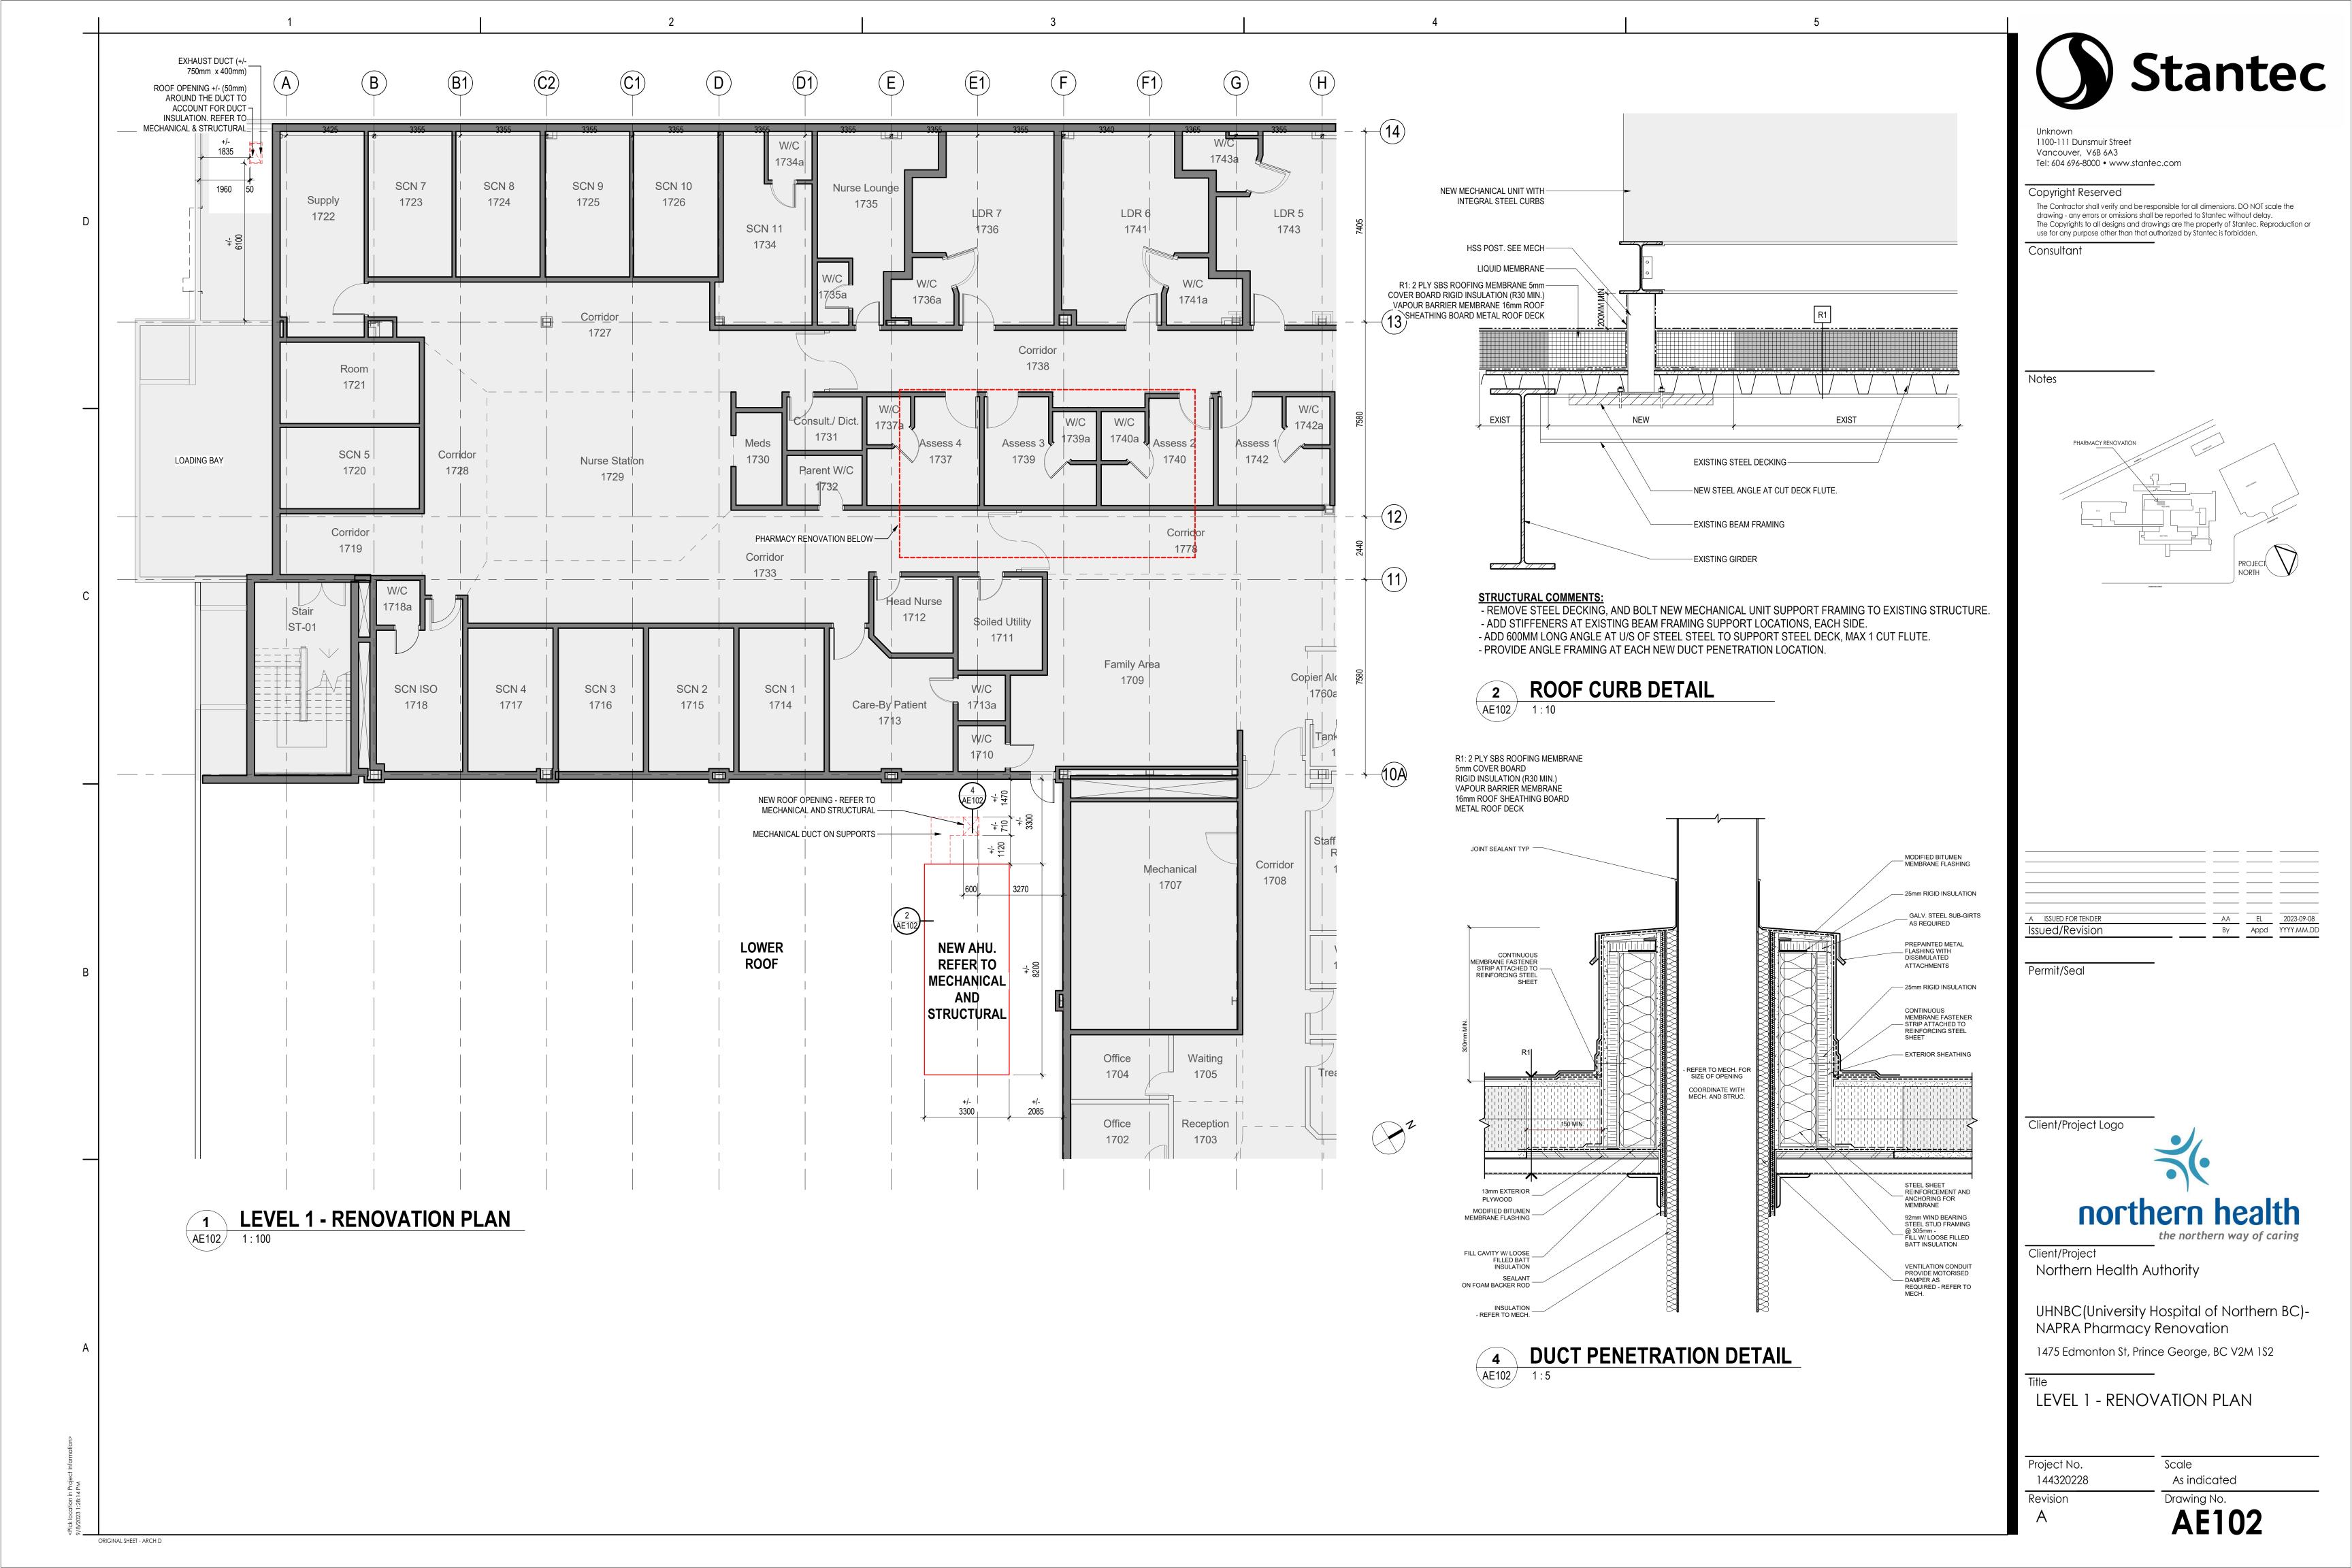
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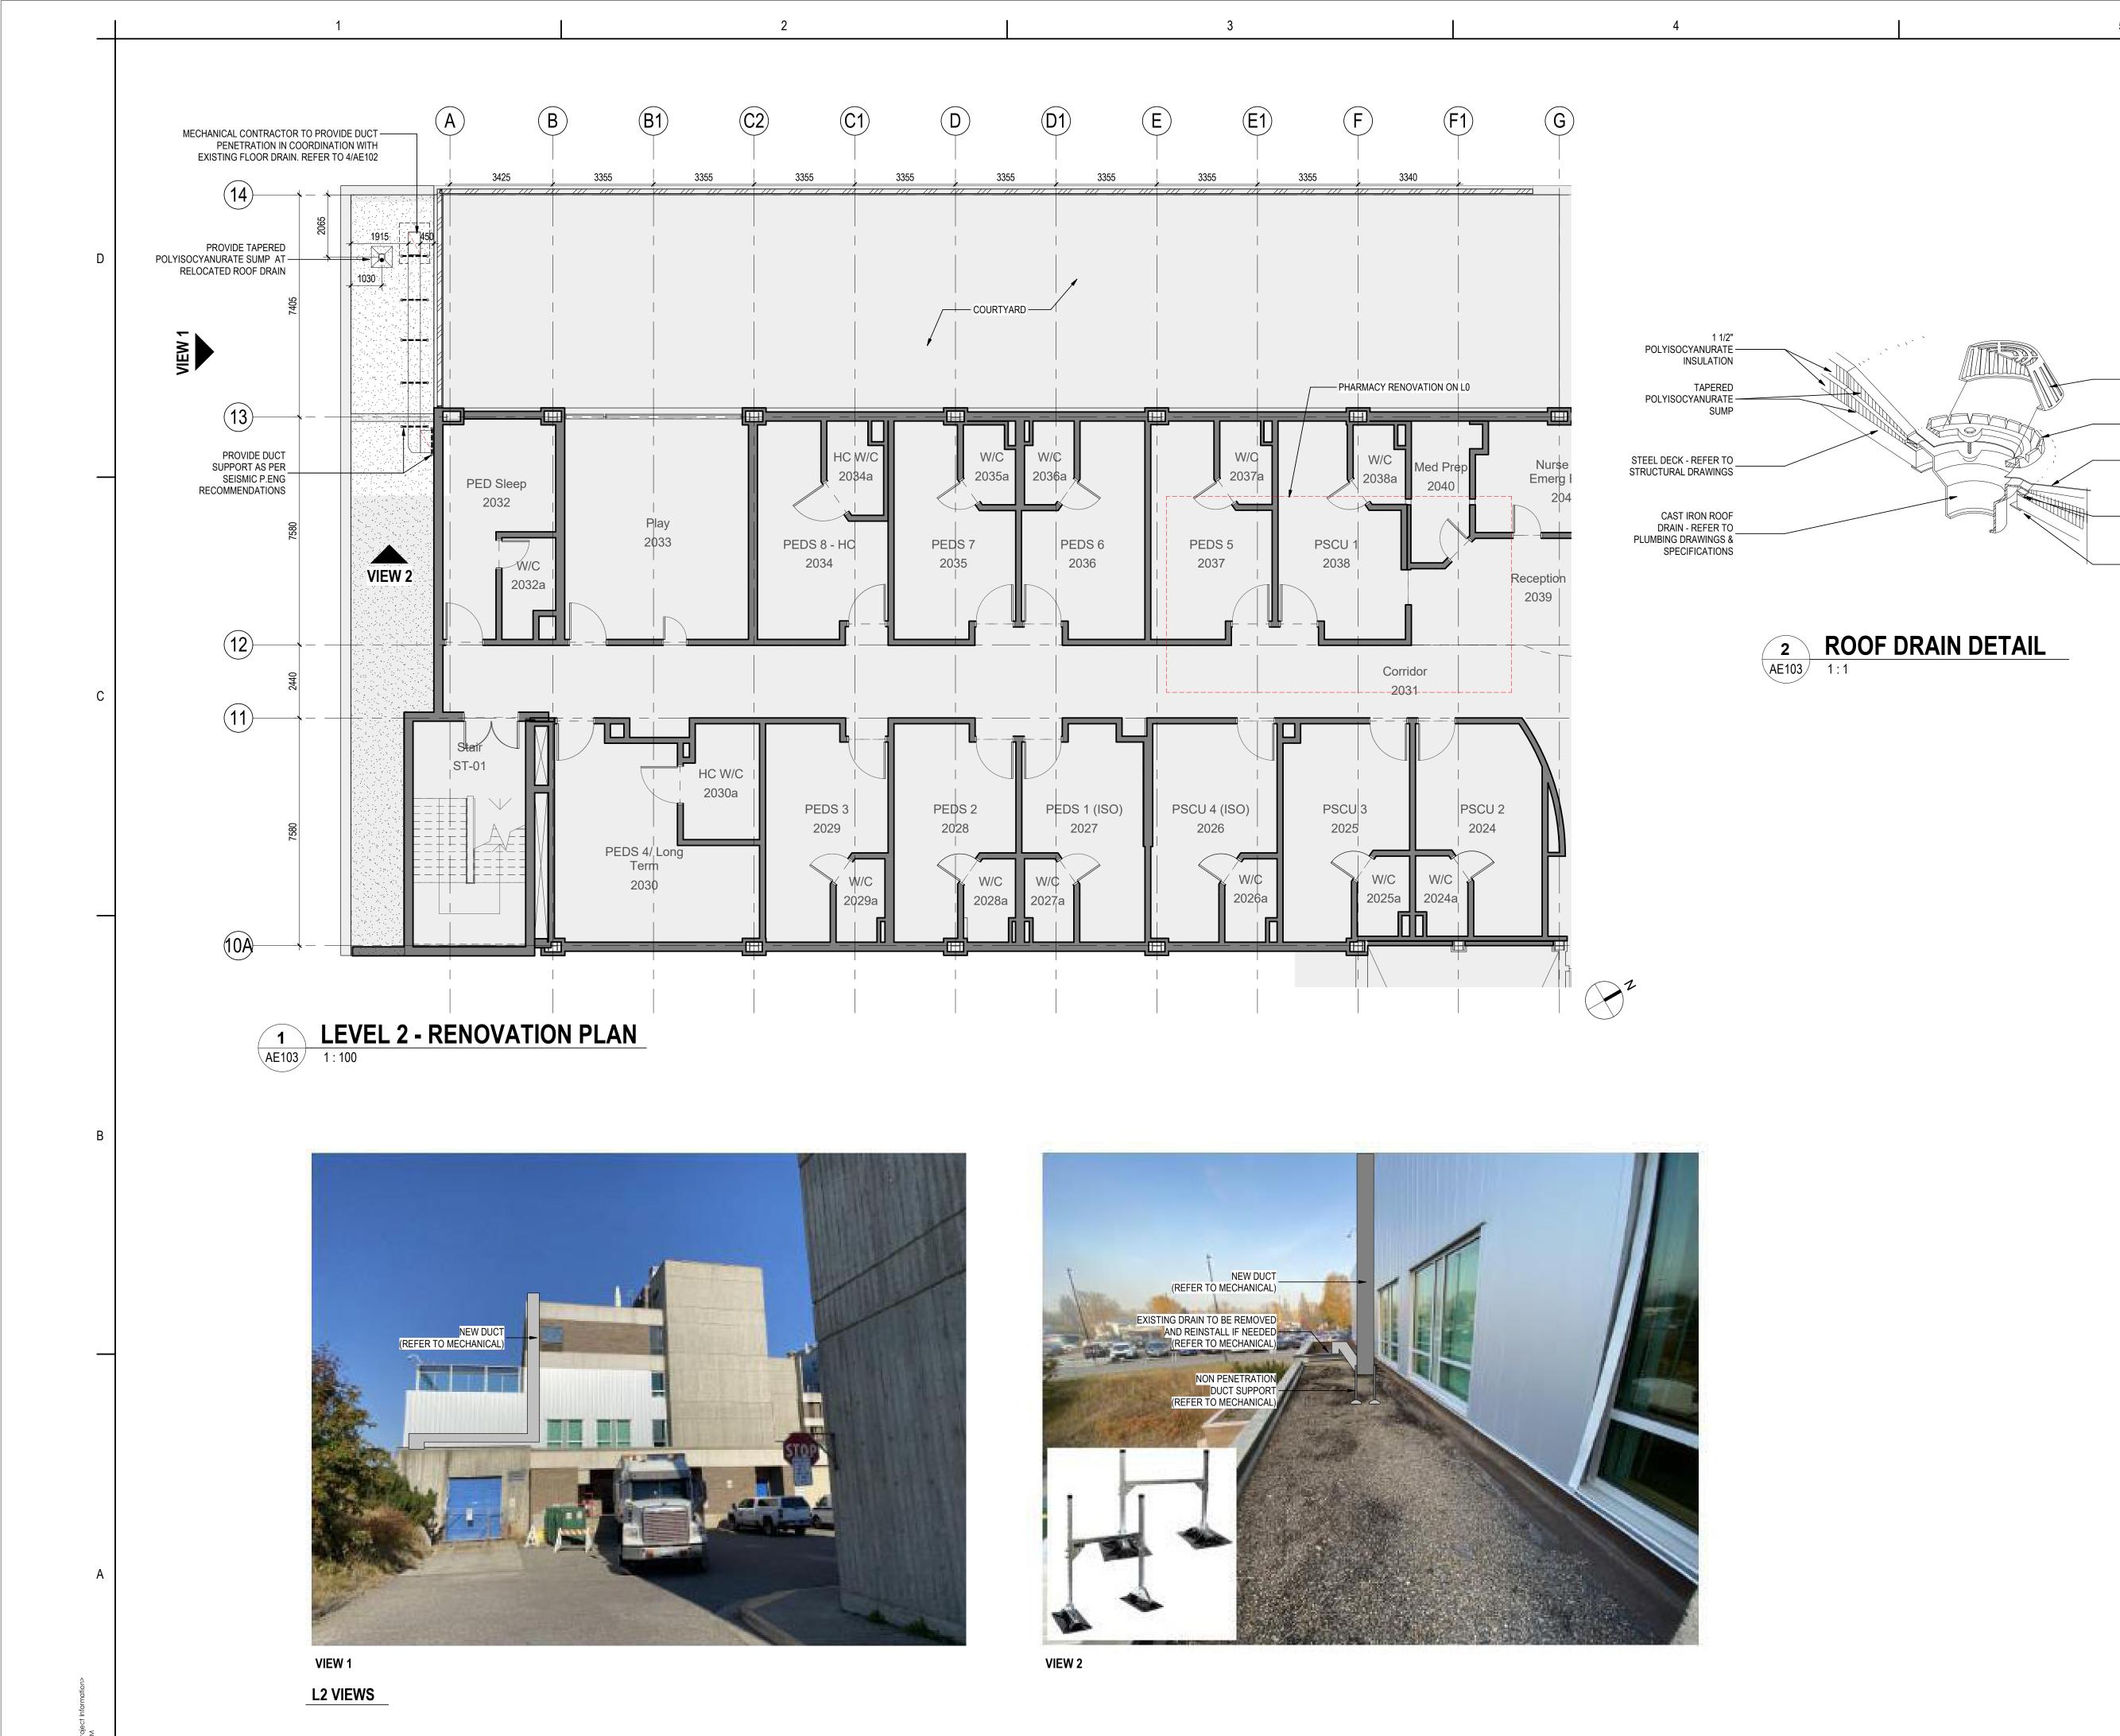
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LEVEL 0 - RENOVATION PLAN

Scale As indicated Drawing No. **AE101** 





ORIGINAL SHEET - ARCH D



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CAST IRON STRAINER - REFER

— TO PLUMBING DRAWINGS &

CAST IRON CLAMPING RING -— REFER TO PLUMBING DRAWINGS & SPECIFICATIONS

UNDERDECK CLAMPING RING -

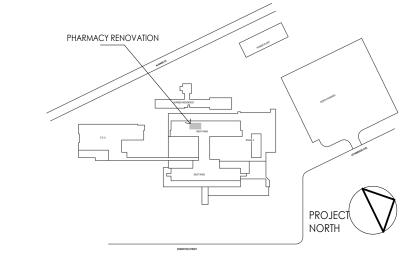
DRAWINGS & SPECIFICATIONS

- REFER TO PLUMBING

SPECIFICATIONS

— ROOFING MEMBRANE

Notes



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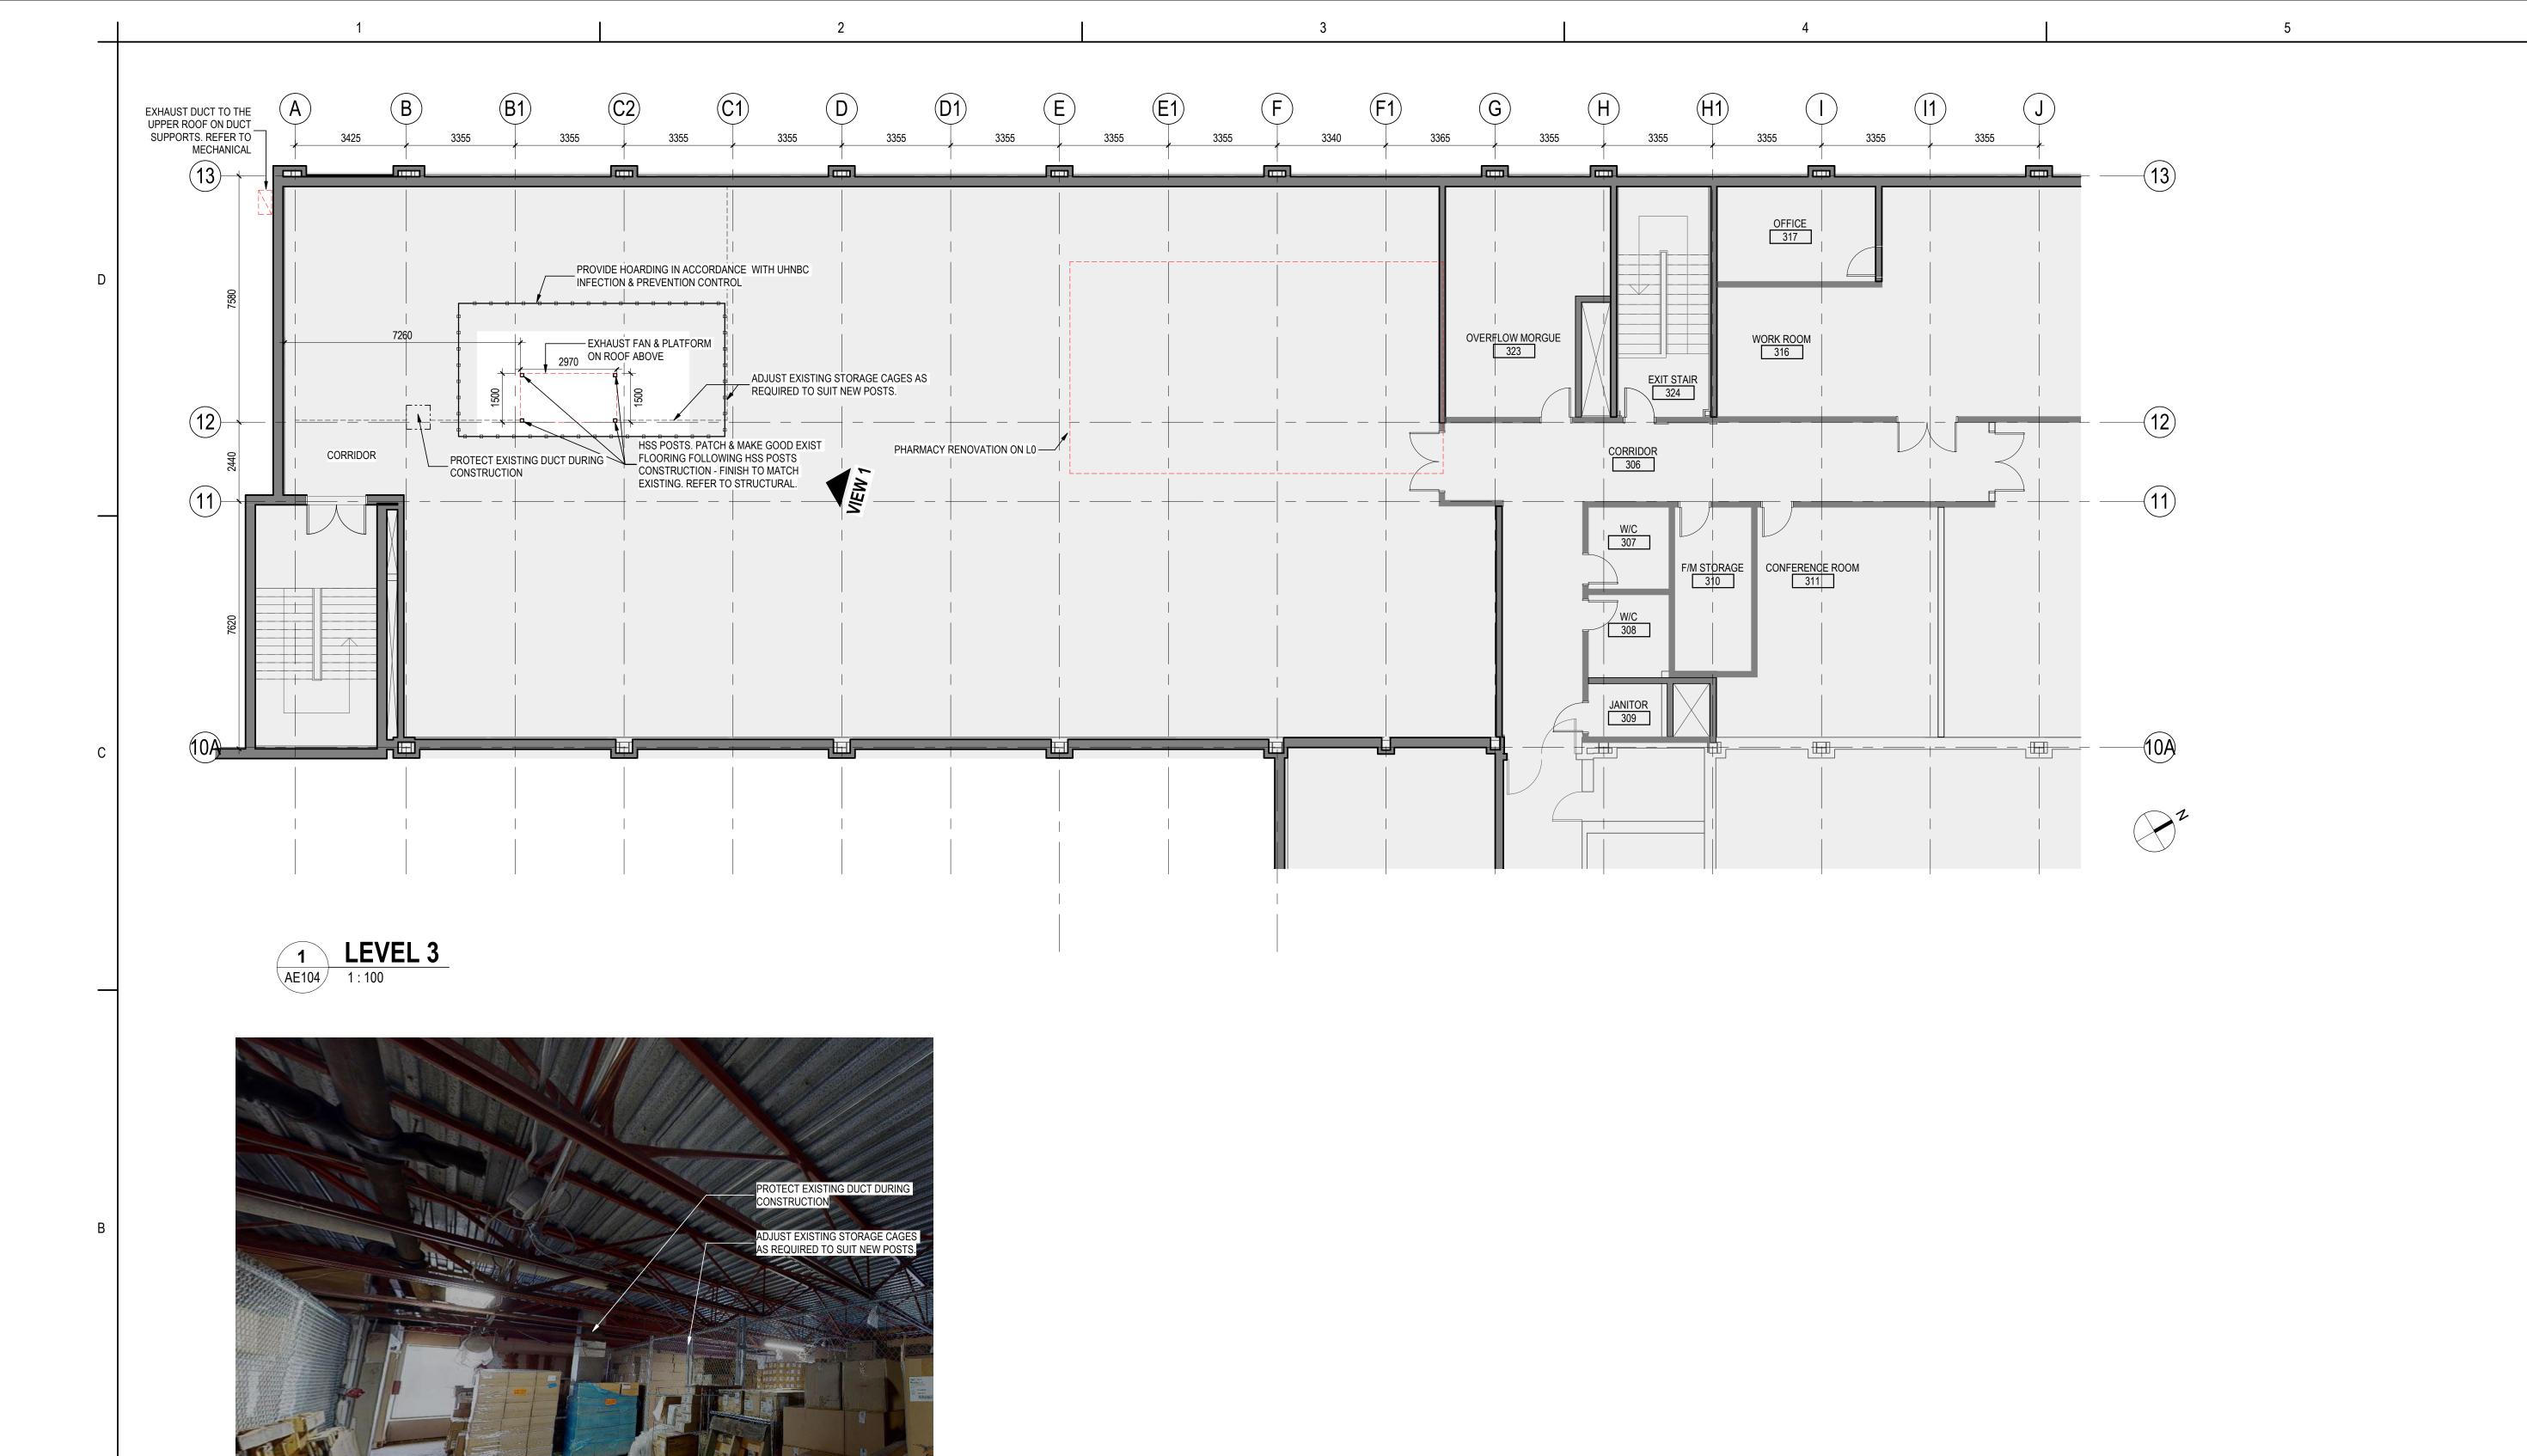
LEVEL 2 - RENOVATION PLAN

Project No. 144320228

Revision

Scale
As indicated

Drawing No.
AE103

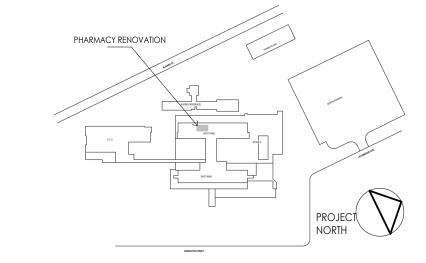


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LEVEL 3 - RENOVATION PLAN

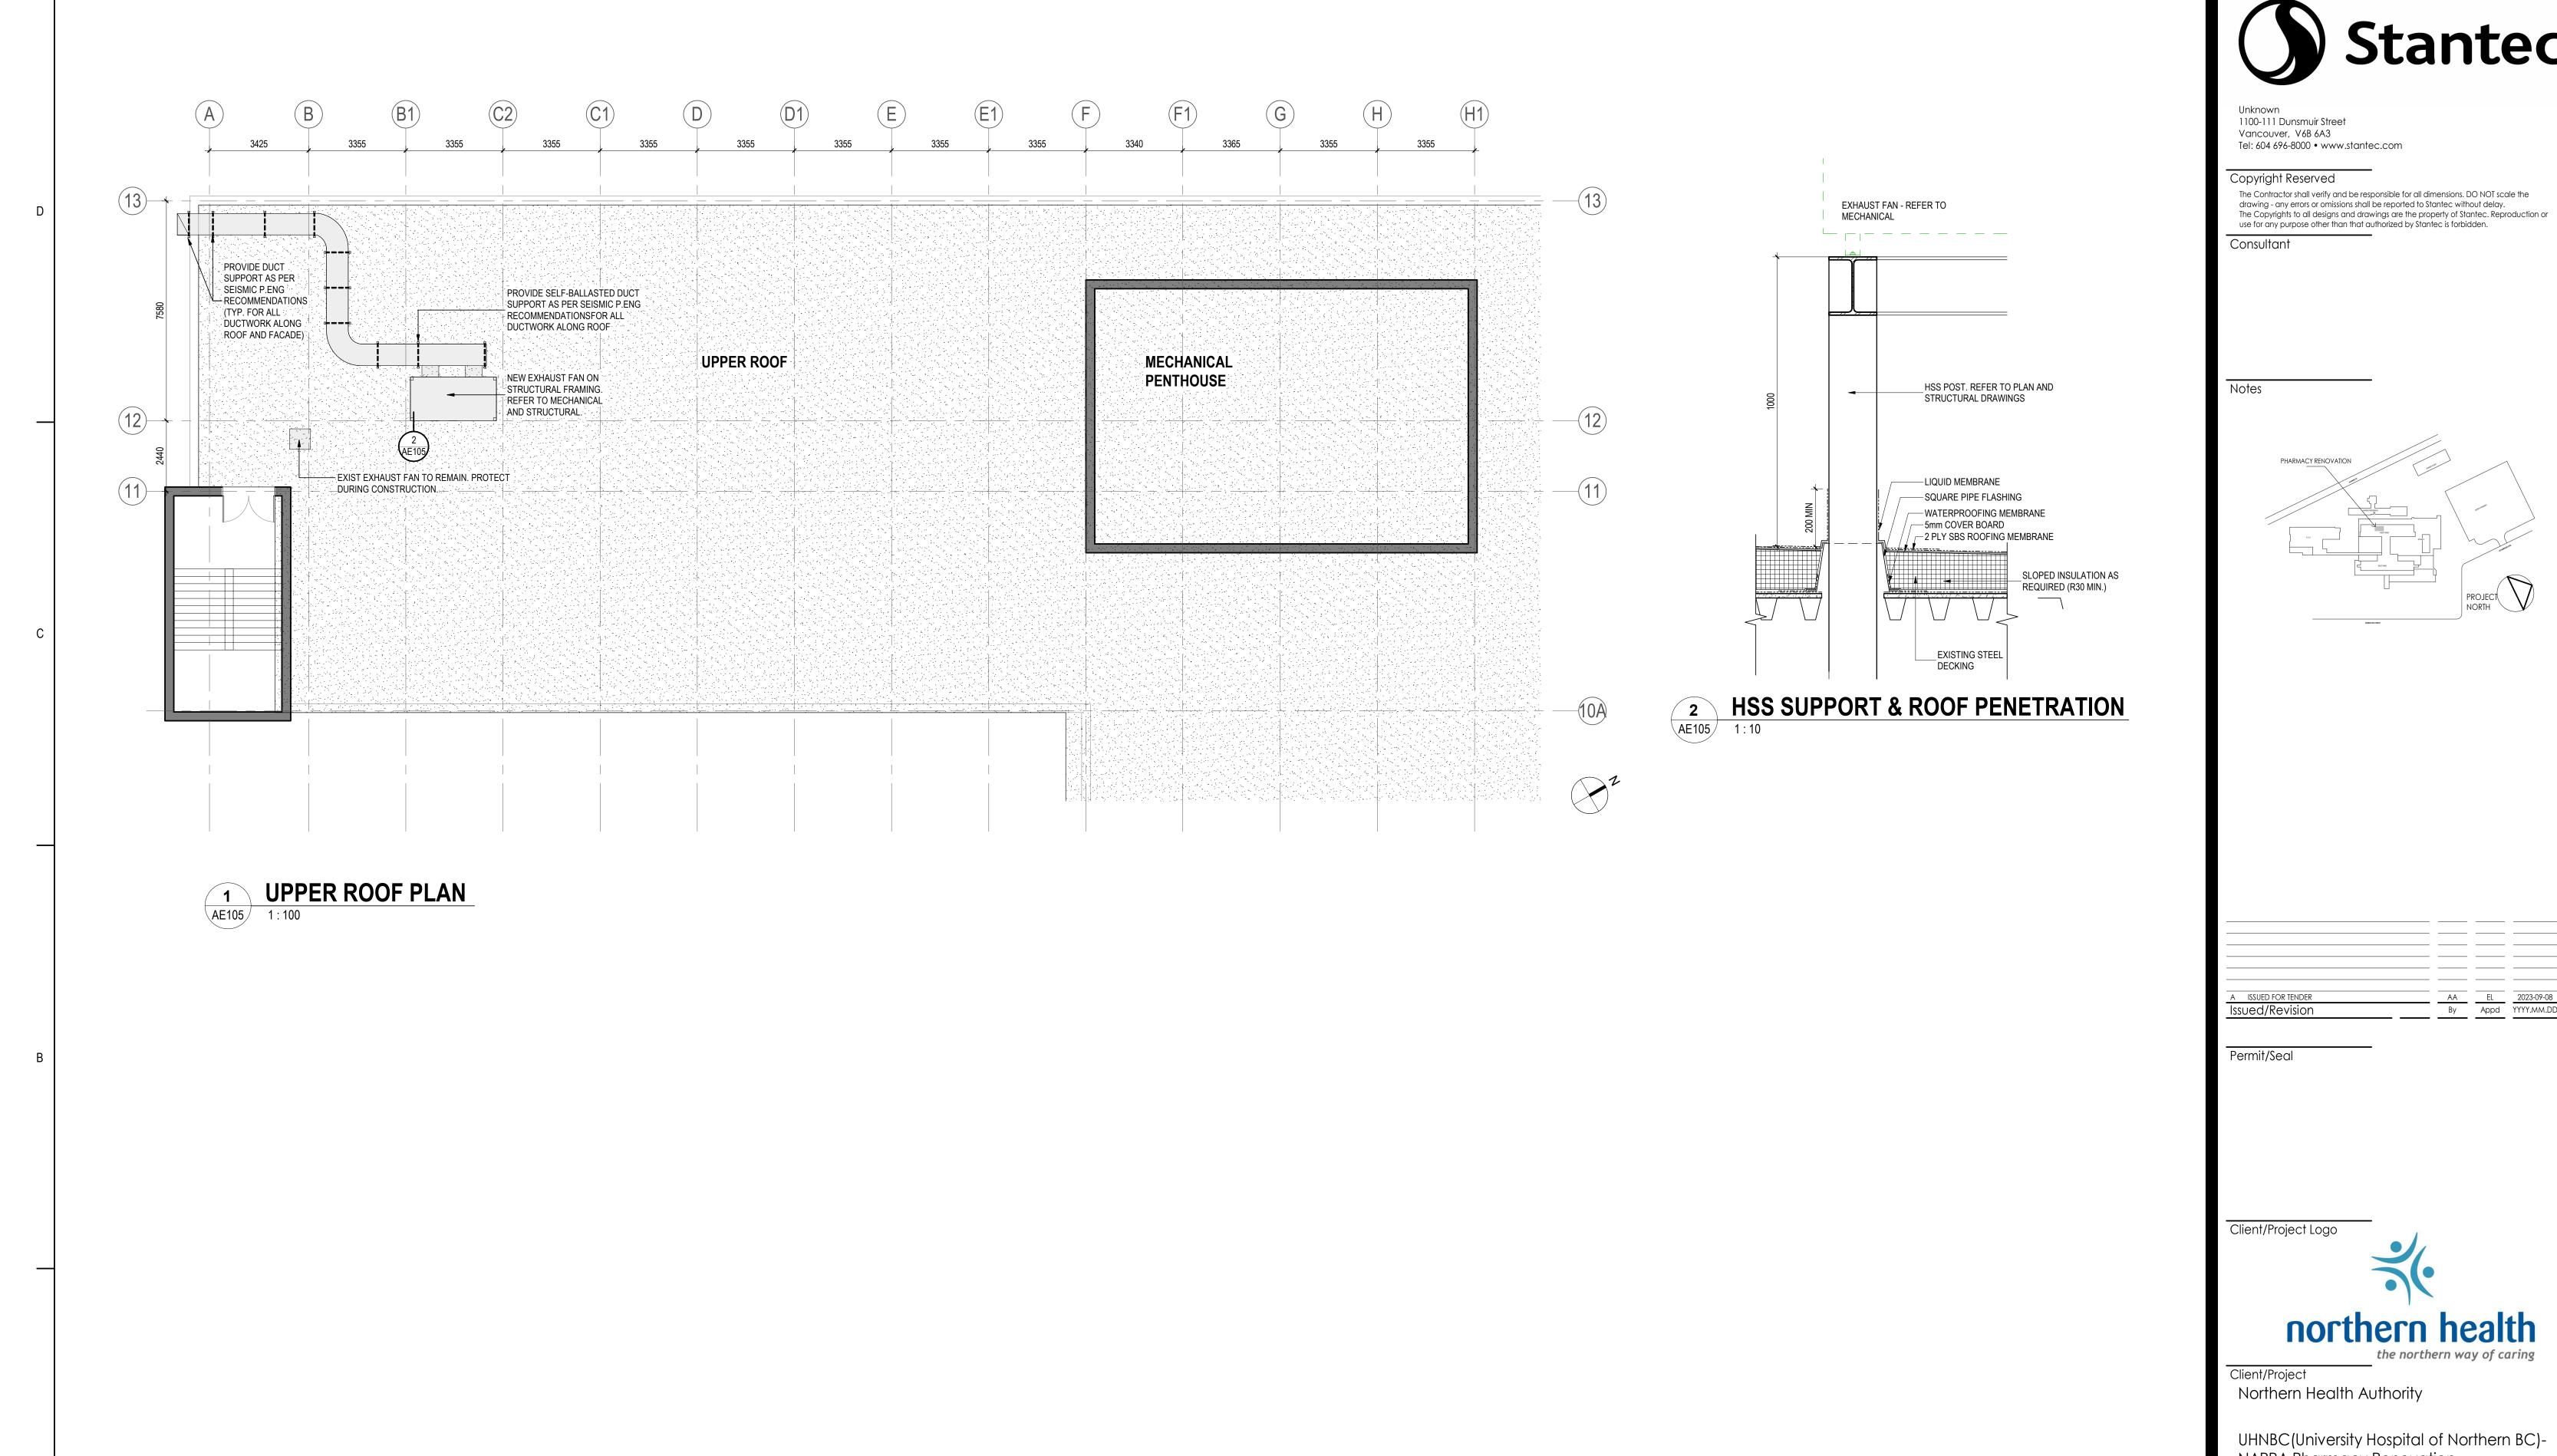
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Revision

Scale As indicated Drawing No.
AE104

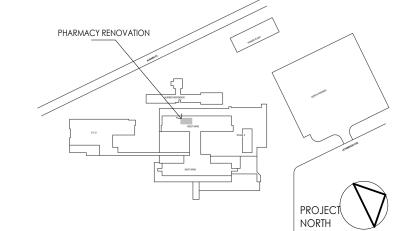
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**L3 VIEW 1** 



ORIGINAL SHEET - ARCH D

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UPPER ROOF - RENOVATION PLAN

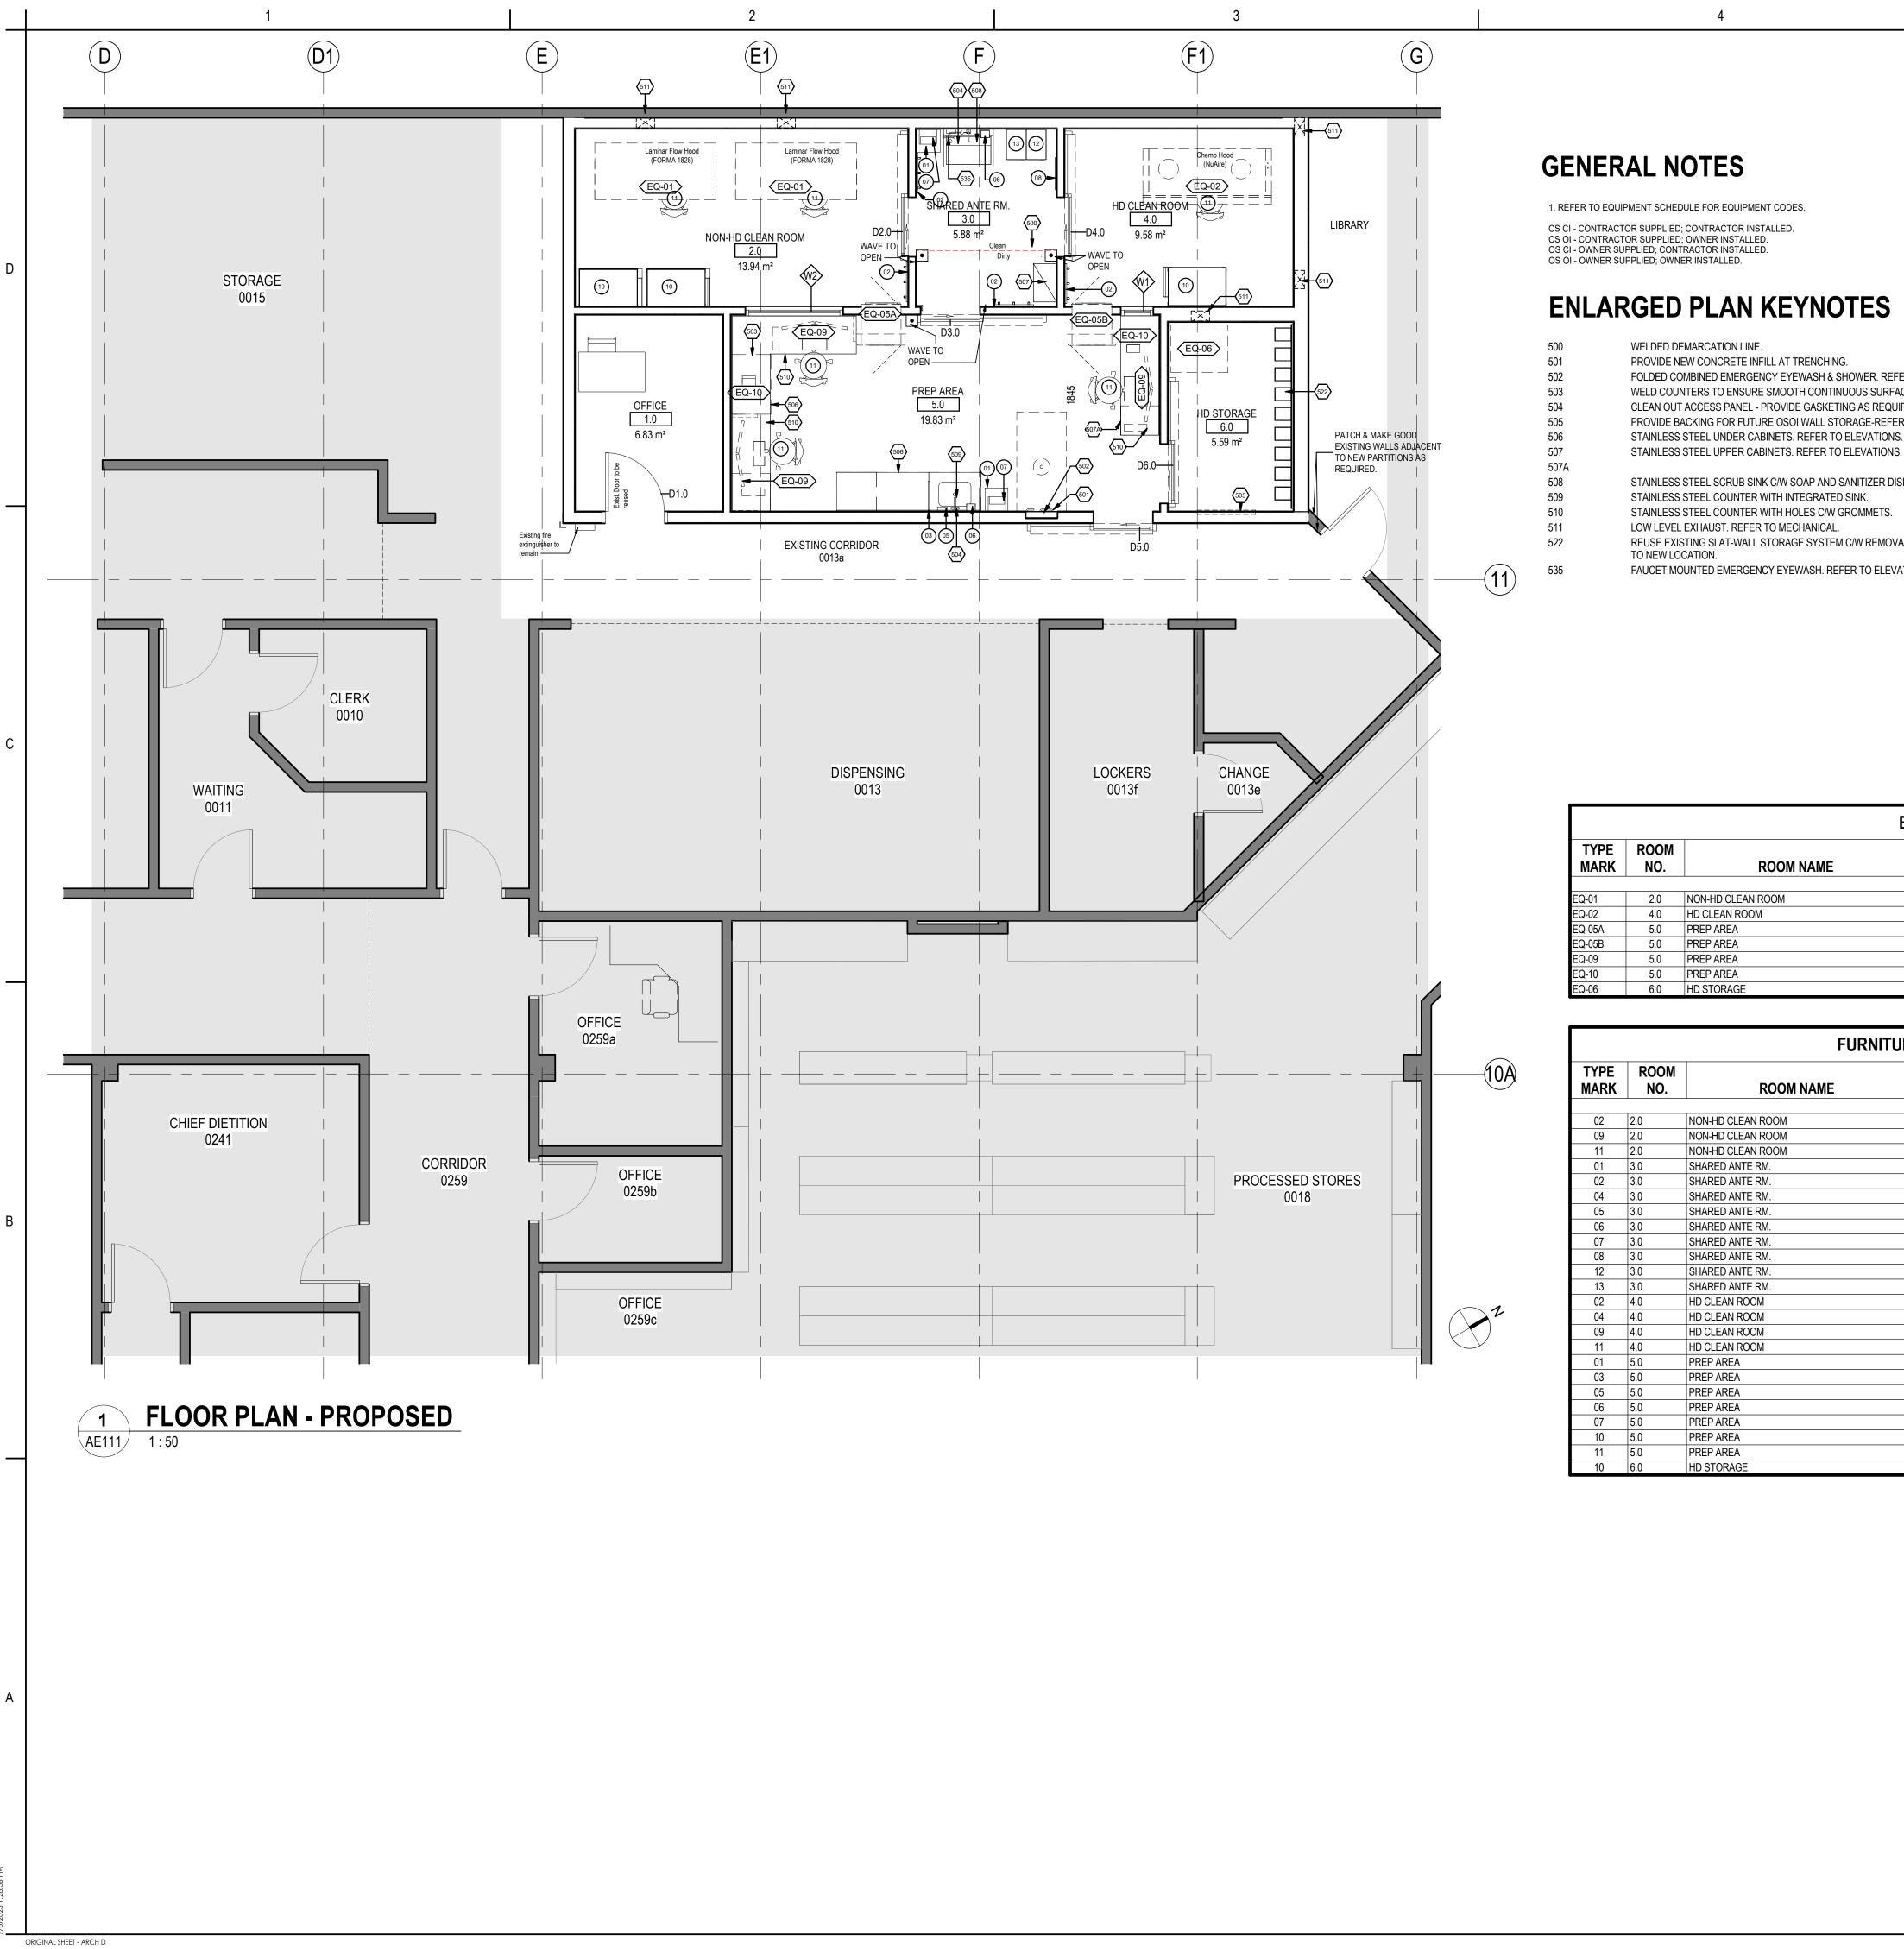
Project No. 144320228

Revision

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Scale

**AE105** 



#### **NEW WORK LEGEND**

AREA NOT INCLUDED IN SCOPE OF WORK

EXISTING WALLS TO REMAIN

**NEW WALLS** 

WELDED DEMARCATION LINE

**EXIT** EXISTING EMERGENCY EXIT

### **ENLARGED PLAN KEYNOTES**

WELDED DEMARCATION LINE.

PROVIDE NEW CONCRETE INFILL AT TRENCHING.

FOLDED COMBINED EMERGENCY EYEWASH & SHOWER. REFER TO MECHANICAL.

WELD COUNTERS TO ENSURE SMOOTH CONTINUOUS SURFACE. CLEAN OUT ACCESS PANEL - PROVIDE GASKETING AS REQUIRED. REFER TO MECHANICAL.

PROVIDE BACKING FOR FUTURE OSOI WALL STORAGE-REFER TO ELEVATIONS.

STAINLESS STEEL UNDER CABINETS. REFER TO ELEVATIONS.

STAINLESS STEEL SCRUB SINK C/W SOAP AND SANITIZER DISPENSERS DIRECTLY ABOVE. REFER TO MECHANICAL.

STAINLESS STEEL COUNTER WITH INTEGRATED SINK.

STAINLESS STEEL COUNTER WITH HOLES C/W GROMMETS.

REUSE EXISTING SLAT-WALL STORAGE SYSTEM C/W REMOVABLE HANGING STORAGE CONTAINERS. ADJUST DIMENSIONS

FAUCET MOUNTED EMERGENCY EYEWASH. REFER TO ELEVATIONS.

	EQUIPMENT SCHEDULE														
TYPE MARK															
EQ-01	2.0	NON-HD CLEAN ROOM	LMFH (FORMA 1828) ON CASTERS (NON-DUCTED)	2	CS	CI									
EQ-02	4.0	HD CLEAN ROOM	CHEMO HOOD (NuAire)- DUCTED	1	CS	CI									
EQ-05A	5.0	PREP AREA	PASS-THROUGH HATCH	1	CS	CI									
EQ-05B	5.0	PREP AREA	PASS-THROUGH HATCH	1	CS	CI									
EQ-09	5.0	PREP AREA	COMPUTER/COMPUTER MONITOR	3	OS	Ol									
EQ-10	5.0	PREP AREA	NEW LABEL PRINTER	2	OS	Ol									
FO-06	6.0	HD STORAGE	SINGLE DOOR REFRIGERATOR (CONNECTED TO THE BMS)	1	OS	Ol									

TYPE	ROOM	DOOMNAME	DECORPORTION	0011117	DDOOUDE	INIOTALL	
MARK	NO.	ROOM NAME	DESCRIPTION	COUNT	PROCURE	INSTALL	
02	2.0	NON-HD CLEAN ROOM	GOWN HOOK (3)	1	CS	CI	
09	2.0	NON-HD CLEAN ROOM	CLOCK	1		CI	
11	2.0	NON-HD CLEAN ROOM	HEIGHT-ADJUSTABLE STOOL	2	OS	OI	
01	3.0	SHARED ANTE RM.	WASTE BIN	1	OS	OI	
02	3.0	SHARED ANTE RM.	GOWN HOOK (3)	4	CS	CI	
04	3.0	SHARED ANTE RM.	150mm DEEP SS SHELF	1	CS	CI	
05	3.0	SHARED ANTE RM.	SOAP DISPENSER	1	OS	CI	
06	3.0	SHARED ANTE RM.	HAND SANITIZER	1	OS	CI	
07	3.0	SHARED ANTE RM.	LINT-FREE TOWEL DISPENSER	1	OS	CI	
08	3.0	SHARED ANTE RM.	FULL-HEIGHT MIRROR C/W CLOCK ABOVE	1	CS	CI	
12	3.0	SHARED ANTE RM.	HD CLEANING SUPPLIES LOCKER	1	CS	CI	
13	3.0	SHARED ANTE RM.	NON-HD CLEANING SUPPLIES LOCKER	1	CS	CI	
02	4.0	HD CLEAN ROOM	GOWN HOOK (3)	1	CS	CI	
04	4.0	HD CLEAN ROOM	150mm DEEP SS SHELF	1		CI	
09	4.0	HD CLEAN ROOM	CLOCK	1	OS	CI	
11	4.0	HD CLEAN ROOM	HEIGHT-ADJUSTABLE STOOL	1	OS	OI	
01	5.0	PREP AREA	WASTE BIN	1	OS	OI	
03	5.0	PREP AREA	SPLASHGUARD C/W SANITARY SEALANT	1	CS	CI	
05	5.0	PREP AREA	SOAP DISPENSER	1	OS	CI	
06	5.0	PREP AREA	HAND SANITIZER	1	OS	CI	
07	5.0	PREP AREA	LINT-FREE TOWEL DISPENSER	1	OS	CI	
10	5.0	PREP AREA	EXIST. SLAT-WALL BIN STORAGE SYSTEM	2	OS	CI	
11	5.0	PREP AREA	HEIGHT-ADJUSTABLE STOOL	3	OS	OI	
10	6.0	HD STORAGE	EXIST. SLAT-WALL BIN STORAGE SYSTEM	1	OS	CI	

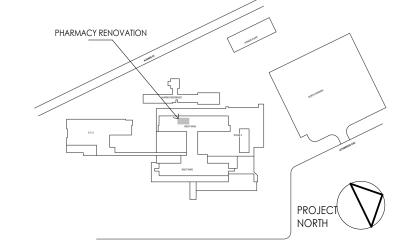


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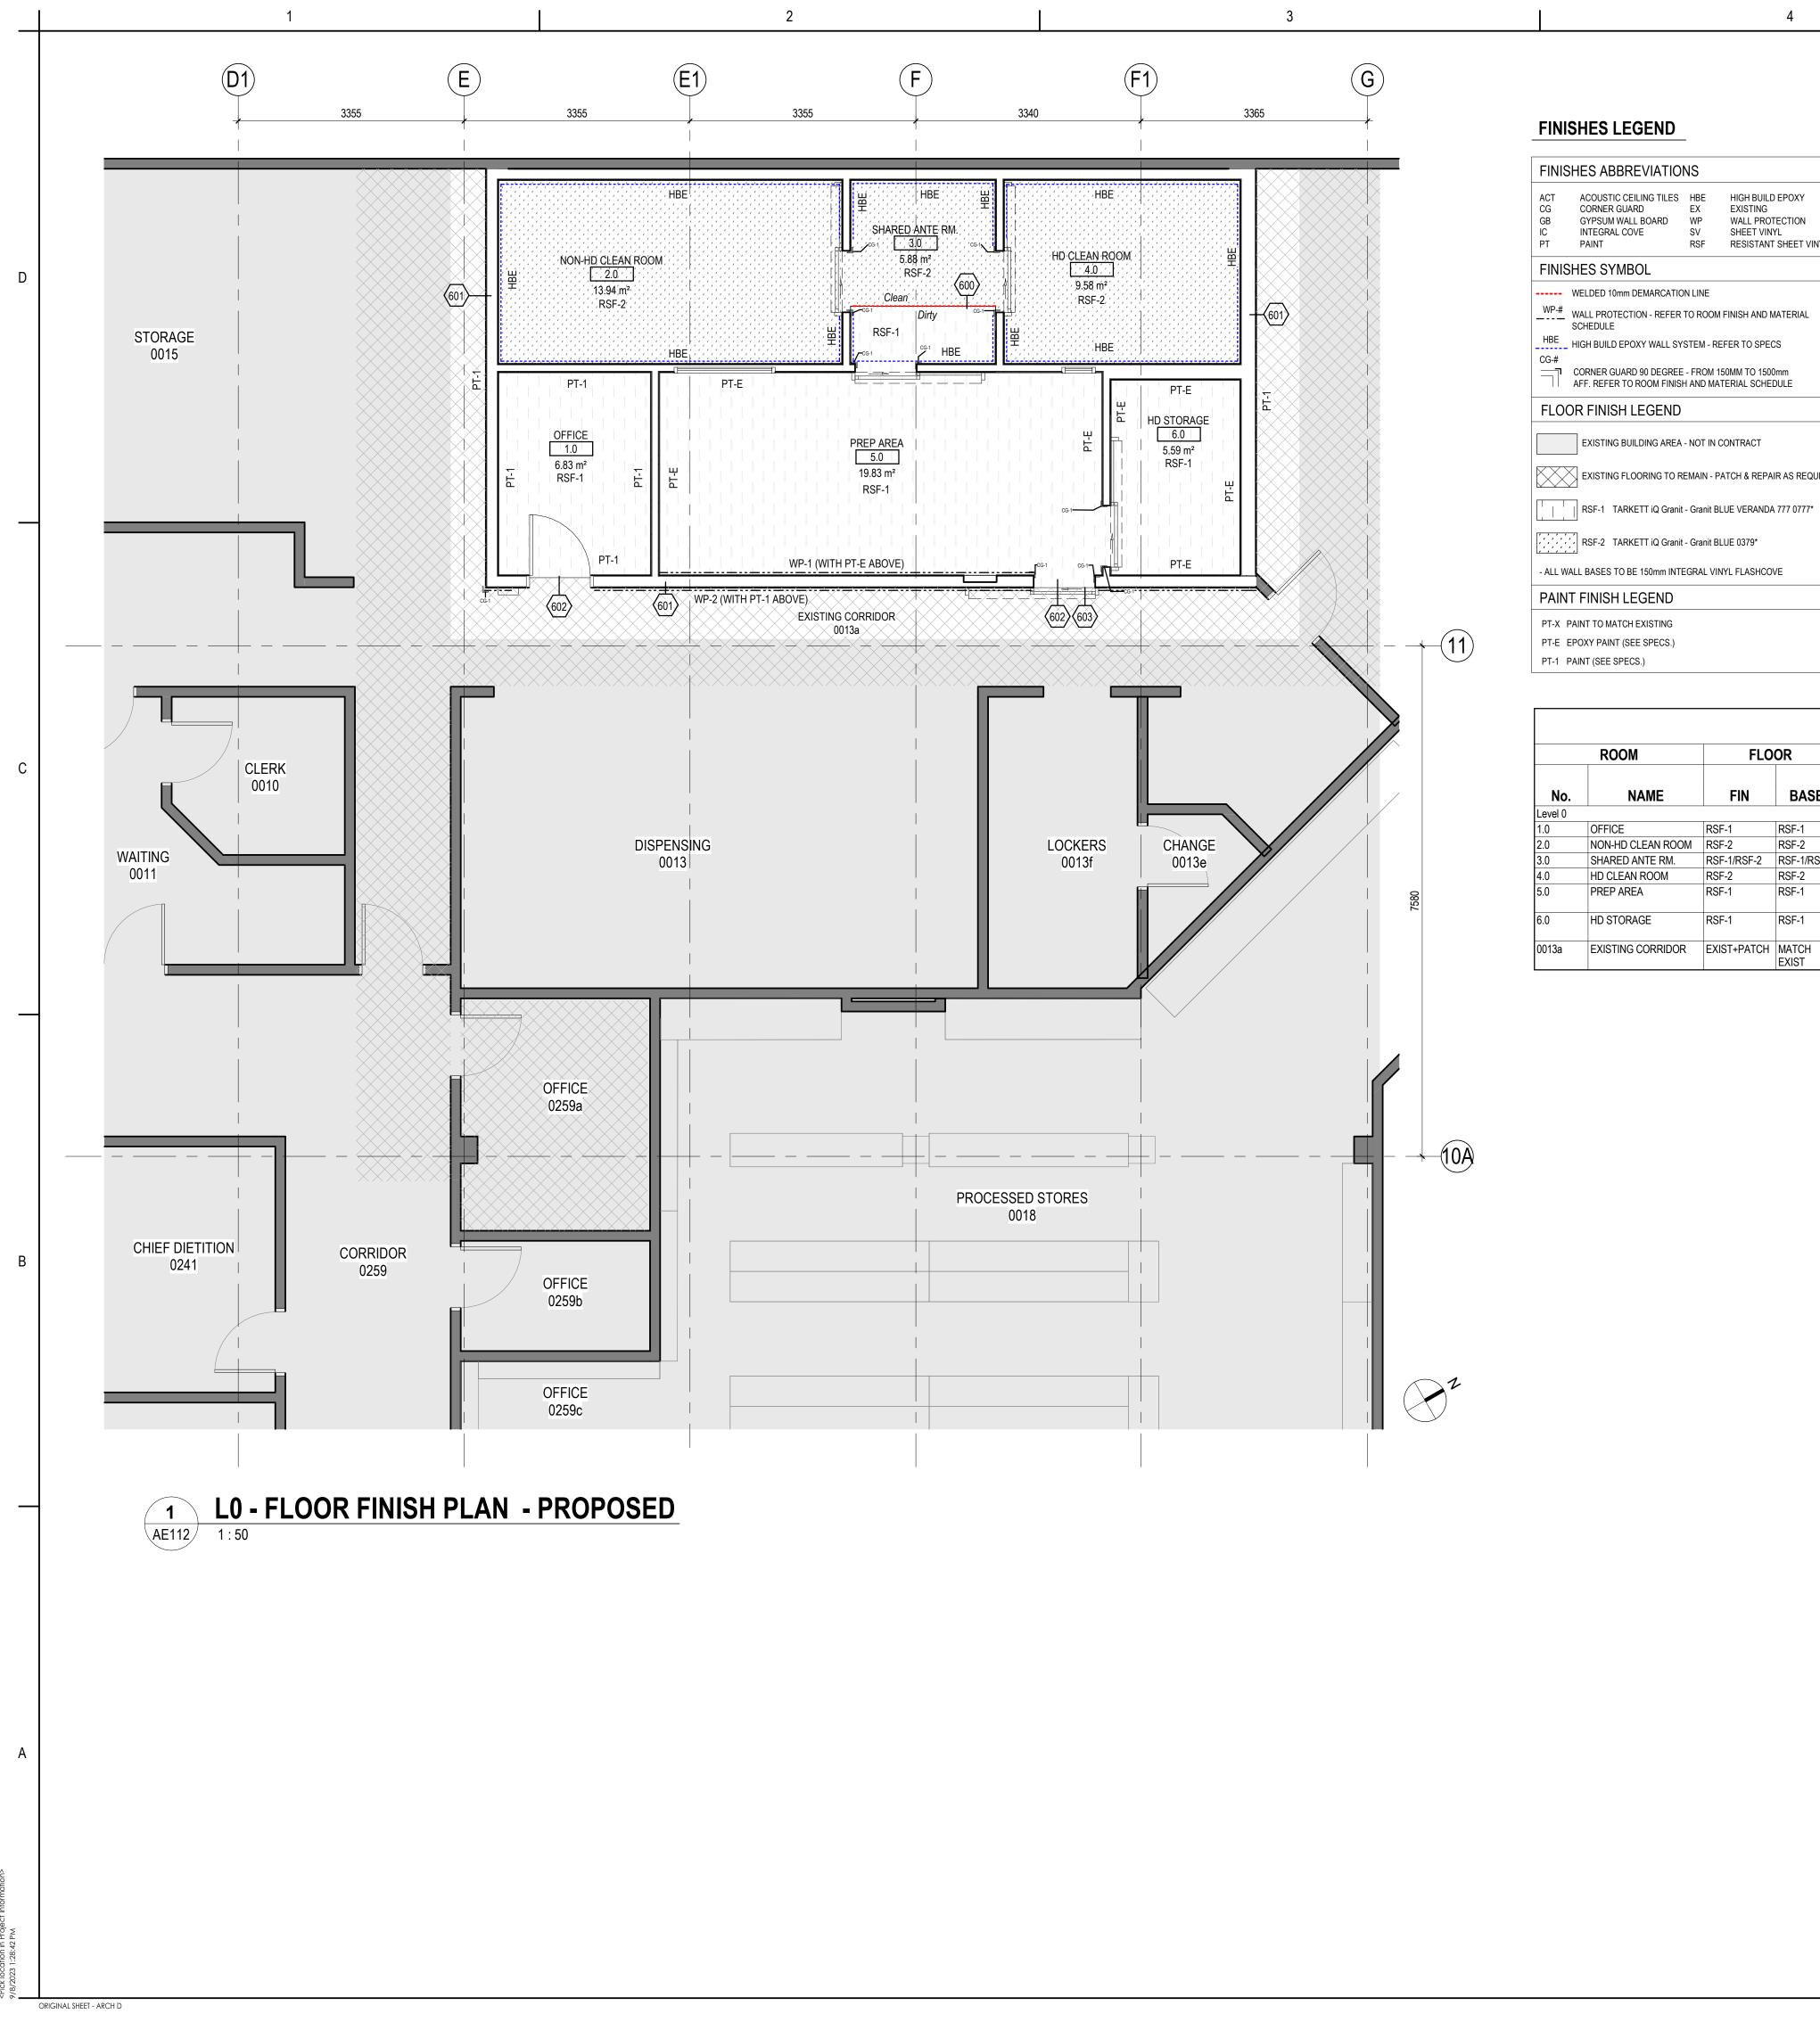
LEVEL 0 - ENLARGED EQUIPMENT & FURNITURE PLAN AND SCHEDULES

Scale

Project No. 144320228 Revision

Drawing No. **A**E111

As indicated



#### **FINISHES LEGEND**

FINIS	HES ABBREVIATIO	NS	
ACT CG GB IC PT	ACOUSTIC CEILING TILES CORNER GUARD GYPSUM WALL BOARD INTEGRAL COVE PAINT	HBE EX WP SV RSF	HIGH BUILD EPOXY EXISTING WALL PROTECTION SHEET VINYL RESISTANT SHEET VINY

#### FINISHES SYMBOL

---- WELDED 10mm DEMARCATION LINE

WP-# WALL PROTECTION - REFER TO ROOM FINISH AND MATERIAL SCHEDULE

\_\_\_\_\_HBE\_\_ HIGH BUILD EPOXY WALL SYSTEM - REFER TO SPECS

AFF. REFER TO ROOM FINISH AND MATERIAL SCHEDULE

EXISTING BUILDING AREA - NOT IN CONTRACT

EXISTING FLOORING TO REMAIN - PATCH & REPAIR AS REQUIRED

RSF-2 TARKETT iQ Granit - Granit BLUE 0379\*

- ALL WALL BASES TO BE 150mm INTEGRAL VINYL FLASHCOVE

PT-X PAINT TO MATCH EXISTING PT-E EPOXY PAINT (SEE SPECS.)

#### FINISHES GENERAL NOTES

- 2. SKIM COAT EXISTING WALLS (OVER EXISTING WALL COVERING), MAKE FLUSH WITH NEW CONSTRUCTION. PATCH AND MAKE GOOD EXISTING WALLS TO MATCH ADJACENT NEW
- CONSTRUCTION. PREPARE FOR NEW FINISHES. PAINT ALL NEW AND EXISTING WALLS AND BULKHEADS PT1 WITHIN AREA OF RENOVATION UNLESS OTHERWISE NOTED.

#### FINISHES KEYNOTES

. REFER TO REFLECTED CEILING PLAN FOR CEILING FINISHES.

- NEW 100mm WIDE WELDED DEMARCATION LINE REFER TO SPECIFICATIONS.
- PATCH AND WELD EXISTING FLOOR AT NEW INFILL WALL. PROVIDE BASE TO MATCH EXISTING.
  - WELD NEW FLOOR FINISH AT EXISTING FLOOR FINISH. PROVIDE TRANSITION STRIP AS REQUIRED. REFER TO MANUFACTURER'S
- RECOMMENDATIONS.

PROVIDE PRIVACY WINDOW PROTECTIVE FILM.

ROOM FINISH SCHEDULE ROOM **WALLS CEILINGS FLOOR** SOUTH MAT FIN MAT FIN MAT FIN MAT FIN MAT FIN REMARKS NON-HD CLEAN ROOM RSF-2 W/ GASKETED FIXTURES GASKETED CLEAN ROOM CEILINGS & PREP AREA GASKETED CLEAN ROOM CEILINGS & HD STORAGE EXISTING CORRIDOR EXIST+PATCH MATCH REPLACE ANY DAMAGED TILES &

PT-1

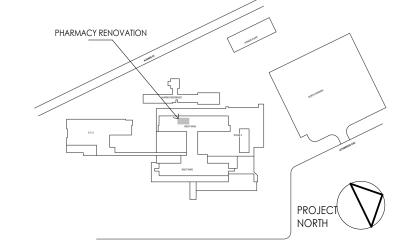


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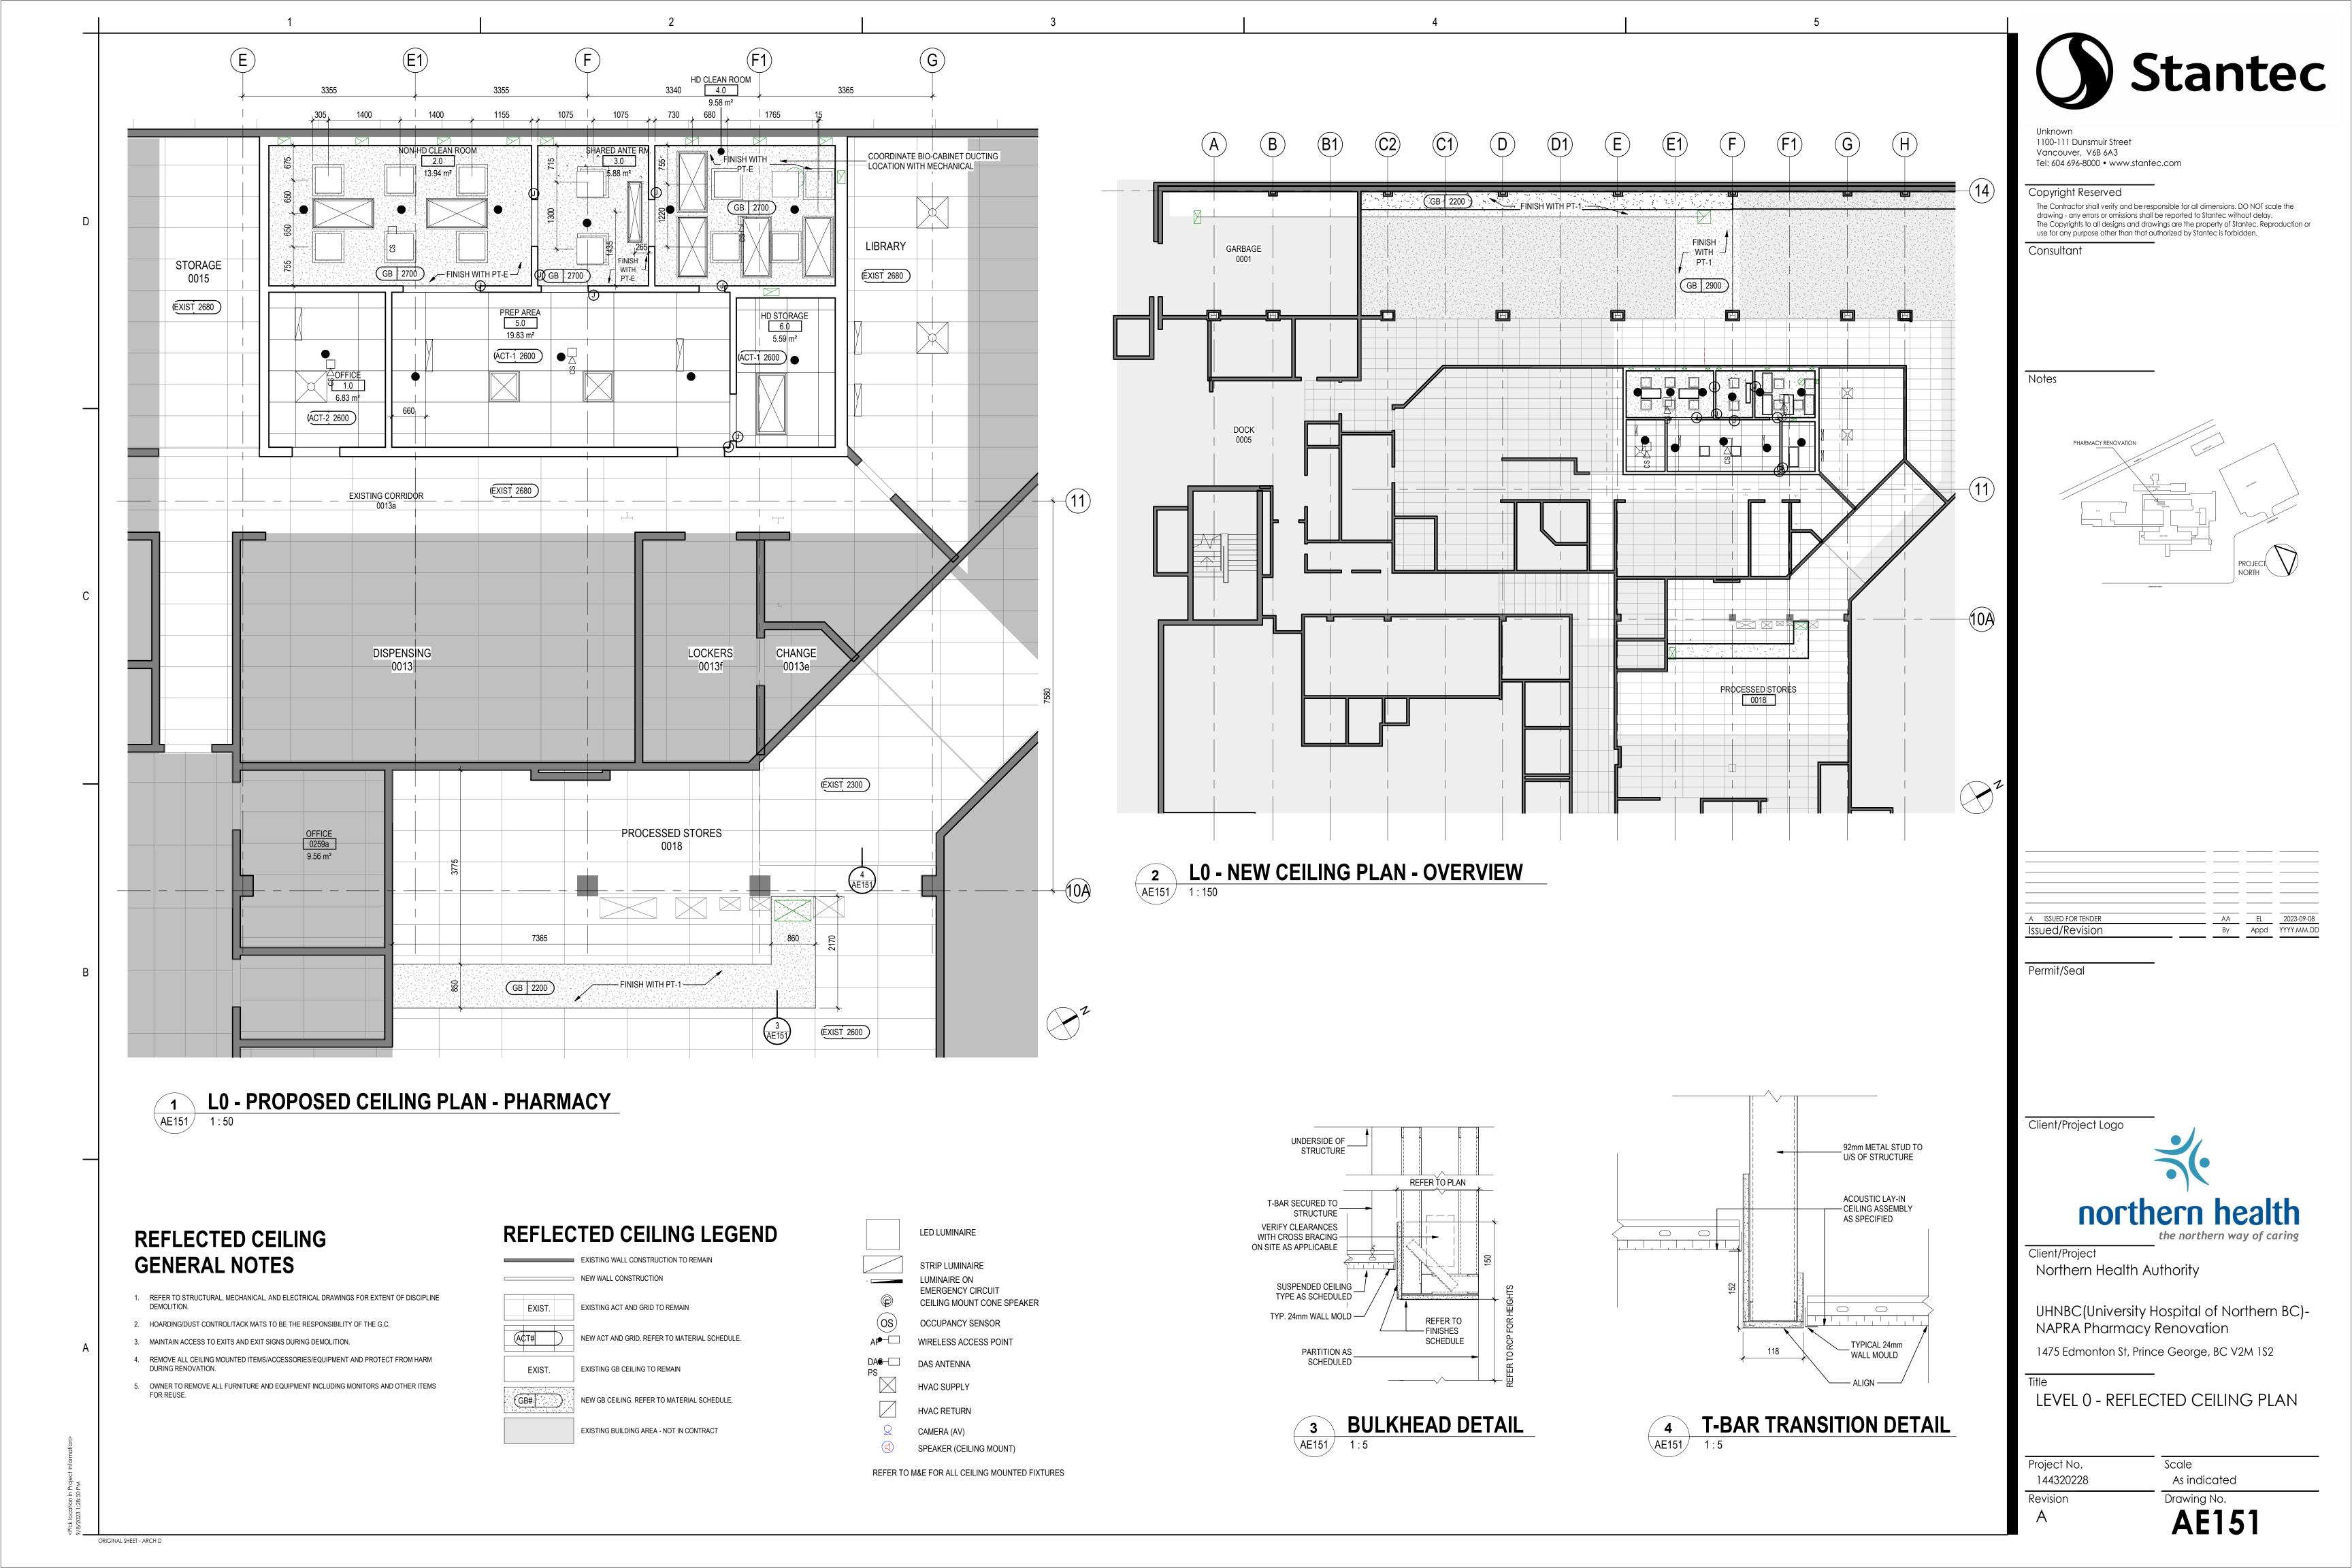
LEVEL 0 - FINISHES PLANS & ROOM FINISH SCHEDULE

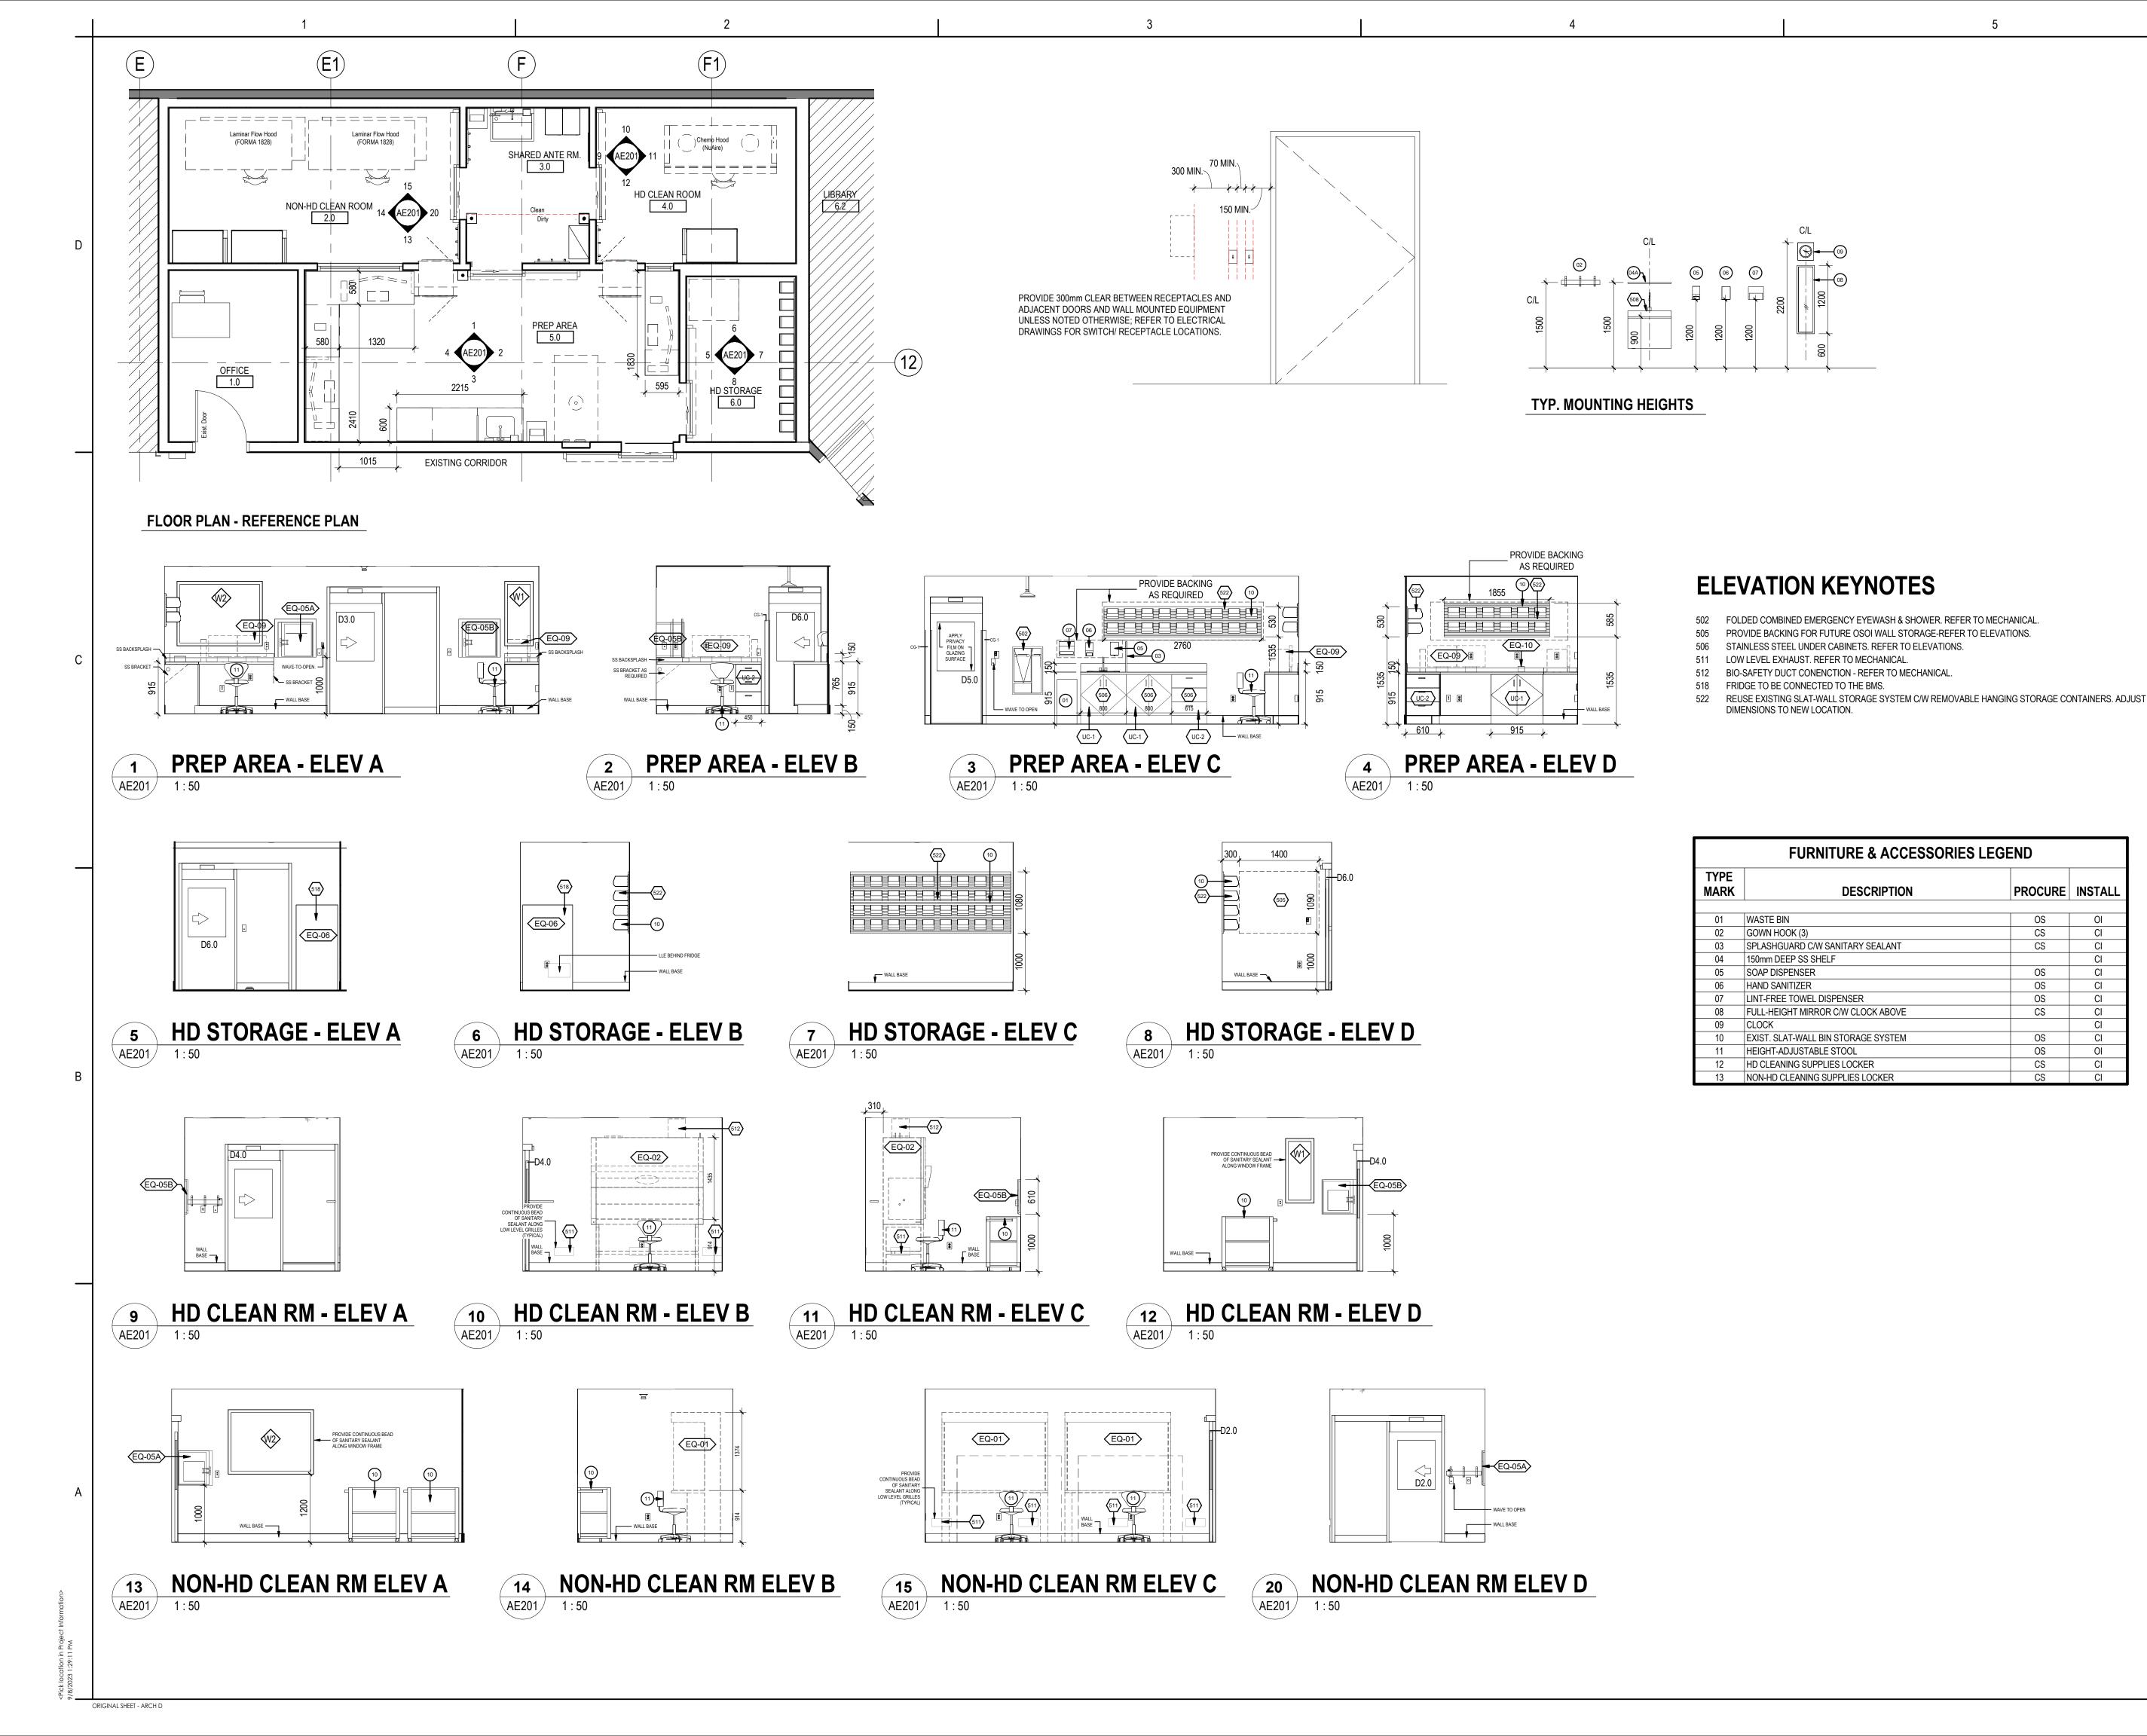
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Scale

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Drawing No. **AE112** 





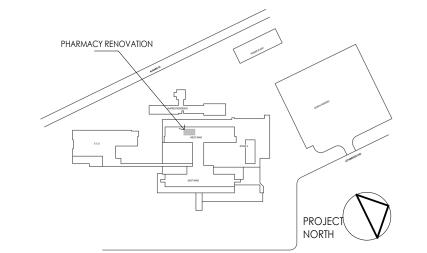


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**FURNITURE & ACCESSORIES LEGEND** 

PROCURE INSTALL

CI

CI

CI

CI

CI

CI

CI

CS

CS

OS

OS

OS

CS

**DESCRIPTION** 

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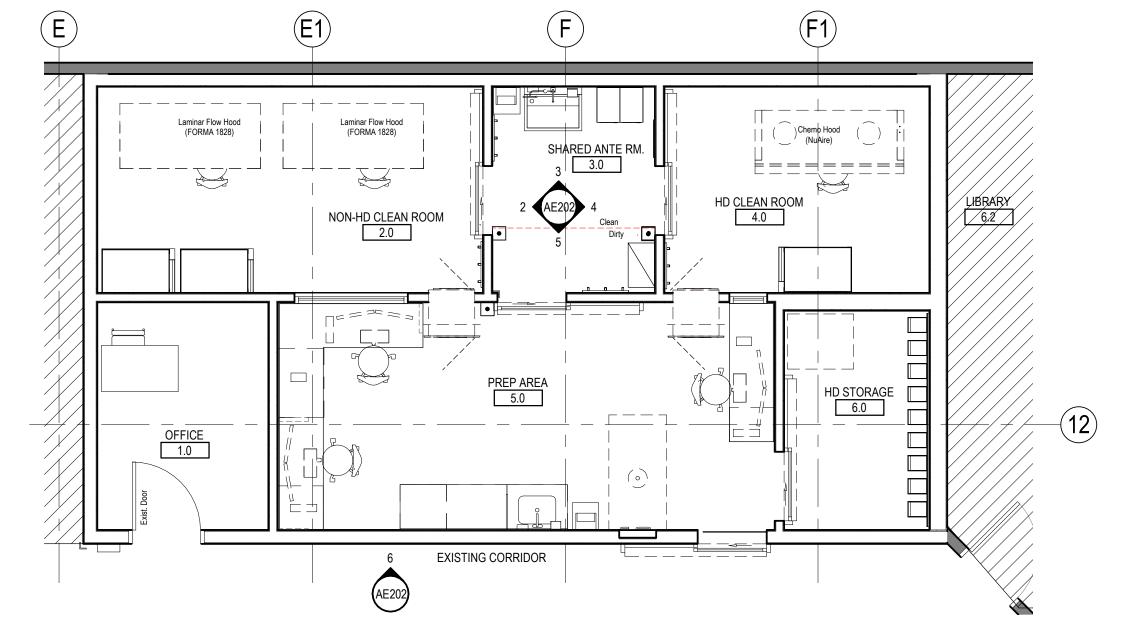
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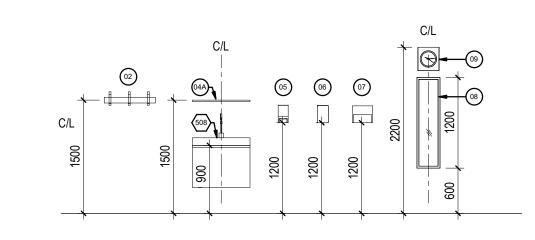
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INTERIOR ELEVATIONS

Project No.	Scale
144320228	As indicated
Revision A	Drawing No. <b>AE201</b>

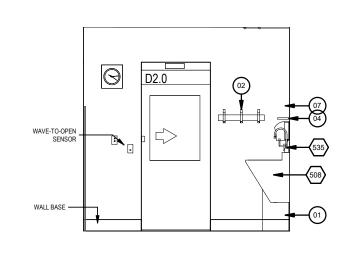


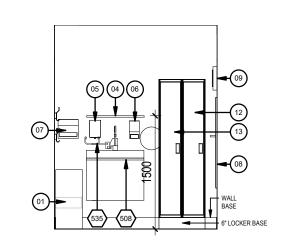
	<b>FURNITURE &amp; ACCESSORIES LEGEND</b>												
TYPE Mark	DESCRIPTION	PROCURE	INSTALL										
01	WASTE BIN	OS	OI										
02	GOWN HOOK (3)	CS	CI										
03	SPLASHGUARD C/W SANITARY SEALANT	CS	CI										
04	150mm DEEP SS SHELF		CI										
05	SOAP DISPENSER	OS	Cl										
06	HAND SANITIZER	OS	Cl										
07	LINT-FREE TOWEL DISPENSER	OS	Cl										
08	FULL-HEIGHT MIRROR C/W CLOCK ABOVE	CS	Cl										
09	CLOCK		Cl										
10	EXIST. SLAT-WALL BIN STORAGE SYSTEM	OS	CI										
11	HEIGHT-ADJUSTABLE STOOL	OS	Ol										
12	HD CLEANING SUPPLIES LOCKER	CS	CI										
13	NON-HD CLEANING SUPPLIES LOCKER	CS	CI										

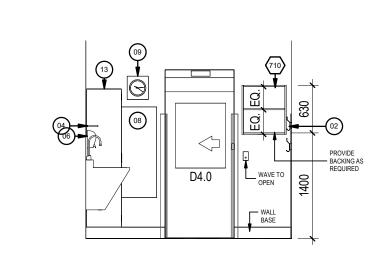


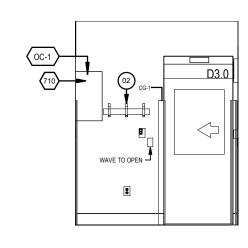
TYP. MOUNTING HEIGHTS











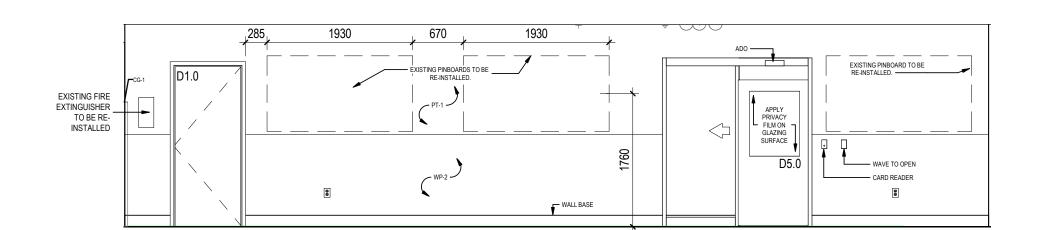
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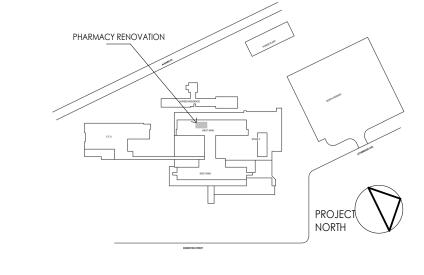
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Title

INTERIOR ELEVATIONS

 Project No.
 Scale

 144320228
 1:50

Drawing No. **AE202** 

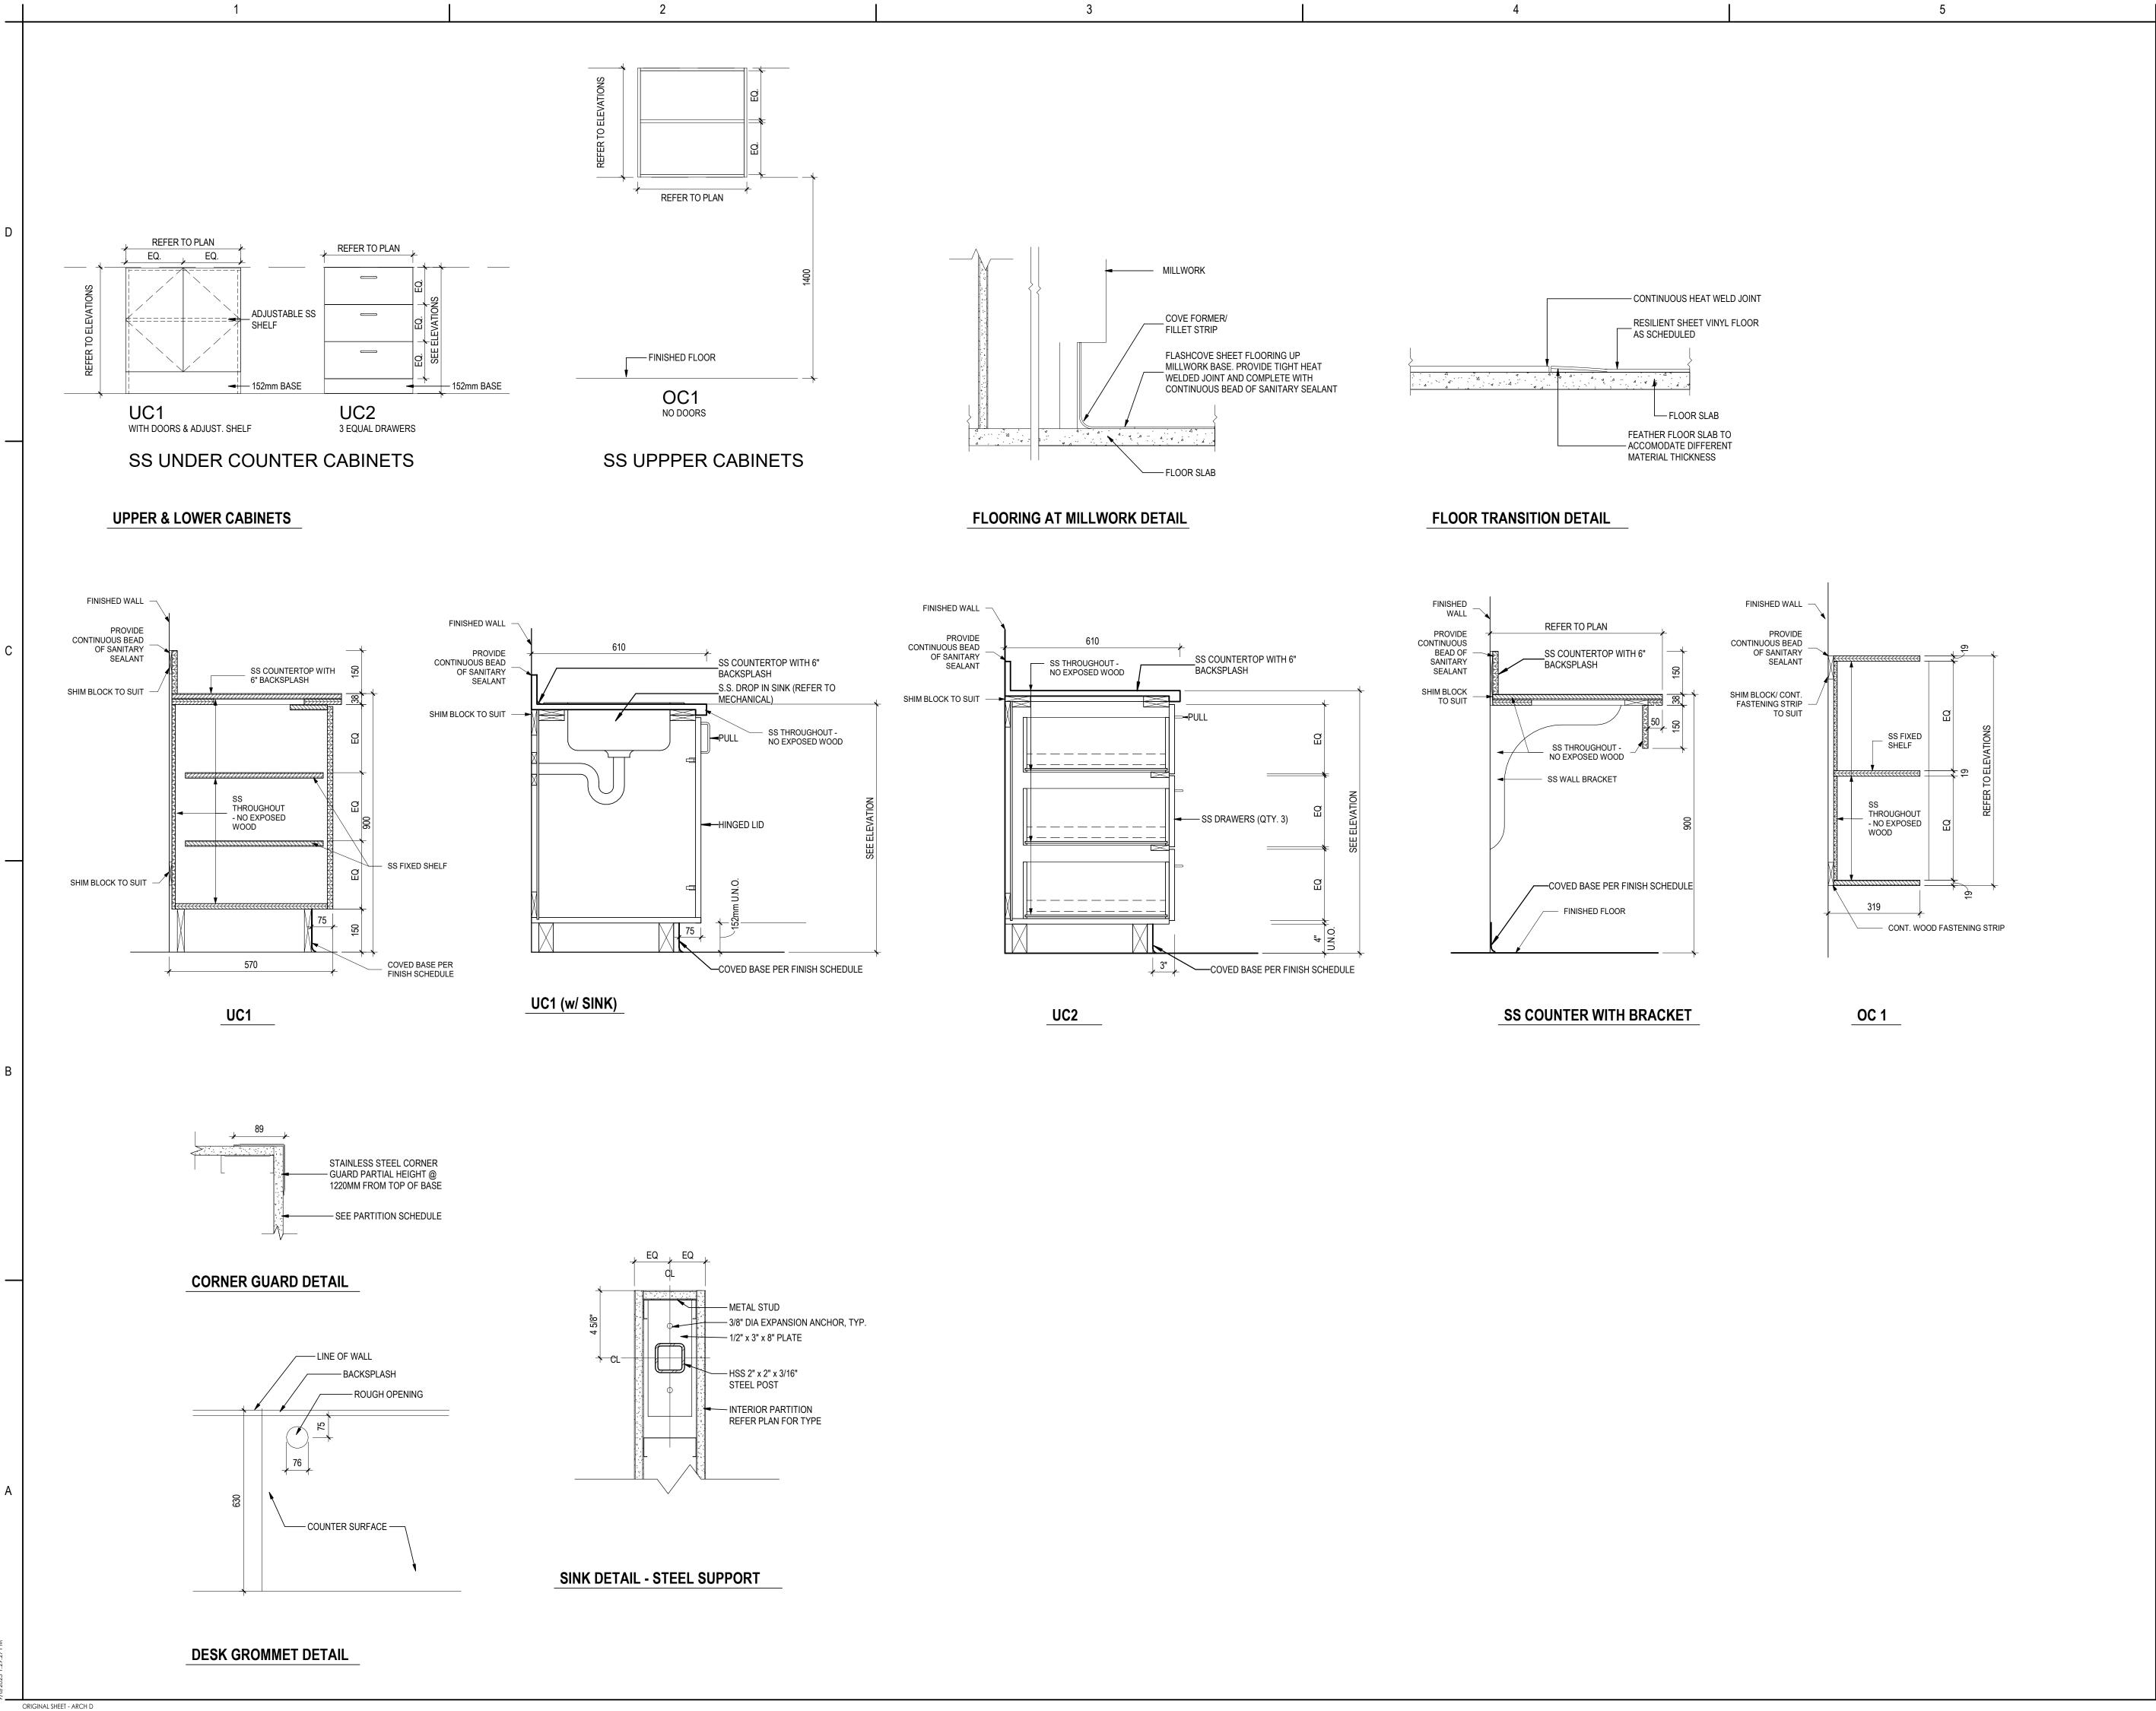
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ORIGINAL SHEET - ARCH D

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Α

Revision



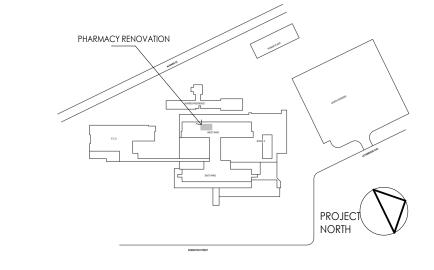


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Permit/Seal

Client/Project Logo



Client/Project

Northern Health Authority

UHNBC(University Hospital of Northern BC)-NAPRA Pharmacy Renovation

1475 Edmonton St, Prince George, BC V2M 1S2

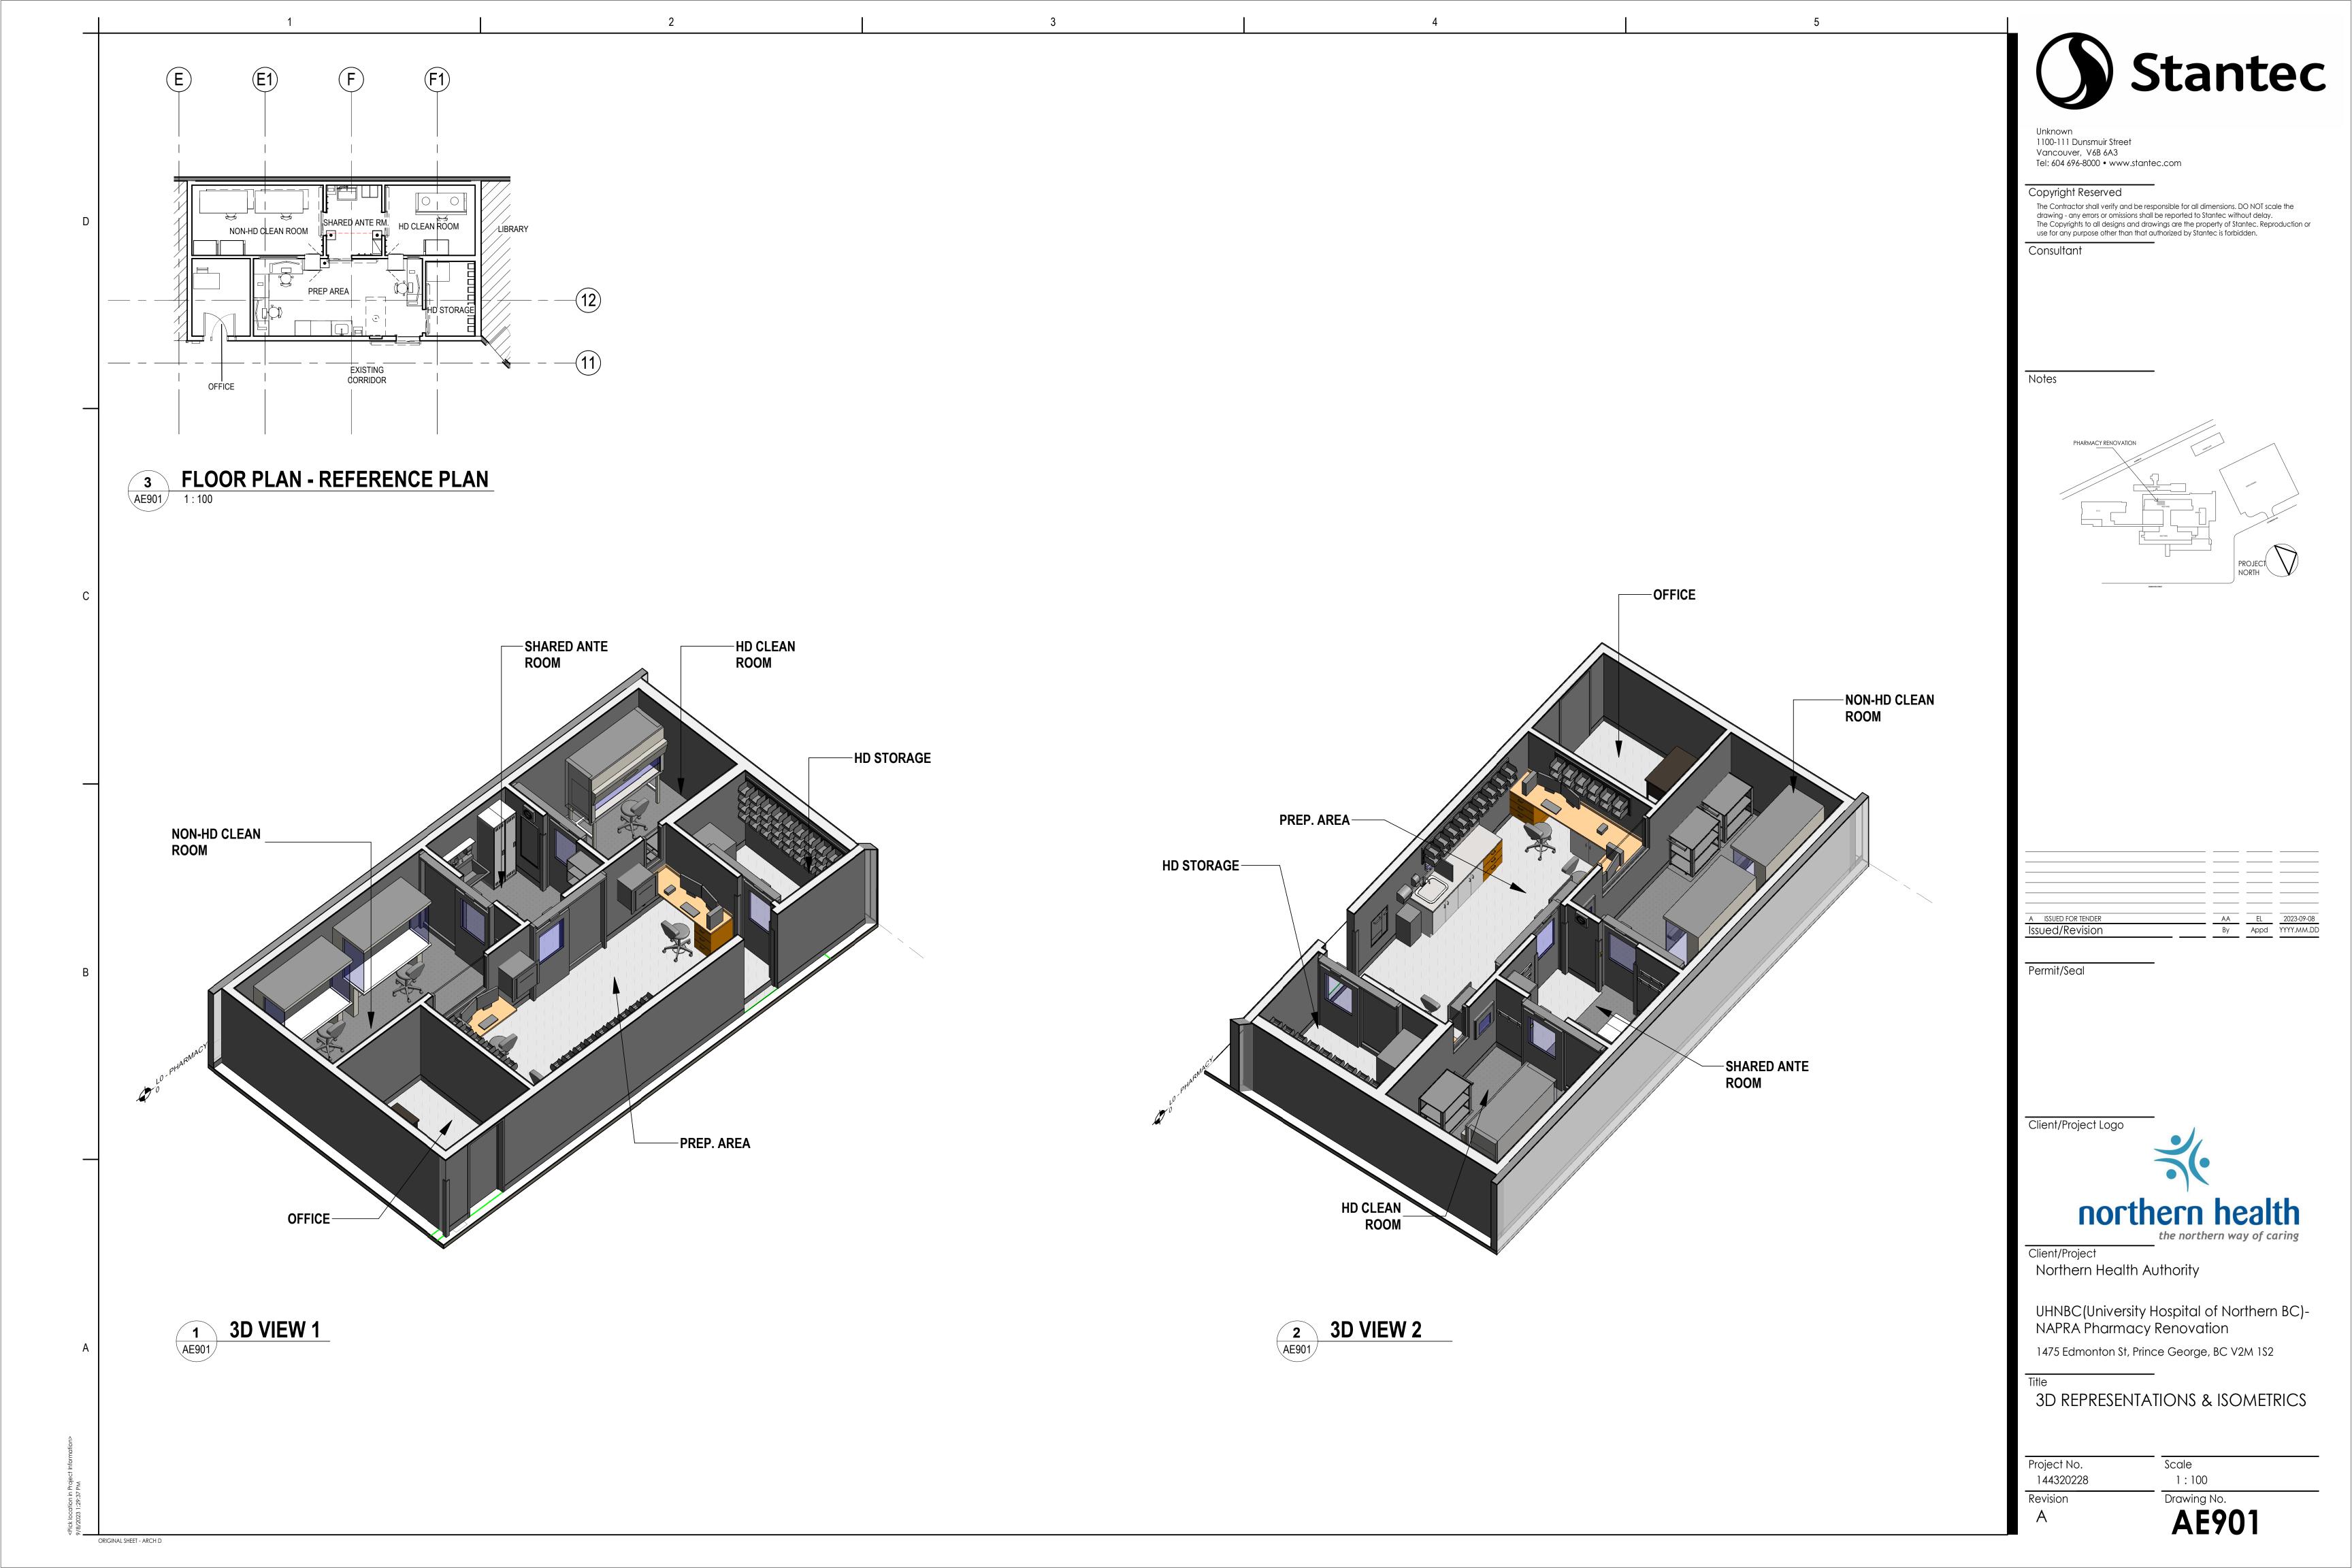
Revision

MILLWORK DETAILS

Project No. Scale 144320228

Drawing No.
AE302

As indicated



**PIPING SYSTEMS (HVAC)** 

**VENTILATION (HVAC)** 

AIR FLOW ARROW ├ 18"x12" ├──18"x12"─ RECTANGULAR DUCT AND SIZE\* <sup>!</sup>──18"ø──**-**18"ø<del>──-</del> ROUND DUCT AND SIZE\*  $P = 18"x12"ø \longrightarrow 18"x12"ø \longrightarrow FLAT OVAL DUCT AND SIZE*$ EXTERIOR DUCT TREATMENT\* 18"x12" 18"x12" → 18"x12"→ RECTANGULAR DUCT WITH ACOUSTIC LINING\*

DUCT SECTION, SUPPLY AIR. SIZE\* IS HORIZONTAL DIM. x VERTICAL DIM. APPLIES TO RECT., ROUND AND OVAL DUCT SECTION, OUTSIDE AIR. APPLIES TO RECT., ROUND AND OVAL DUCT SECTION, RETURN AIR. APPLIES TO RECT., ROUND AND OVAL

DUCT SECTION, EXHAUST AIR. APPLIES TO RECT., ROUND AND OVAL

FLEXIBLE DUCT ELBOW TURN, SUPPLY DOWN. APPLIES TO RECT., ROUND AND OVAL ELBOW TURN, OUTSIDE AIR DOWN. APPLIES TO RECT., ROUND AND OVAL

ELBOW TURN, EXHAUST DOWN. APPLIES TO RECT., ROUND AND OVAL CHANGE IN DUCT ELEVATION RISING IN DIRECTION INDICATED

CHANGE IN DUCT ELEVATION DROPPING IN DIRECTION INDICATED

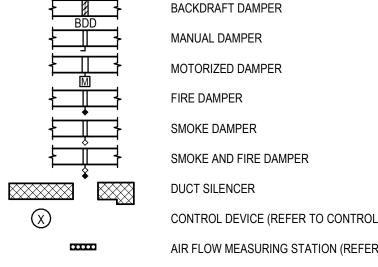
ELBOW, RECTANGULAR, SMOOTH RADIUS WITH SPLITTER VANES (0.25 R/W DEFAULT) ELBOW, RECTANGULAR, SMOOTH RADIUS WITHOUT VANES (1.5 R/W

DEFAULT) ELBOW, ROUND, SMOOTH RADIUS (1.5 R/W DEFAULT) MITERED ELBOW, RECTANGULAR, WITH TURNING VANES

RECTANGULAR TO ROUND TRANSITION DUCT ACCESS DOOR (TOP, SIDE, BOTTOM) FLEXIBLE CONNECTION

> \* NOTE: ALL DUCT SIZES ARE INTERIOR, FREE DIMENSIONS (ALWAYS WIDTH X HEIGHT IN FLOOR PLAN AND SECTION)

**VENTILATION (HVAC)** 



CONTROL DEVICE (REFER TO CONTROLS LEGEND) AIR FLOW MEASURING STATION (REFER TO CONTROLS LEGEND)

— QUANTITY AIR OUTLET OR INLET TAG (REFER TO SCHEDULE) - SIZE (IN.) VOLUME (CFM)

RECTANGULAR DIFFUSER, SUPPLY. OPTIONAL ARROWS SHOW THE FLOW DIRECTION. RECTANGULAR REGISTER OR GRILLE, RETURN RECTANGULAR REGISTER OR GRILLE, EXHAUST ROUND DIFFUSER, SUPPLY LINEAR DIFFUSER SIDEWALL REGISTER OR GRILLE, SUPPLY SIDEWALL GRILLE, RETURN OR EXHAUST UNDERCUT DOOR

DOOR GRILLE OR LOUVER TRANSFER GRILLE OR LOUVER COIL (REFER TO CONTROLS LEGEND)

ID-# **EQUIPMENT TAG** 

- QUANTITY TYPE LENGTH (FT)

RADIATION HEATING TAG (REFER TO SCHEDULE)

CAPACITY (MBH)

400-1620 Dickson Avenue Kelowna, V1Y 9Y2 Tel: (250) 860-3225 • www.stantec.com Copyright Reserved The Contractor shall verify and be responsible for all dimensions. DO NOT scale the drawing - any errors or omissions shall be reported to Stantec without delay. The Copyrights to all designs and drawings are the property of Stantec. Reproduction or use for any purpose other than that authorized by Stantec is forbidden. Consultant Notes ELBOW TURN, RETURN DOWN. APPLIES TO RECT., ROUND AND OVAL

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the northern way of caring

Client/Project Northern Health Authority

UHNBC (University Hospital of Northern BC)-Pharmacy upgrade

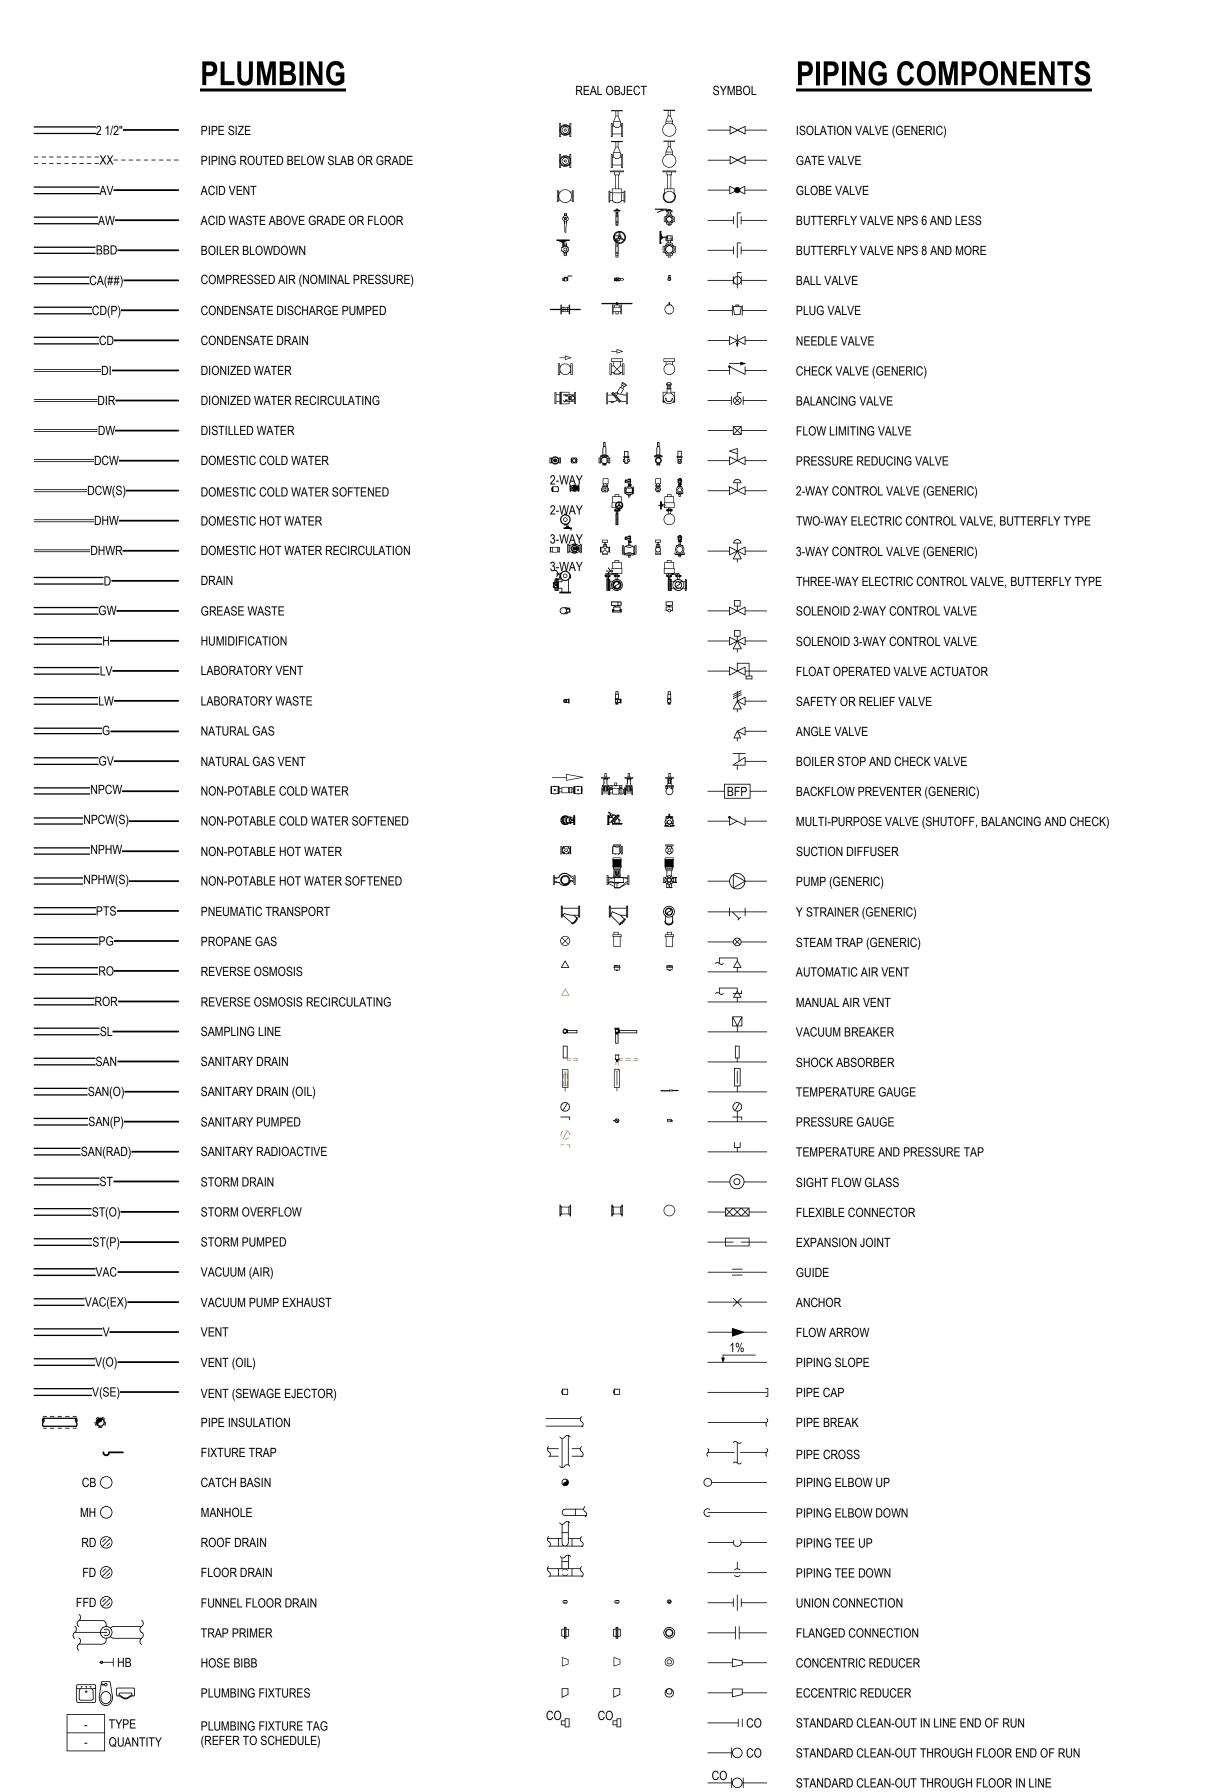
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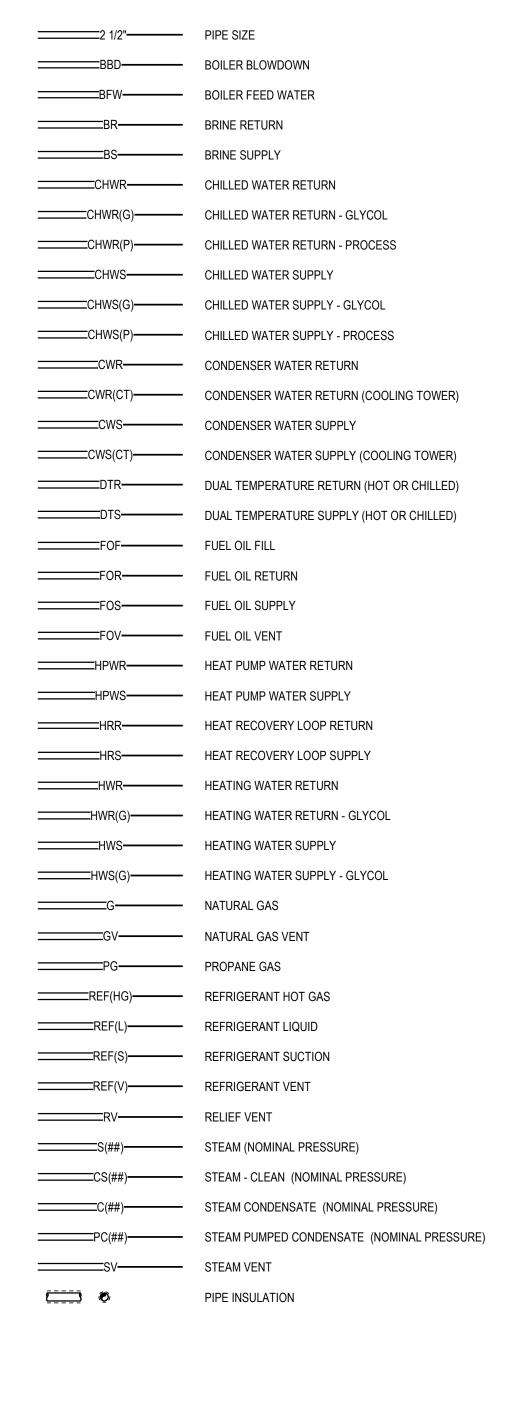
SYMBOLS AND ABBREVIATIONS

Project No. 144320228 Revision

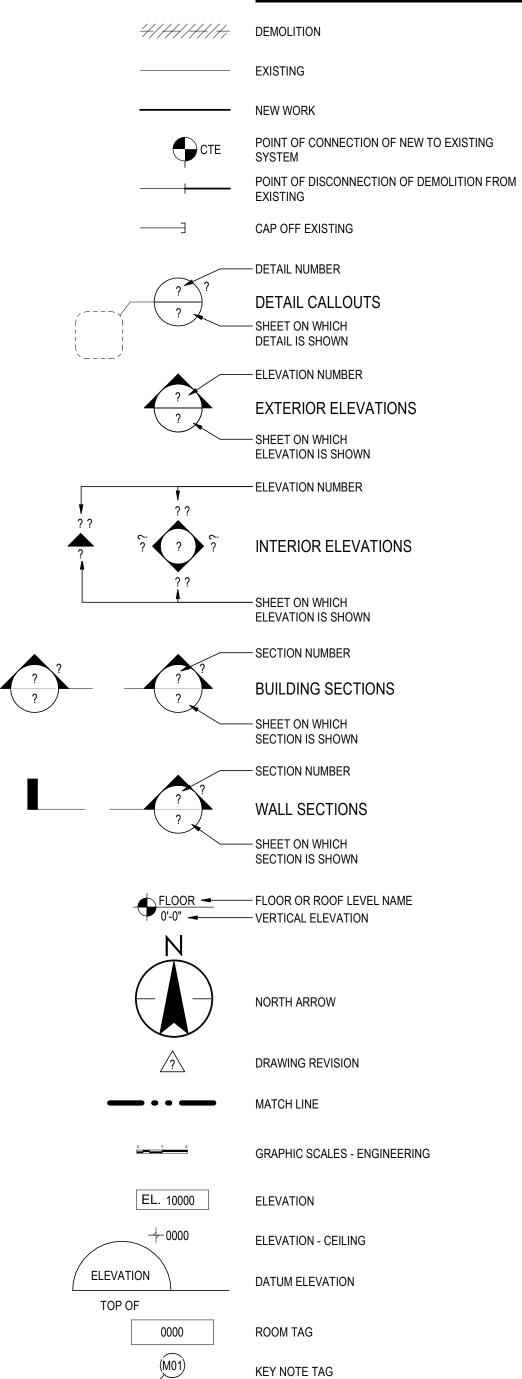
Drawing No. M001

Scale





#### **GENERAL SYMBOLS**



SLOPE ARROW

CENTER LINE

CIRCULAR BREAK SYMBOL

REFERENCE SYMBOL - HEXAGON (KEY NOTE)

CIRCLE BREAK SYMBOL

GRID BUBBLE AND LINE

#### **GENERAL NOTES**

1. INTENT OF THE DRAWINGS AND SPECIFICATIONS ARE TO PROVIDE DESIGN INTENT FOR COMPLETE PLUMBING, HEATING, CONTROL, VENTILATION AND AIR CONDITIONING SYSTEMS FOR THE PROPOSED PROJECT. THE DRAWINGS ARE DIAGRAMMATIC AND DO NOT SHOW THE EXACT LOCATION OF THE EXISTING OR THE NEW SYSTEMS. THE CONTRACTOR IS RESPONSIBLE TO COORDINATE ON SITE THE LOCATION OF THE NEW SYSTEM BASED ON THE EXISTING CONDITIONS. THE INSTALLATION OF THE SYSTEMS PROVIDED, IN THE DRAWINGS AND SPECIFICATION SHALL CONFORM TO THE DETAILS STATED IN THE SPECIFICATIONS AND SHOWN ON THE DRAWINGS. ITEMS OR WORK NOT SHOWN OR SPECIFIED, BUT REQUIRED FOR A COMPLETE HEATING, VENTILATION, AND AIR CONDITIONING SYSTEM, SHALL BE PROVIDED AND SHALL CONFORM WITH ACCEPTED TRADE PRACTICES, LOCAL CODES, AND GOVERNING AUTHORITIES.

2. THE DRAWINGS AND SPECIFICATIONS ARE PRESENTED TO DEFINE SPECIFIC SYSTEM REQUIREMENTS AND SERVE TO EXPAND ON THE PRIMARY CONTRACT REQUIREMENTS OF PROVIDING COMPLETE SYSTEMS. THE DRAWINGS ARE DIAGRAMMATIC AND INDICATE ONLY THE GENERAL ARRANGEMENT OF THE ITEMS COMPRISING THE SEVERAL SYSTEMS INCLUDED IN THE HEATING, VENTILATION AND AIR CONDITIONING WORK.

3. EXACT LOCATION OF SERVICES TO BE CONFIRMED ON SITE BY CONTRACTOR.

4. CONTRACTOR IS RESPONSIBLE FOR SCANNING STRUCTURAL SLABS FOR REINFORCING AT ALL PROPOSED CORE LOCATIONS, PRIOR TO CUTTING CONCRETE. ALL PENETRATION LOCATIONS SHALL BE ADJUSTED SO AS TO AVOID CUTTING ANY REINFORCING BARS. IF IT IS NECESSARY TO CUT A REINFORCING BAR, A STRUCTURAL ENGINEER SHALL BE RETAINED TO REVIEW AND APPROVE THE PROPOSED PENETRATION PRIOR TO CUTTING.

5. INDICATED DUCT AND PIPING RUNS ARE DIAGRAMMATIC. CONTRACTOR SHALL DETERMINE ALL REQUIRED OFFSETS AND DIRECTION CHANGES PRIOR TO FABRICATION AND INSTALLATION TO AVOID INTERFERENCE WITH OTHER TRADES.

6. THE MOST STRINGENT REQUIREMENTS OF THIS AND OTHER MECHANICAL SECTIONS SHALL GOVERN. SHOULD INCONSISTENCIES EXIST SUCH AS DRAWING/SPECIFICATION CONFLICTS, DRAWINGS DISAGREEING WITHIN THEMSELVES OR SPECIFICATIONS DISAGREEING WITHIN THEMSELVES, THE BETTER QUALITY AND/OR GREATER QUANTITY OF WORK OR MATERIALS SHALL BE ESTIMATED UPON, PERFORMED AND FURNISHED UNLESS OTHERWISE ORDERED BY THE CONSULTANT IN WRITING DURING THE BIDDING PERIOD.

7. ALL CONTRACTORS, INCLUDING GENERAL CONTRACTOR AND SUB-CONTRACTORS, ARE RESPONSIBLE FOR REVIEWING AND COORDINATING WITH A COMPLETE SET OF DRAWING AND SPECIFICATION PACKAGES FOR ARCHITECTURAL, MECHANICAL. STRUCTURAL, AND ELECTRICAL TRADES INCLUDING ANY EQUIPMENT THAT FORM PART OF THE PROJECT SCOPE.

8. REFER TO AND COMPLY WITH GENERAL NOTES ON ARCHITECTURAL DRAWINGS. 9. BALANCING DAMPERS ARE REQUIRED AT ALL DUCTWORK BRANCH CONNECTIONS DOWNSTREAM OF SUPPLY VAV BOXES AND UPSTREAM OF EXHAUST AIR VALVES. BALANCING DAMPERS SHOWN INDICATE PREFERRED LOCATIONS ONLY. BALANCING DAMPERS MAY BE WITHIN THE DIFFUSER/GRILLE - REFER TO SPEC.

10. ALL SERVICES TO BE INSTALLED TO PERMIT MAXIMUM CEILING HEIGHTS.

11. MECHANICAL TRADE TO ALLOW FOR MAKING FINAL CONNECTIONS TO OWNER SUPPLIED EQUIPMENT. 12. CAREFULLY EXAMINE THE DRAWINGS FOR INTERCONNECTIONS WITH EXISTING SERVICES. ASSUME ALL TIE INS TO EXISTING

SERVICES, AND ASSOCIATED SHUTDOWNS ARE TO OCCUR AFTER HOURS / WEEKENDS. COORDINATE WITH OWNER. 13. MECHANICAL TRADE TO ALLOW FOR MAKING FINAL CONNECTIONS TO OWNER SUPPLIED EQUIPMENT.

14. ALL CLEAN ROOM PENETRATIONS TO BE AIR TIGHT / SEALED TO REDUCE AIR LEAKAGE. 15. ALL DEVICES, DIFFUSERS, SENSORS, SPRINKLERS ETC. ARE TO BE PROVIDED WITH GASKETS TO REDUCE AIR LOSS.

	MECHANICAL SHEET LIST
Sheet Number	Sheet Name
M001	SYMBOLS AND ABBREVIATIONS
M002	SYMBOLS, ABBREVIATIONS KEY PLAN, AND GENERAL NOTES
M100	LEVEL 0 - HVAC ENVIRONMENTAL CONTROLS
M101	LEVEL 0 - HVAC - DEMO
M102	LEVEL 0 - HVAC - OVERVIEW
M103	LEVEL 0 - HVAC - NEW
M104	LEVEL 0 - HYDRONIC - NEW
M105	LEVEL 1 - HVAC - NEW
M106	LEVEL 2, LEVEL 3, & UPPER ROOF - HVAC - NEW
M200	LEVEL 0 - PLUMBING OVERVIEW
M201	LEVEL 0 - SANITARY PLUMBING - DEMO & NEW
M202	LEVEL 0 - PLUMBING - DEMO & NEW
M300	LEVEL 0 - FIRE PROTECTION PLAN
M400	MECHANICAL DETAILS
M401	MECHANICAL DETAILS
M402	MECHANICAL SCHEMATICS
M403	MECHANICAL SCHEMATICS
M500	MECHANICAL SCHEDULES
M501	MECHANICAL SCHEDULES



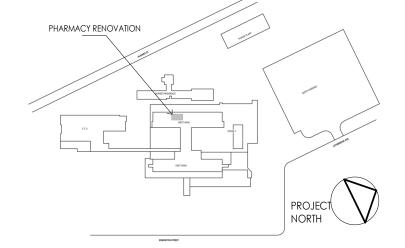
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Notes



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SYMBOLS, ABBREVIATIONS KEY PLAN, AND GENERAL NOTES

Scale

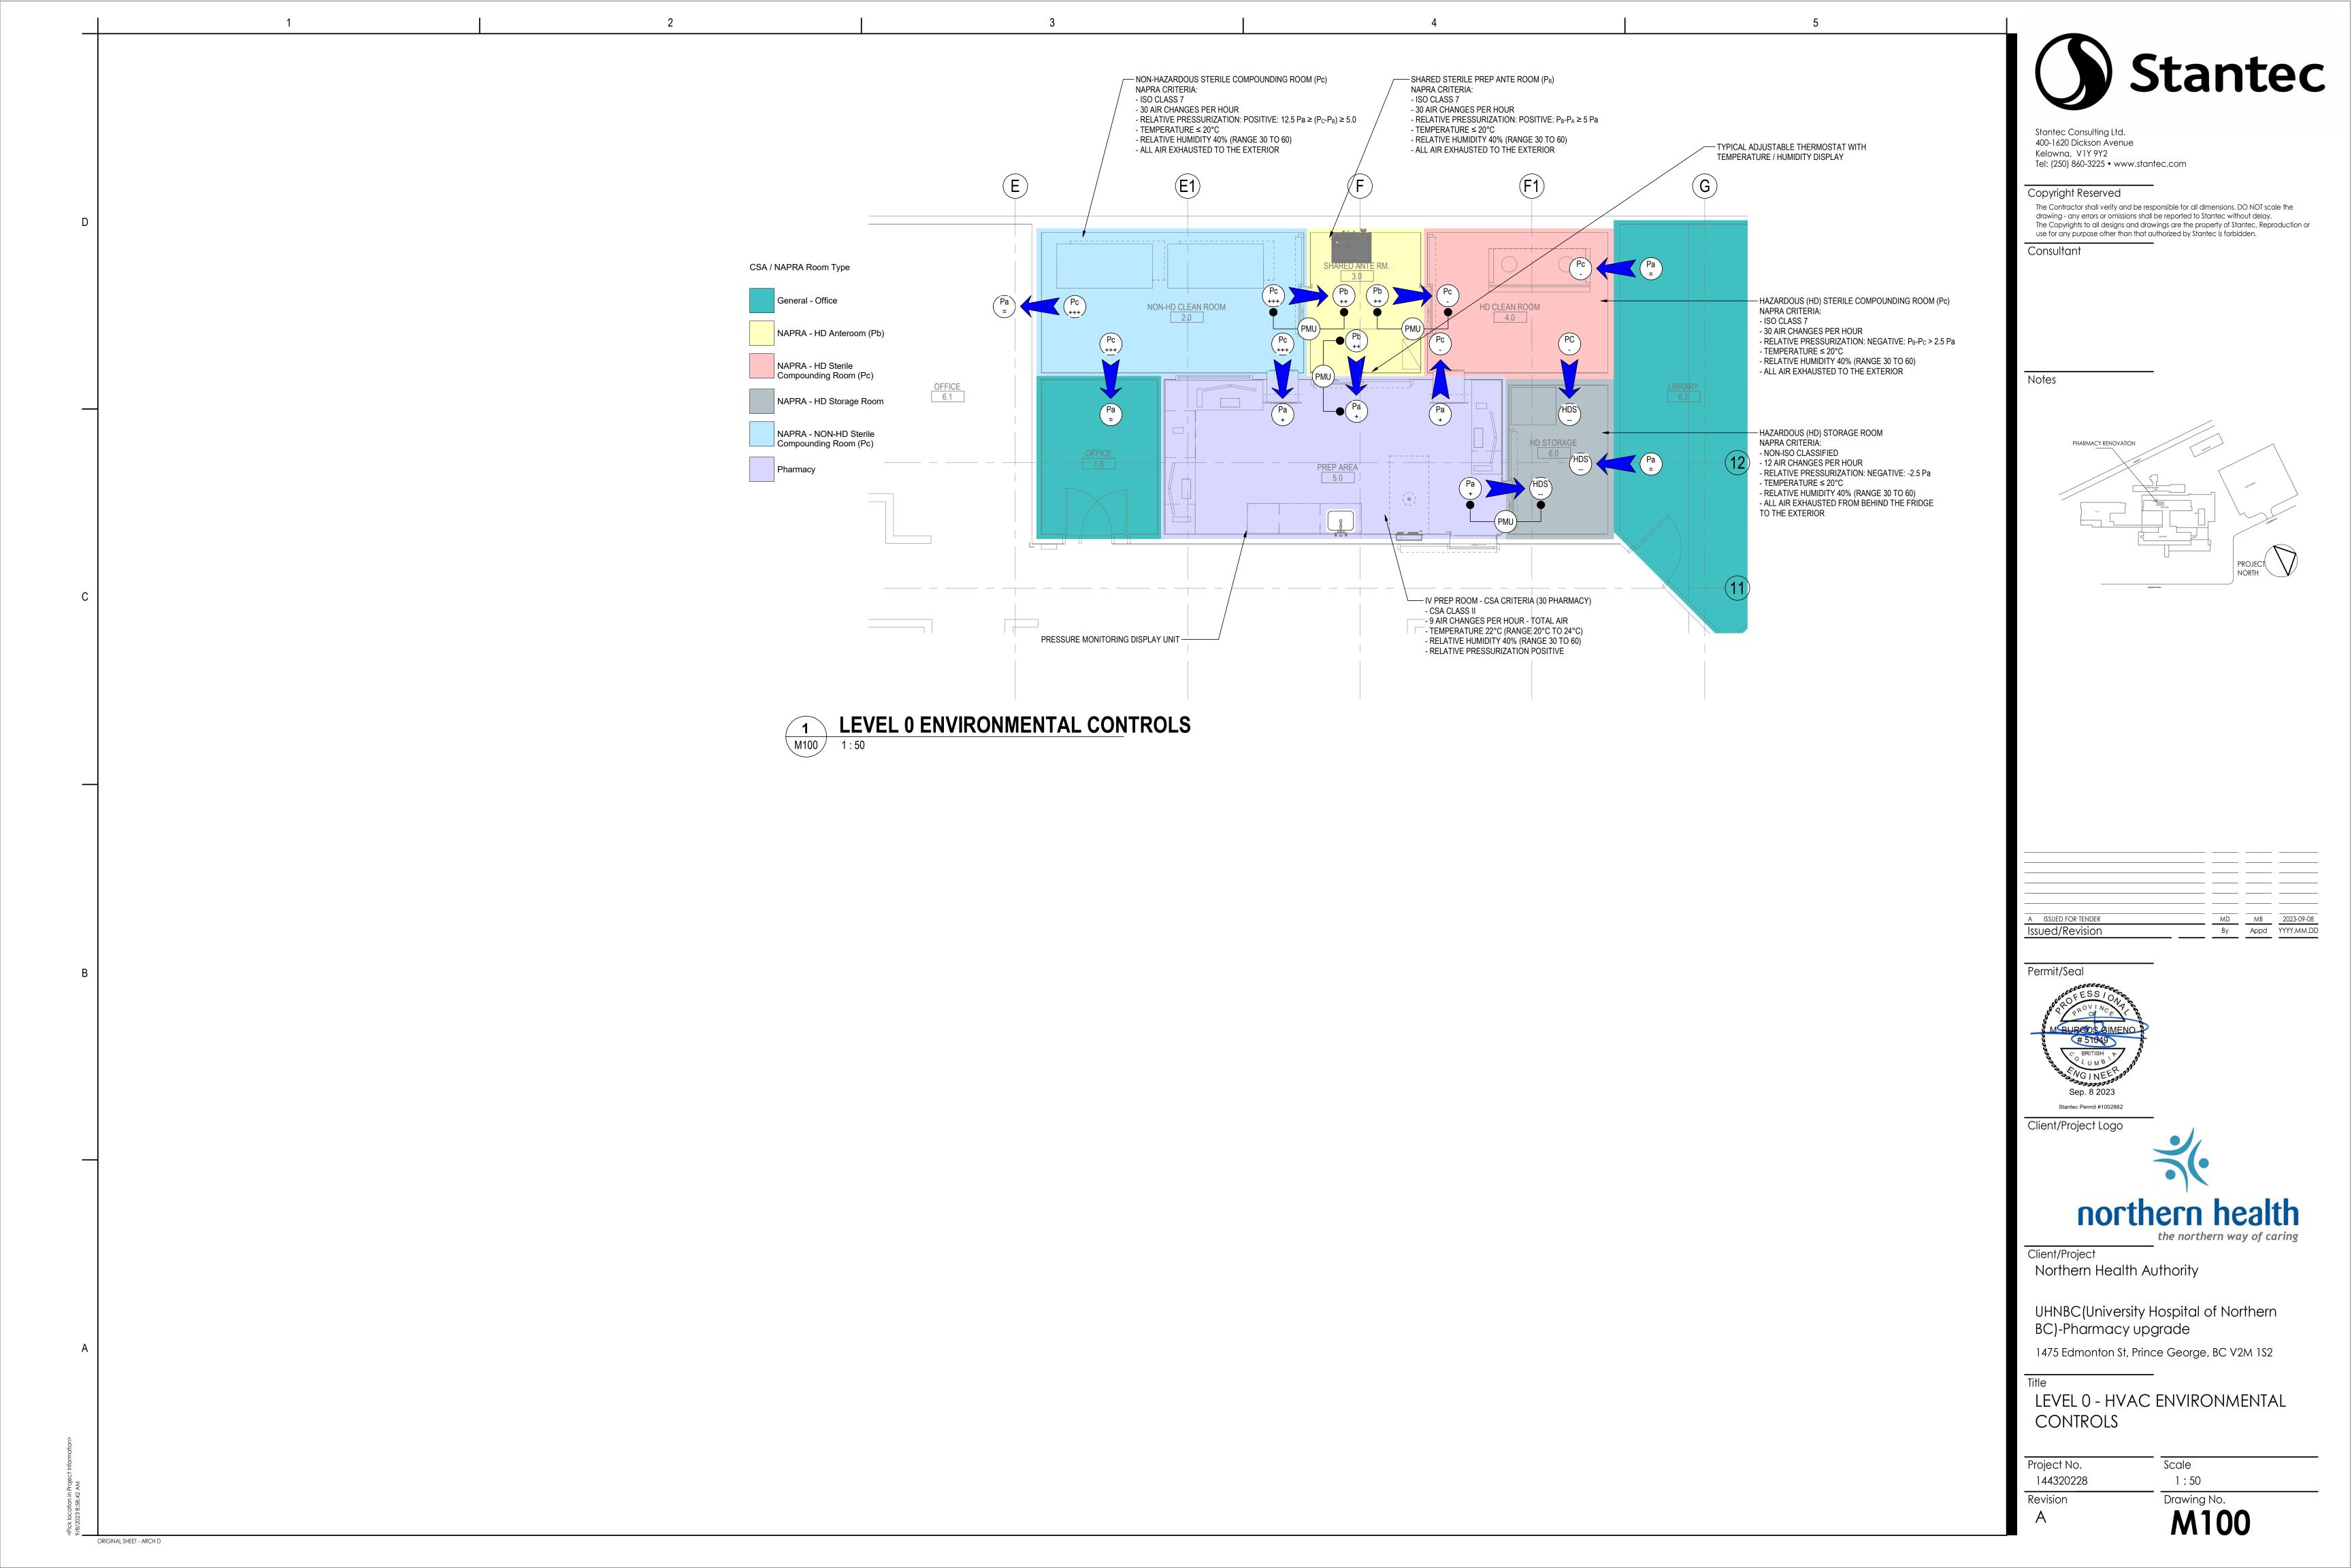
Project No. 144320228

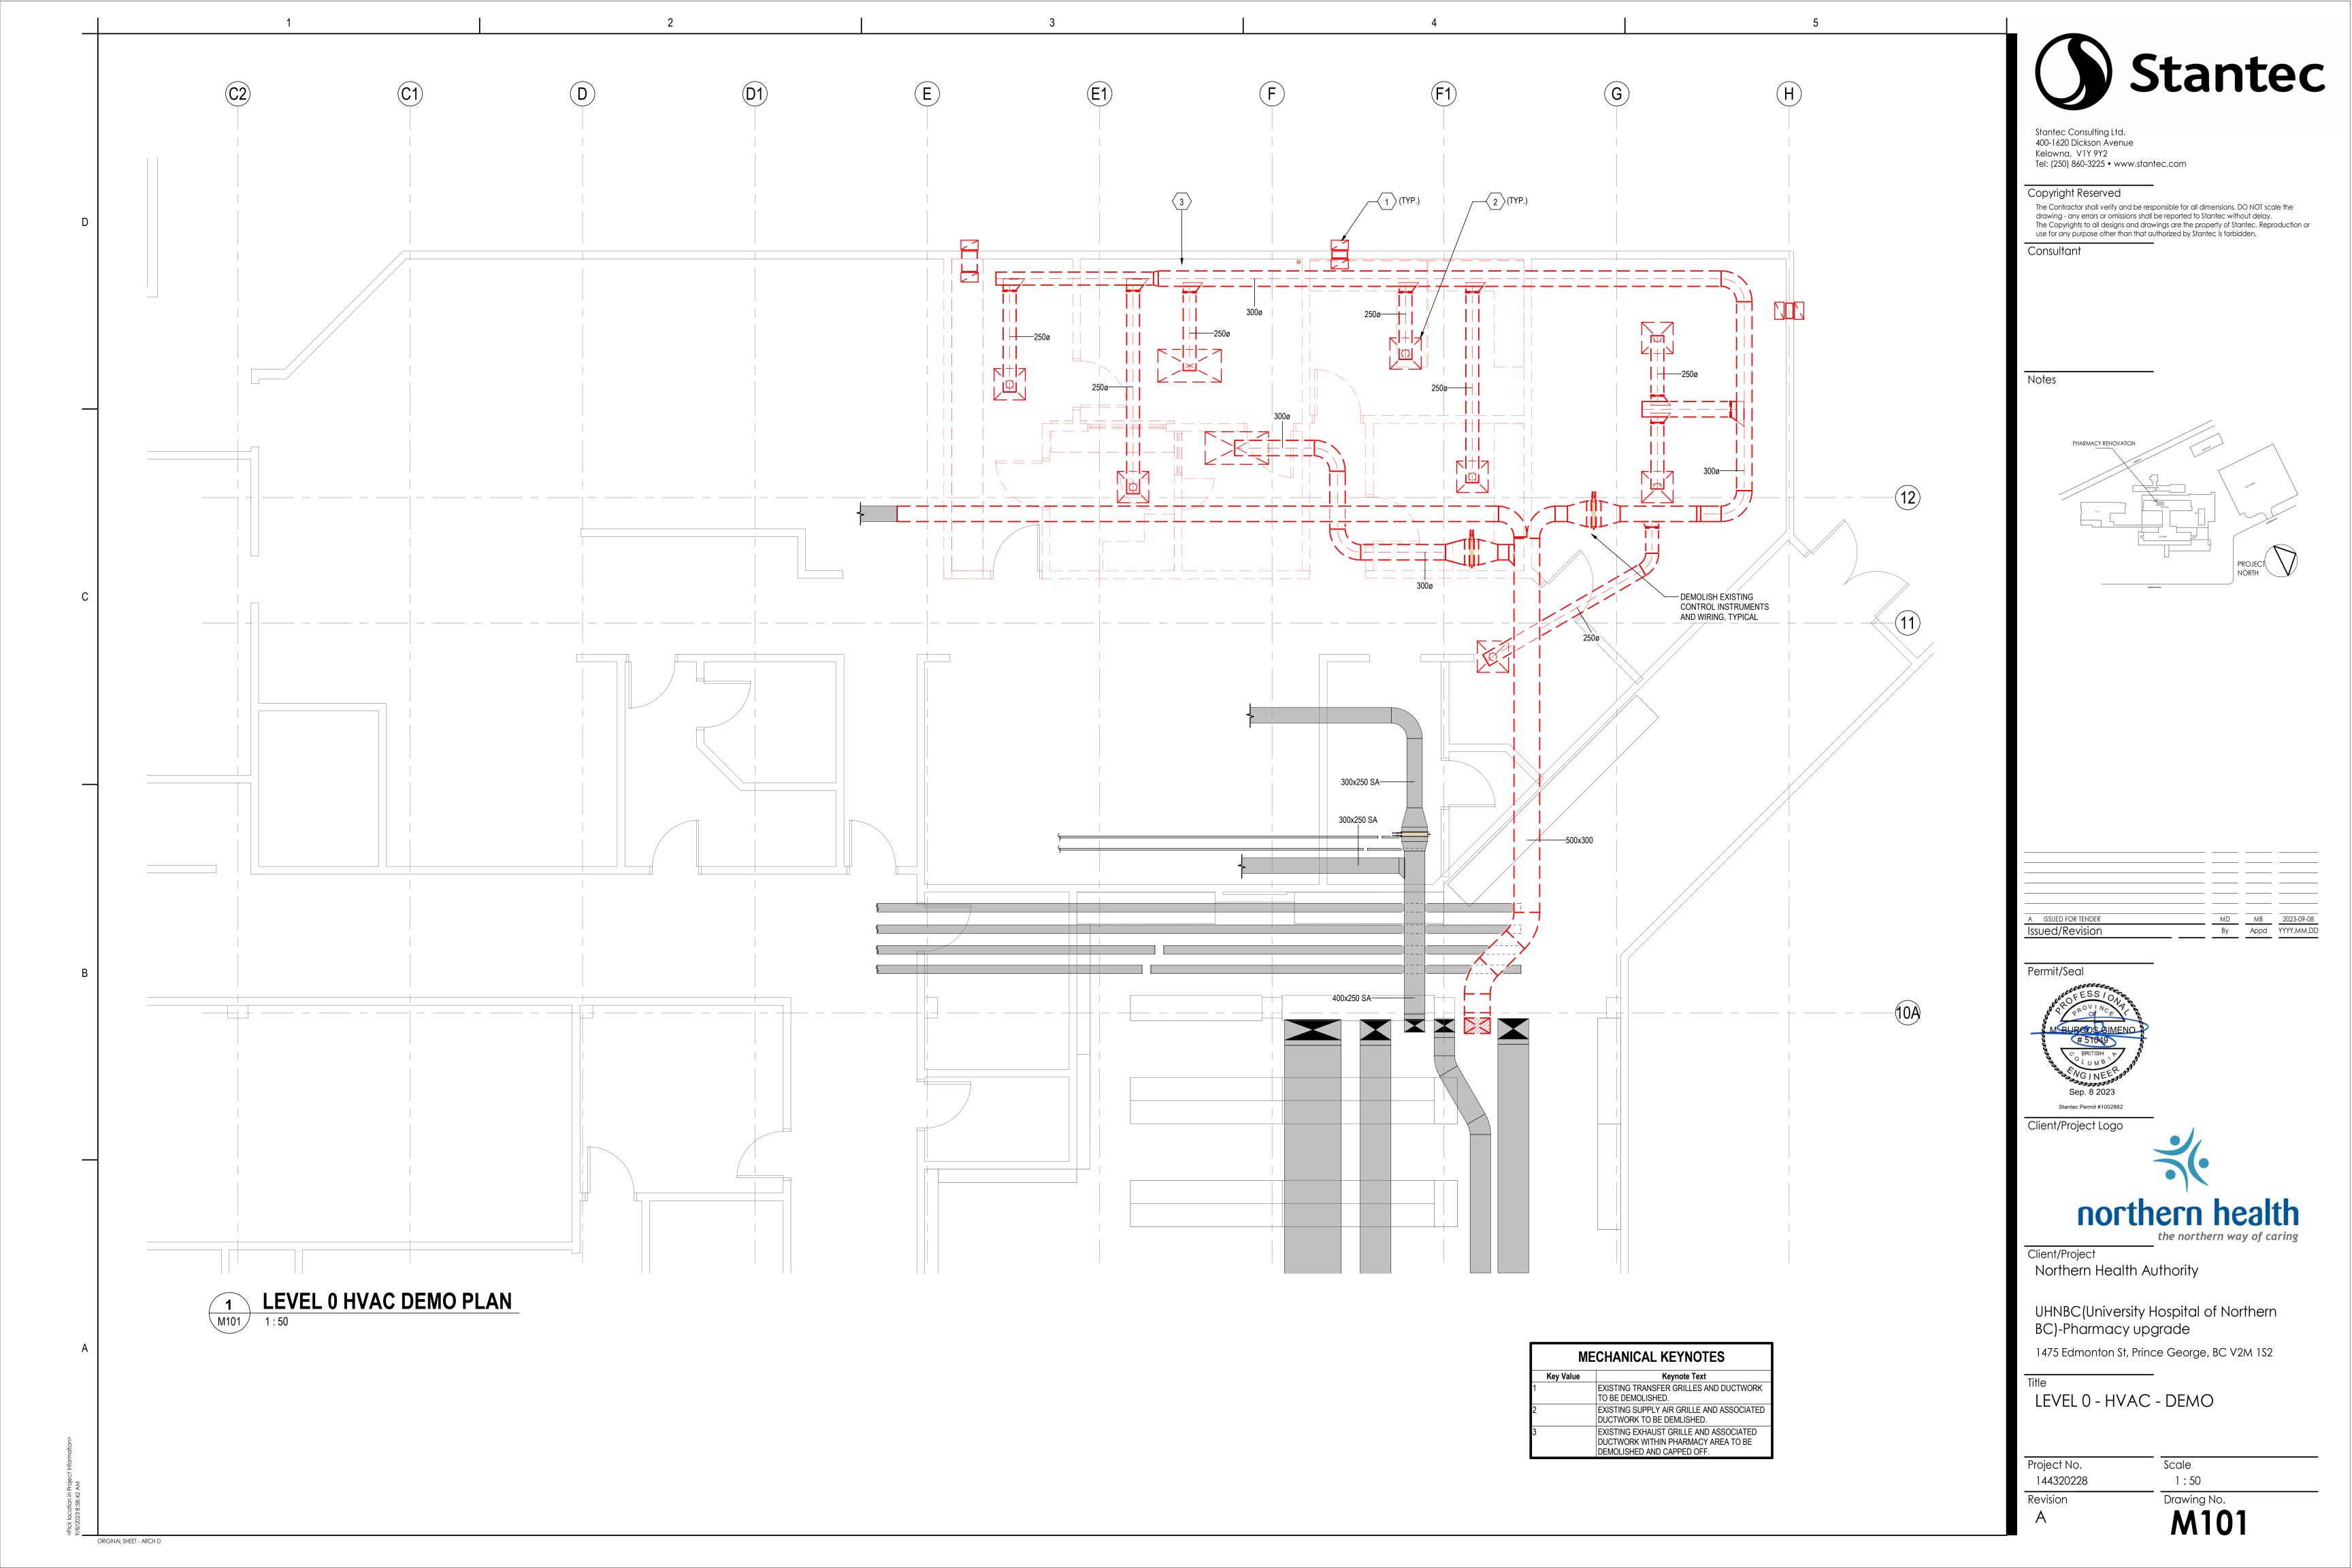
Drawing No.

ORIGINAL SHEET - ARCH D

Revision

M002

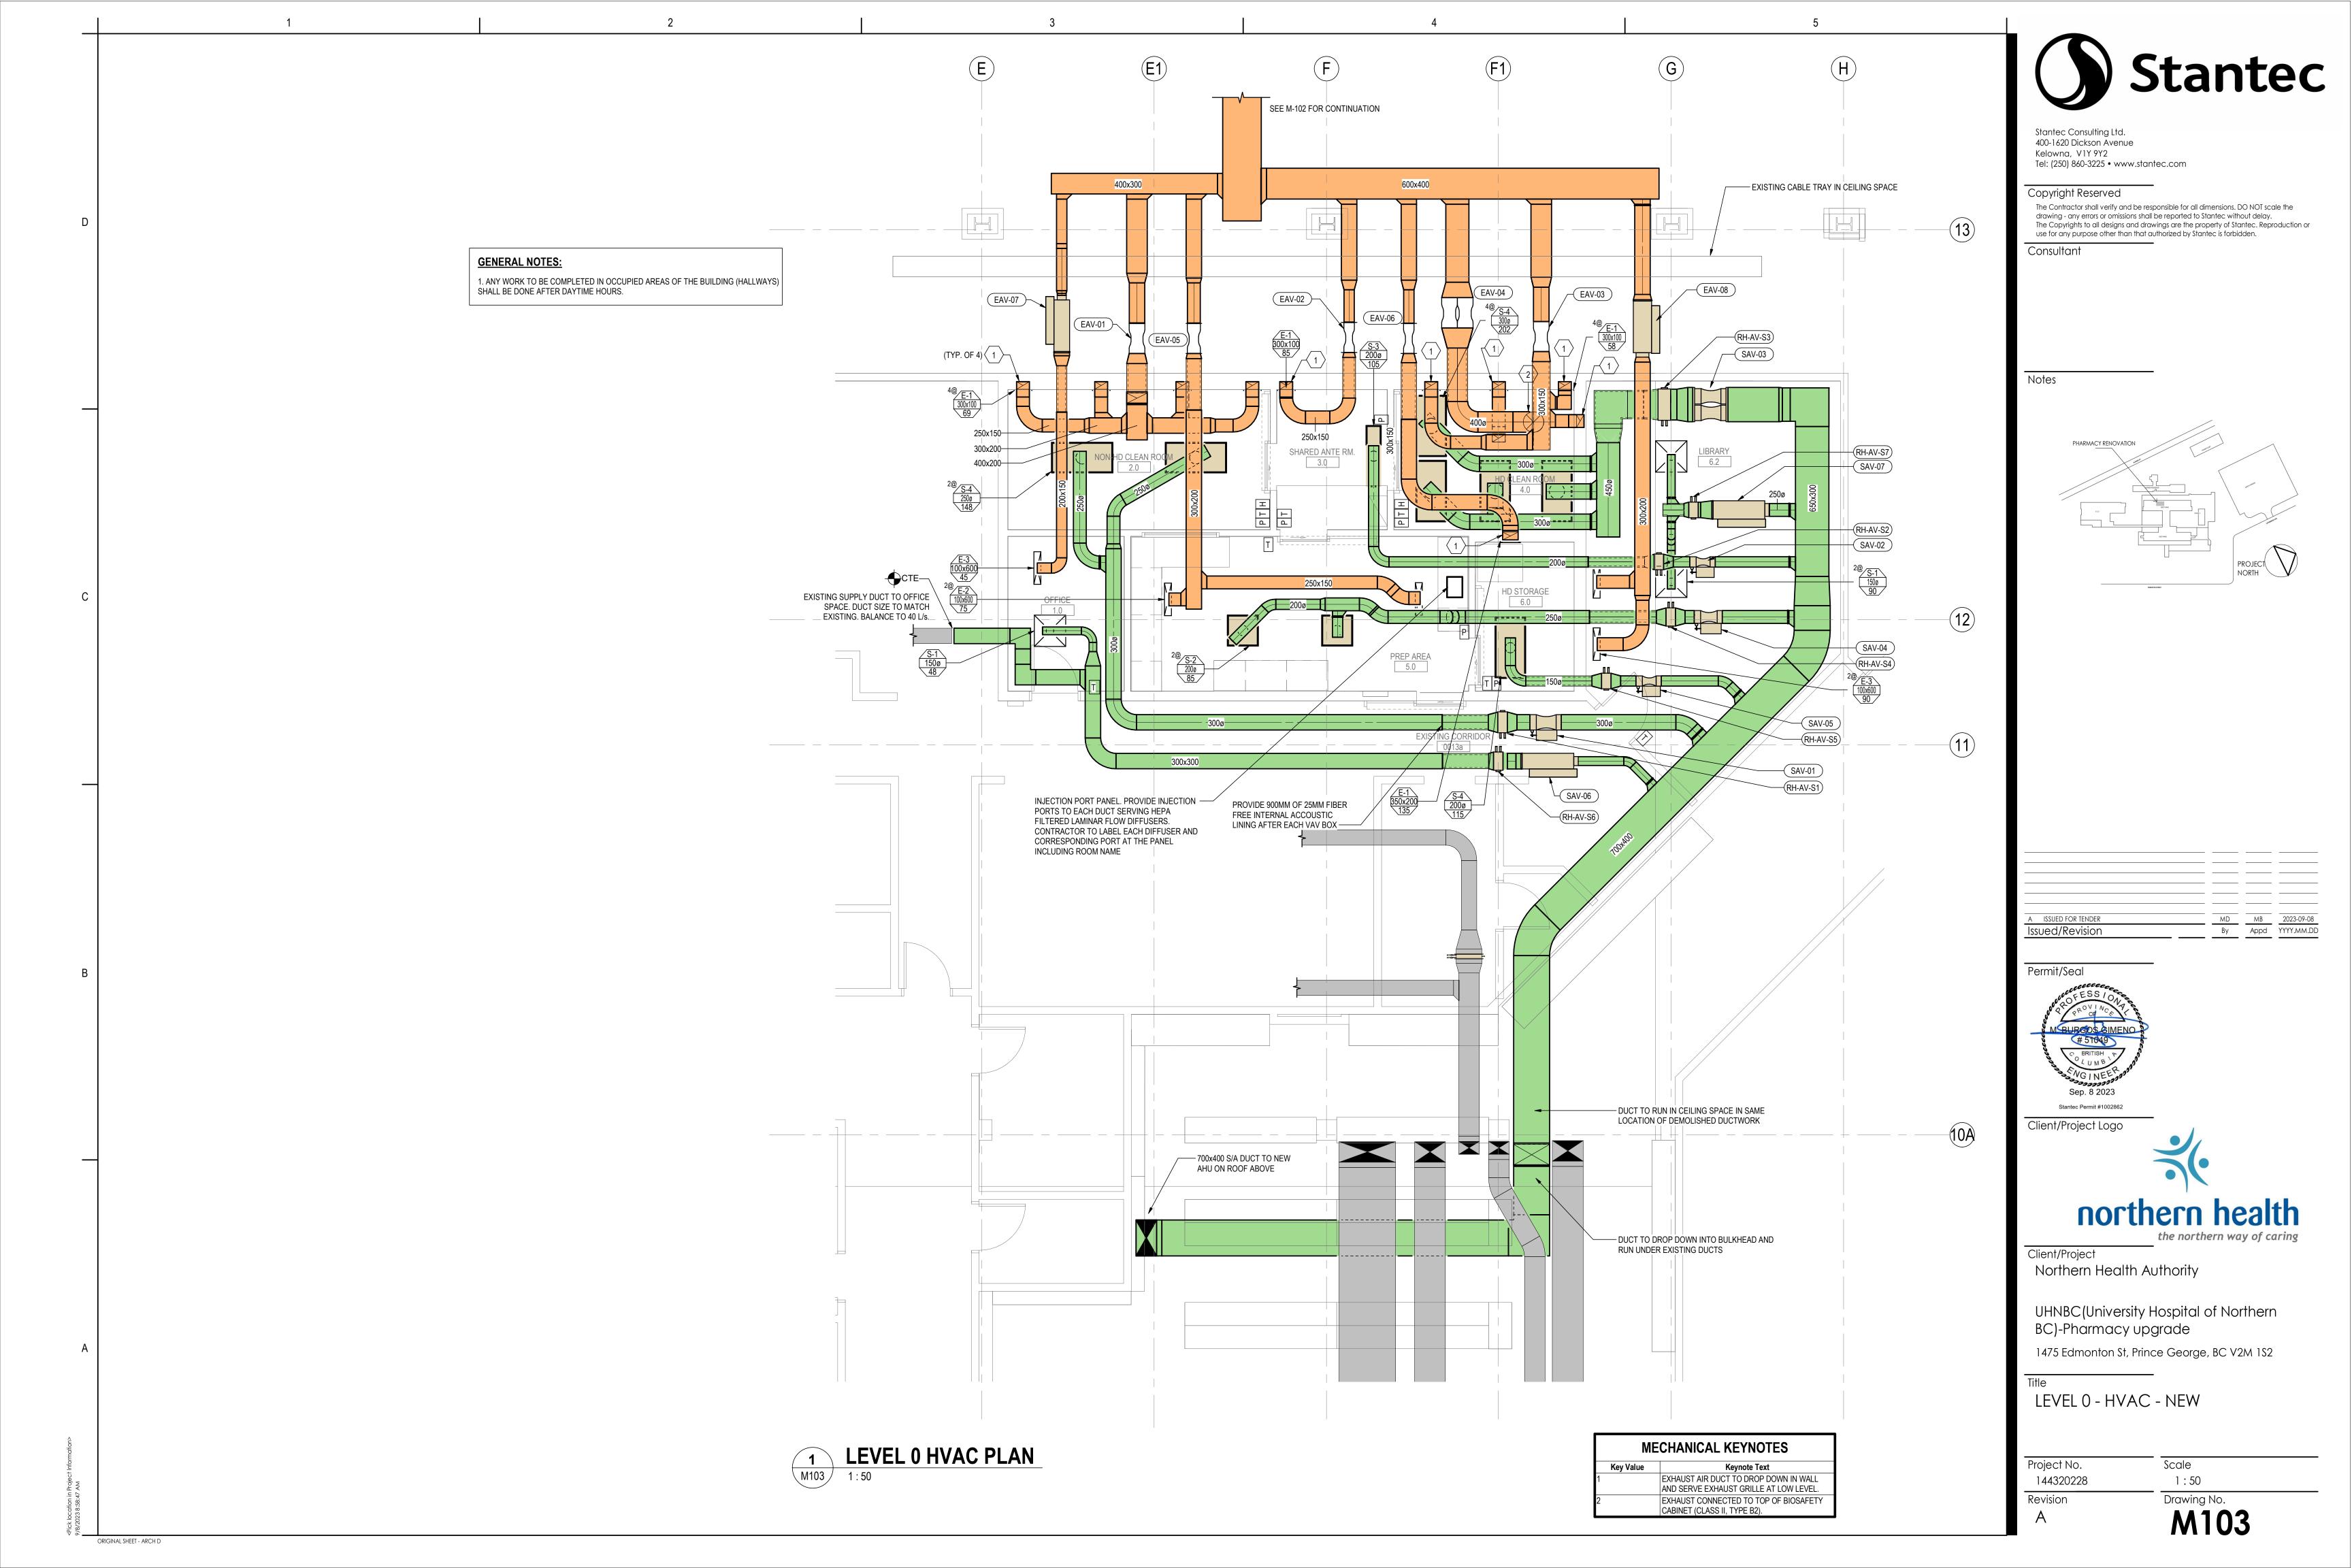


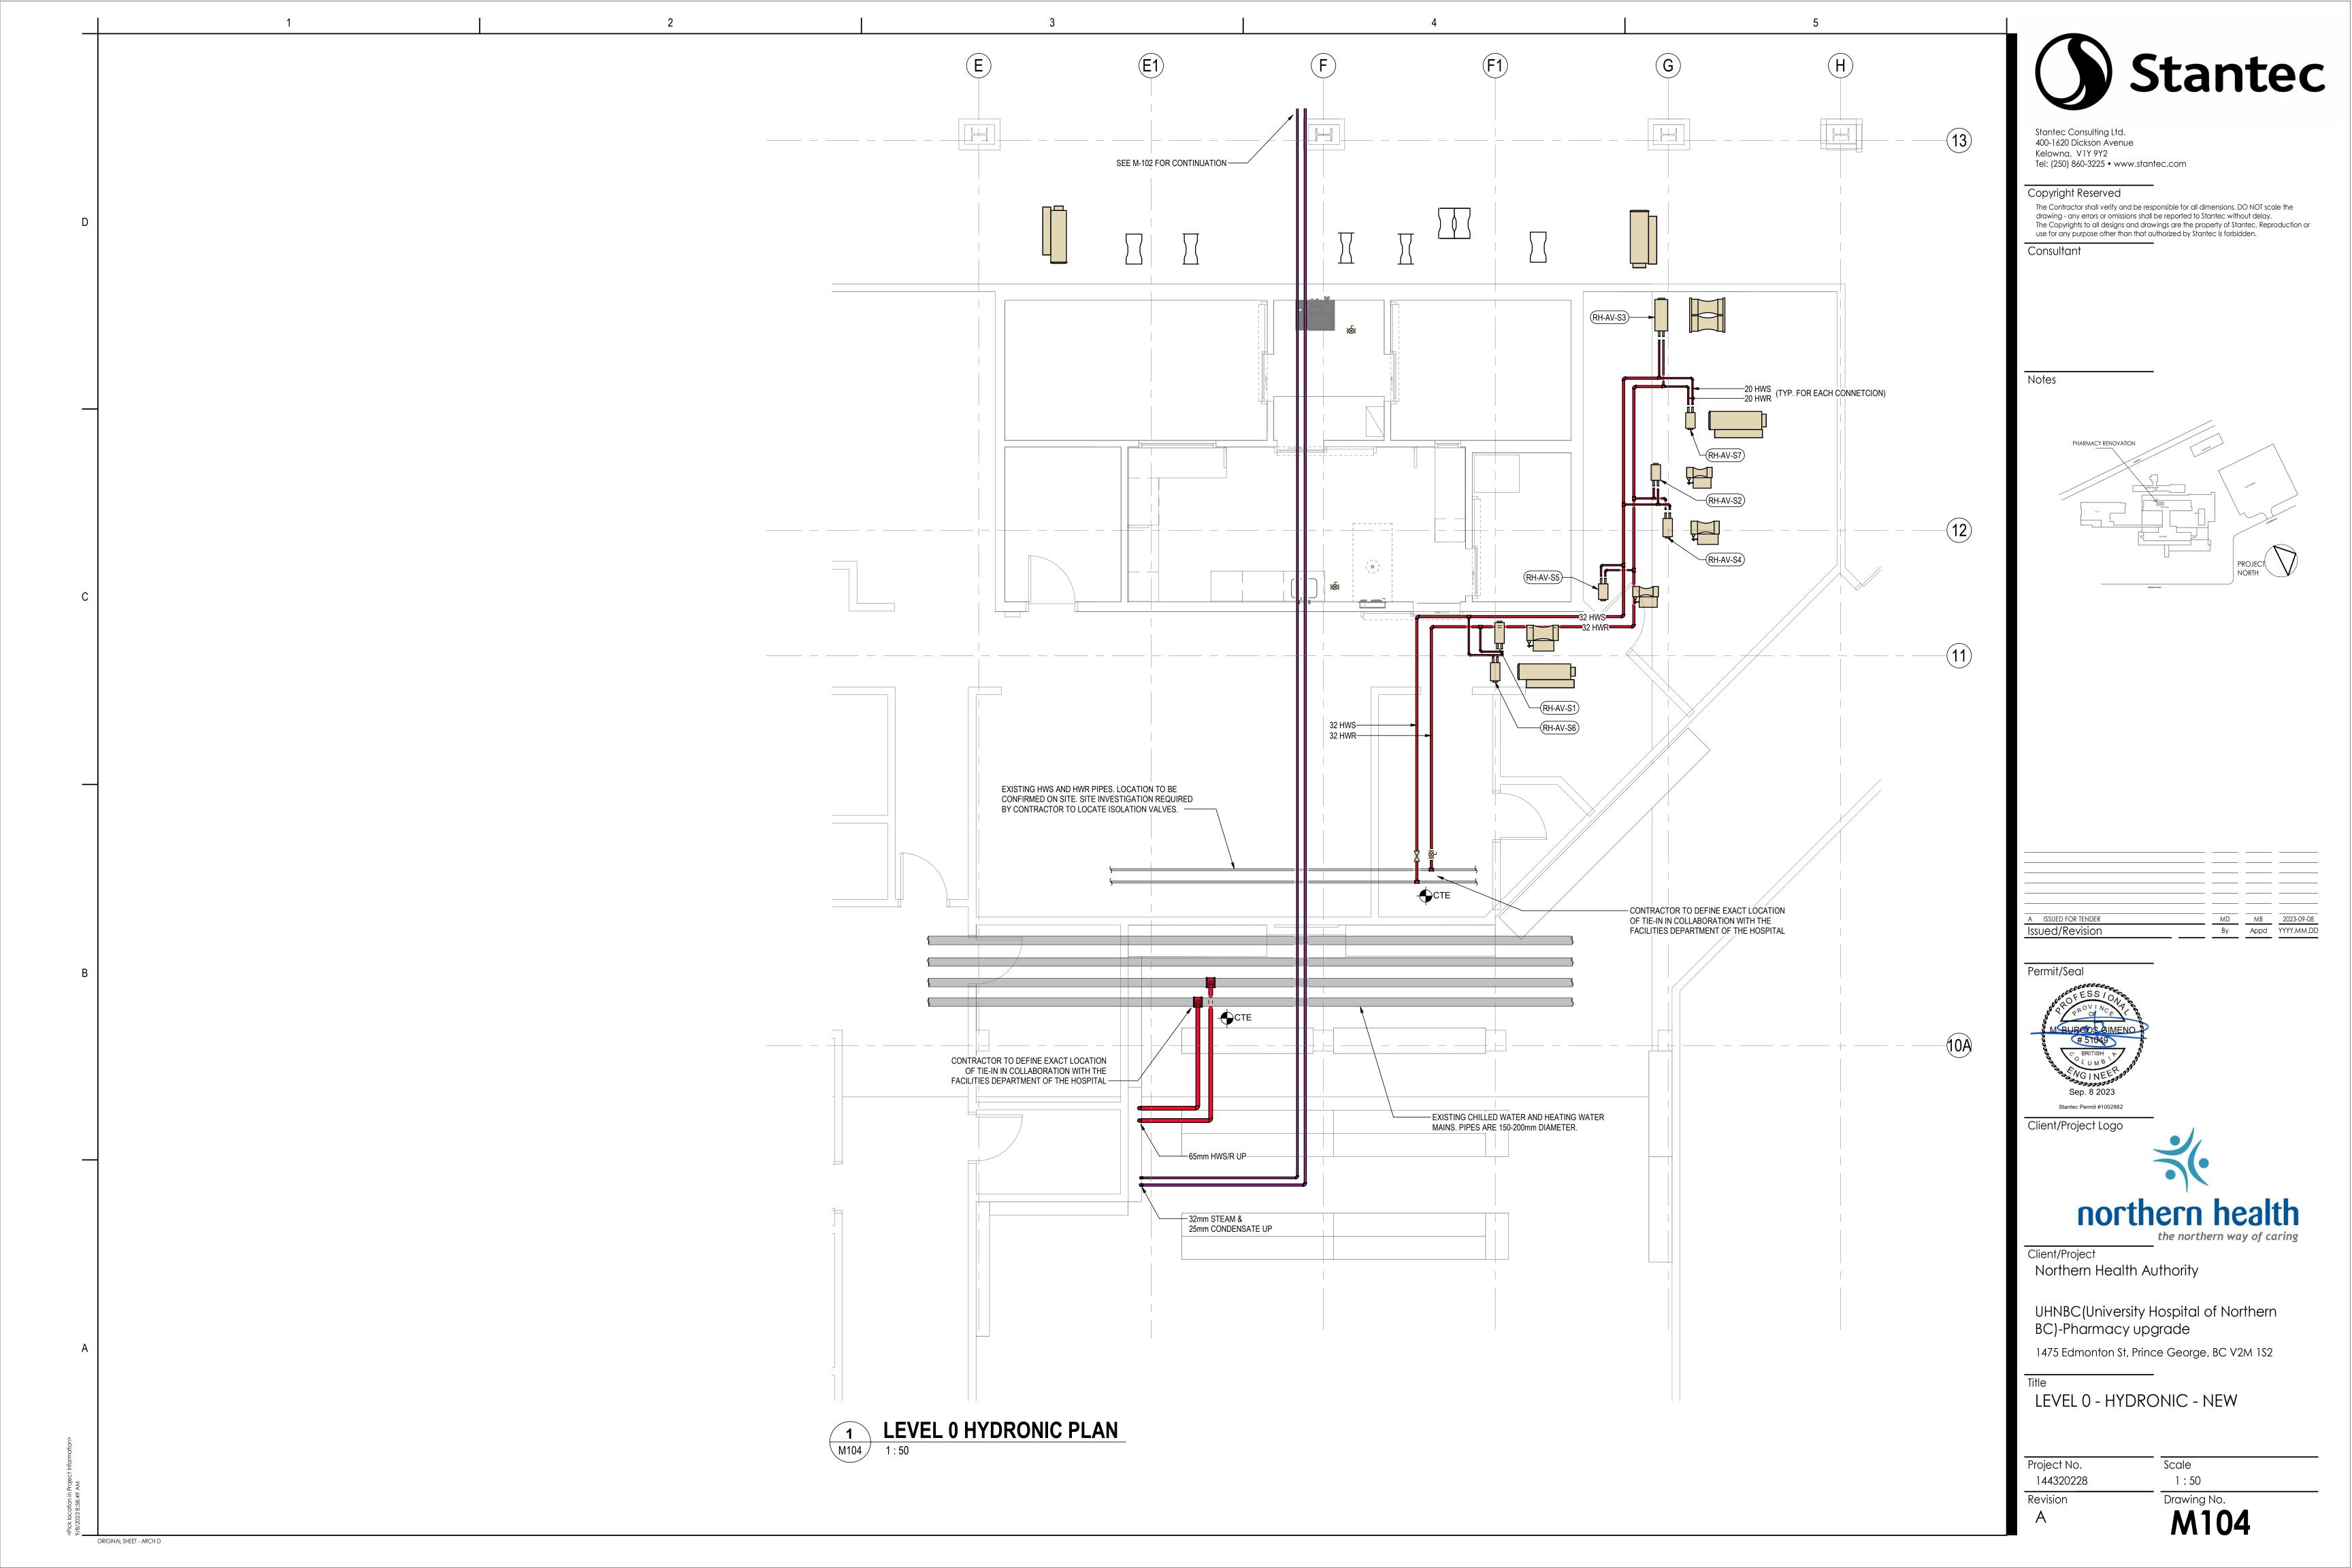


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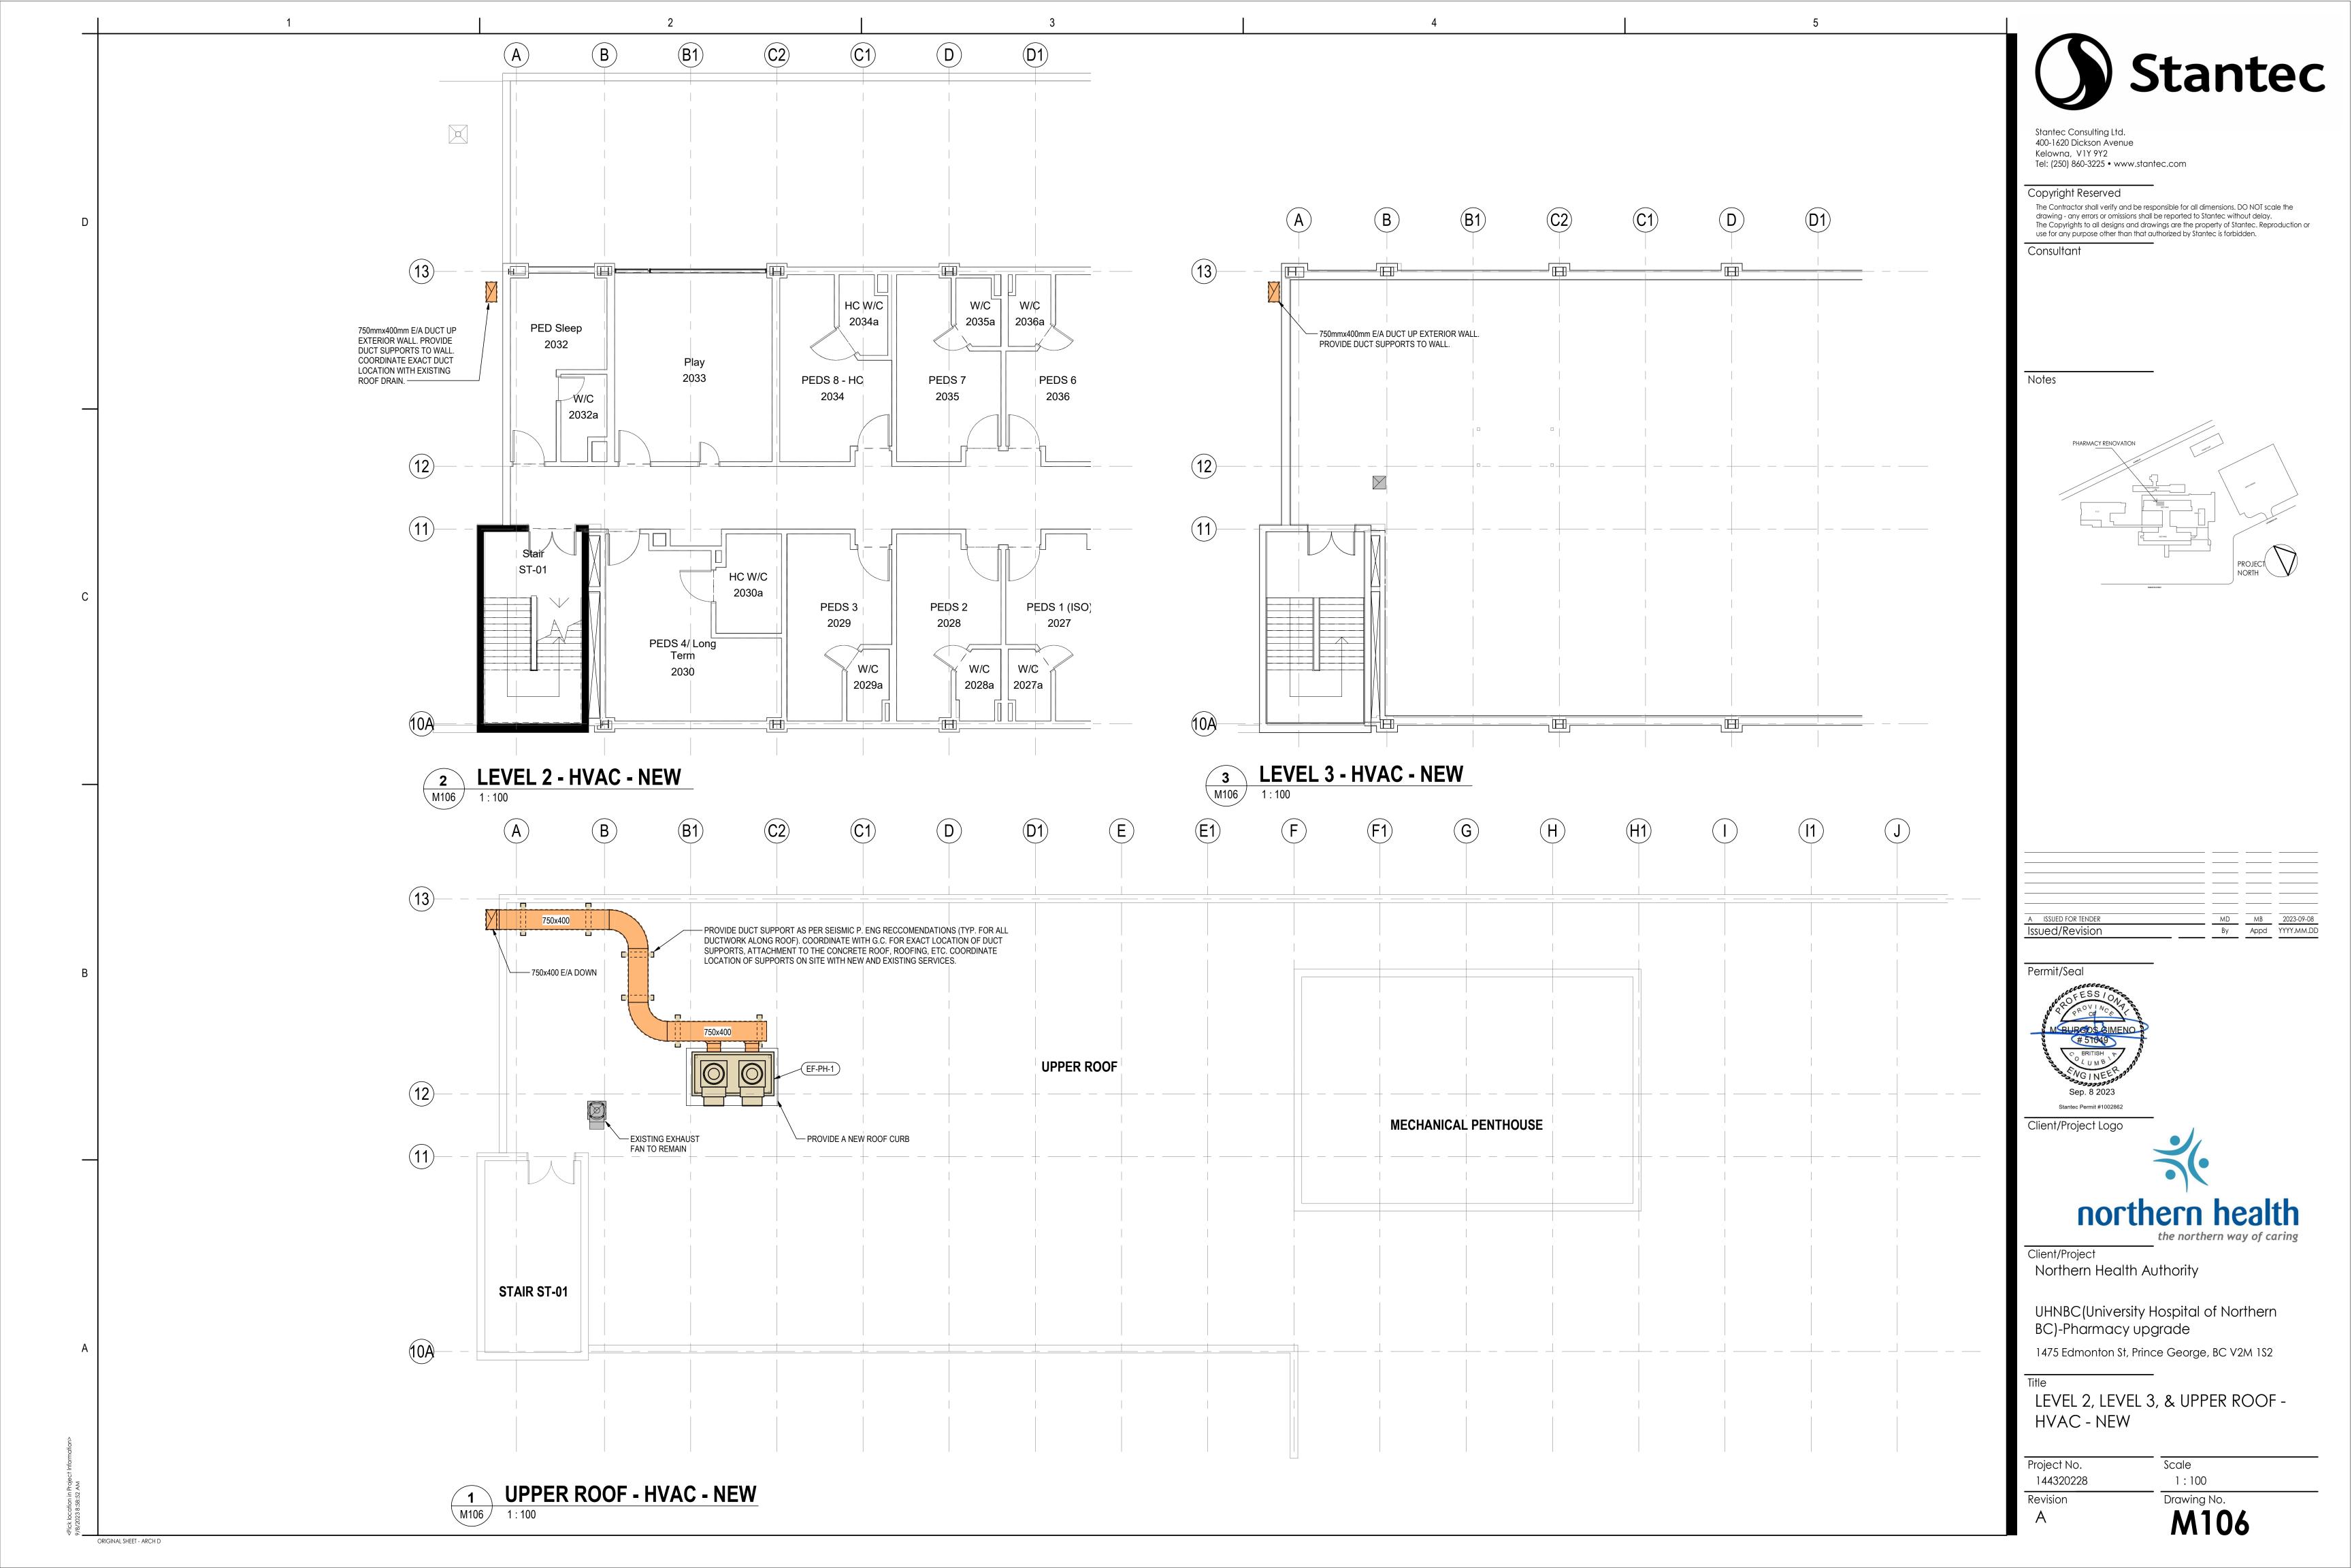
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CONTRACTOR TO DEFINE EXACT LOCATION
IN COLLABORATION WITH THE FACILITIES THROUGH ROOF DEPARTMENT OF THE HOSPITAL. M103 
 MD
 MB
 2023-09-08

 By
 Appd
 YYYY.MM.DD
 A ISSUED FOR TENDER Issued/Revision Permit/Seal LEVEL 0 HVAC OVERVIEW PLAN M102 Stantec Permit #1002862 Client/Project Logo northern health Client/Project Northern Health Authority UHNBC(University Hospital of Northern BC)-Pharmacy upgrade 1475 Edmonton St, Prince George, BC V2M 1S2 LEVEL 0 - HVAC - OVERVIEW Scale Project No. 144320228 1:100 Drawing No. M102 Revision ORIGINAL SHEET - ARCH D







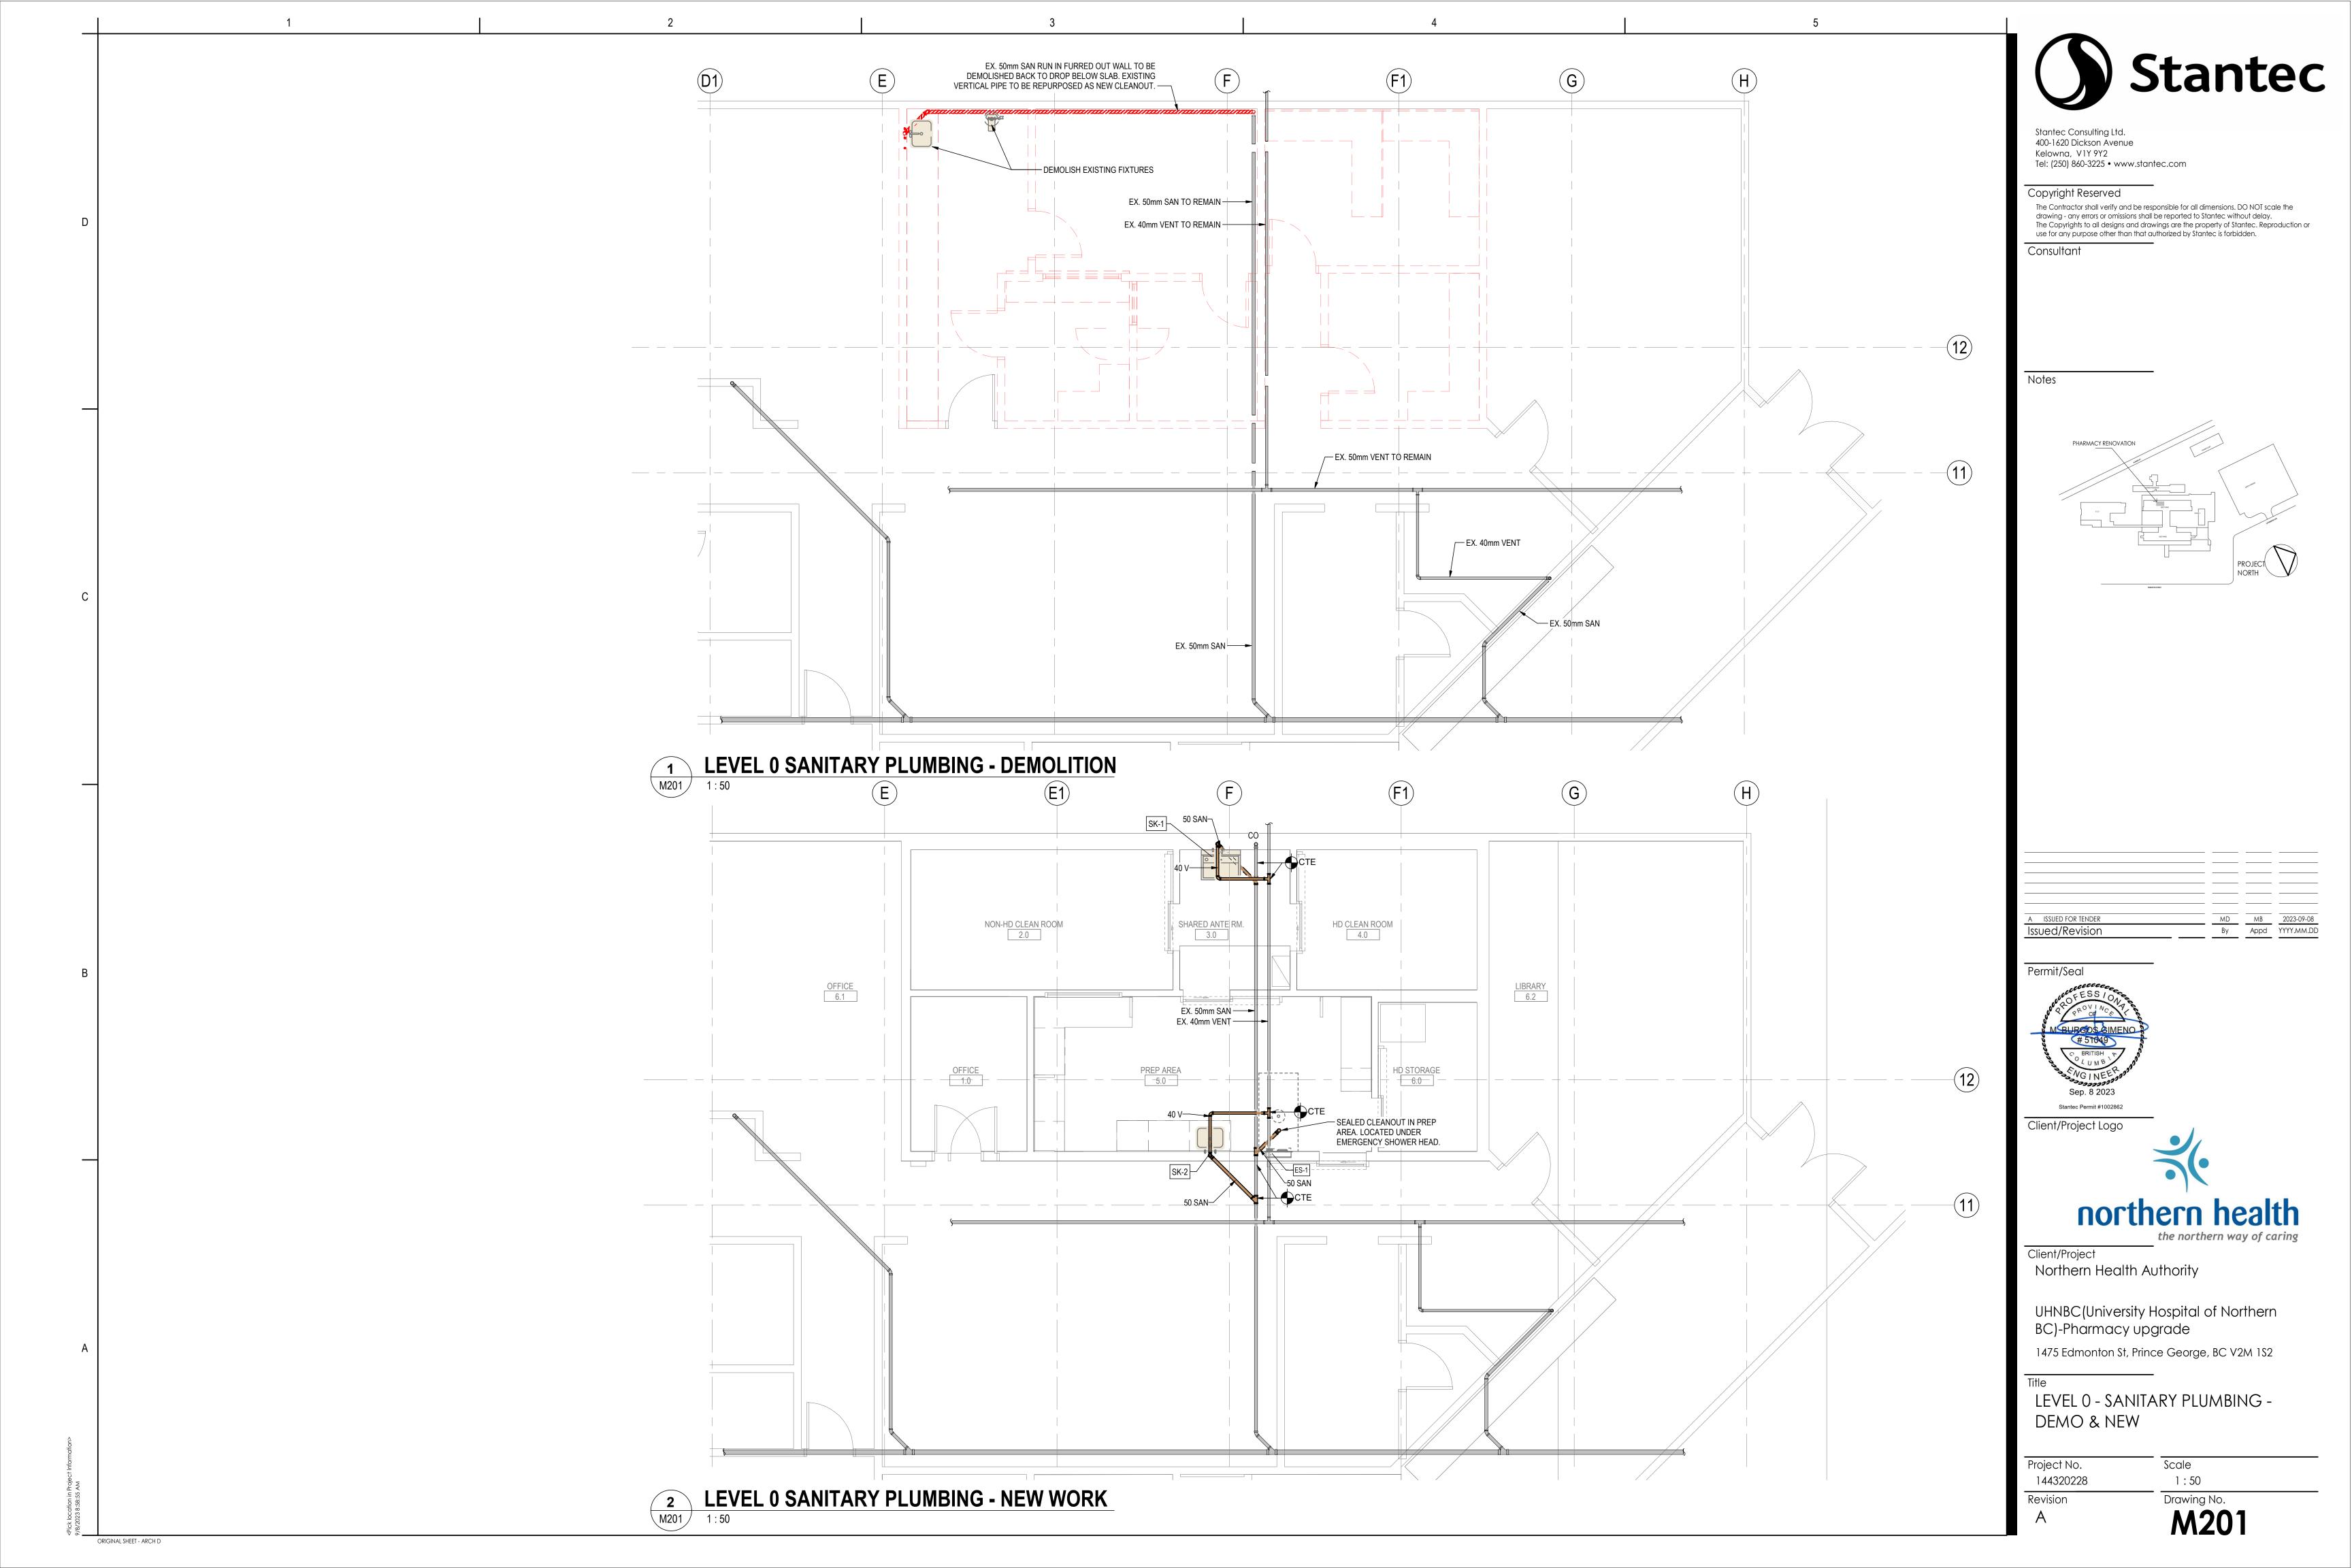


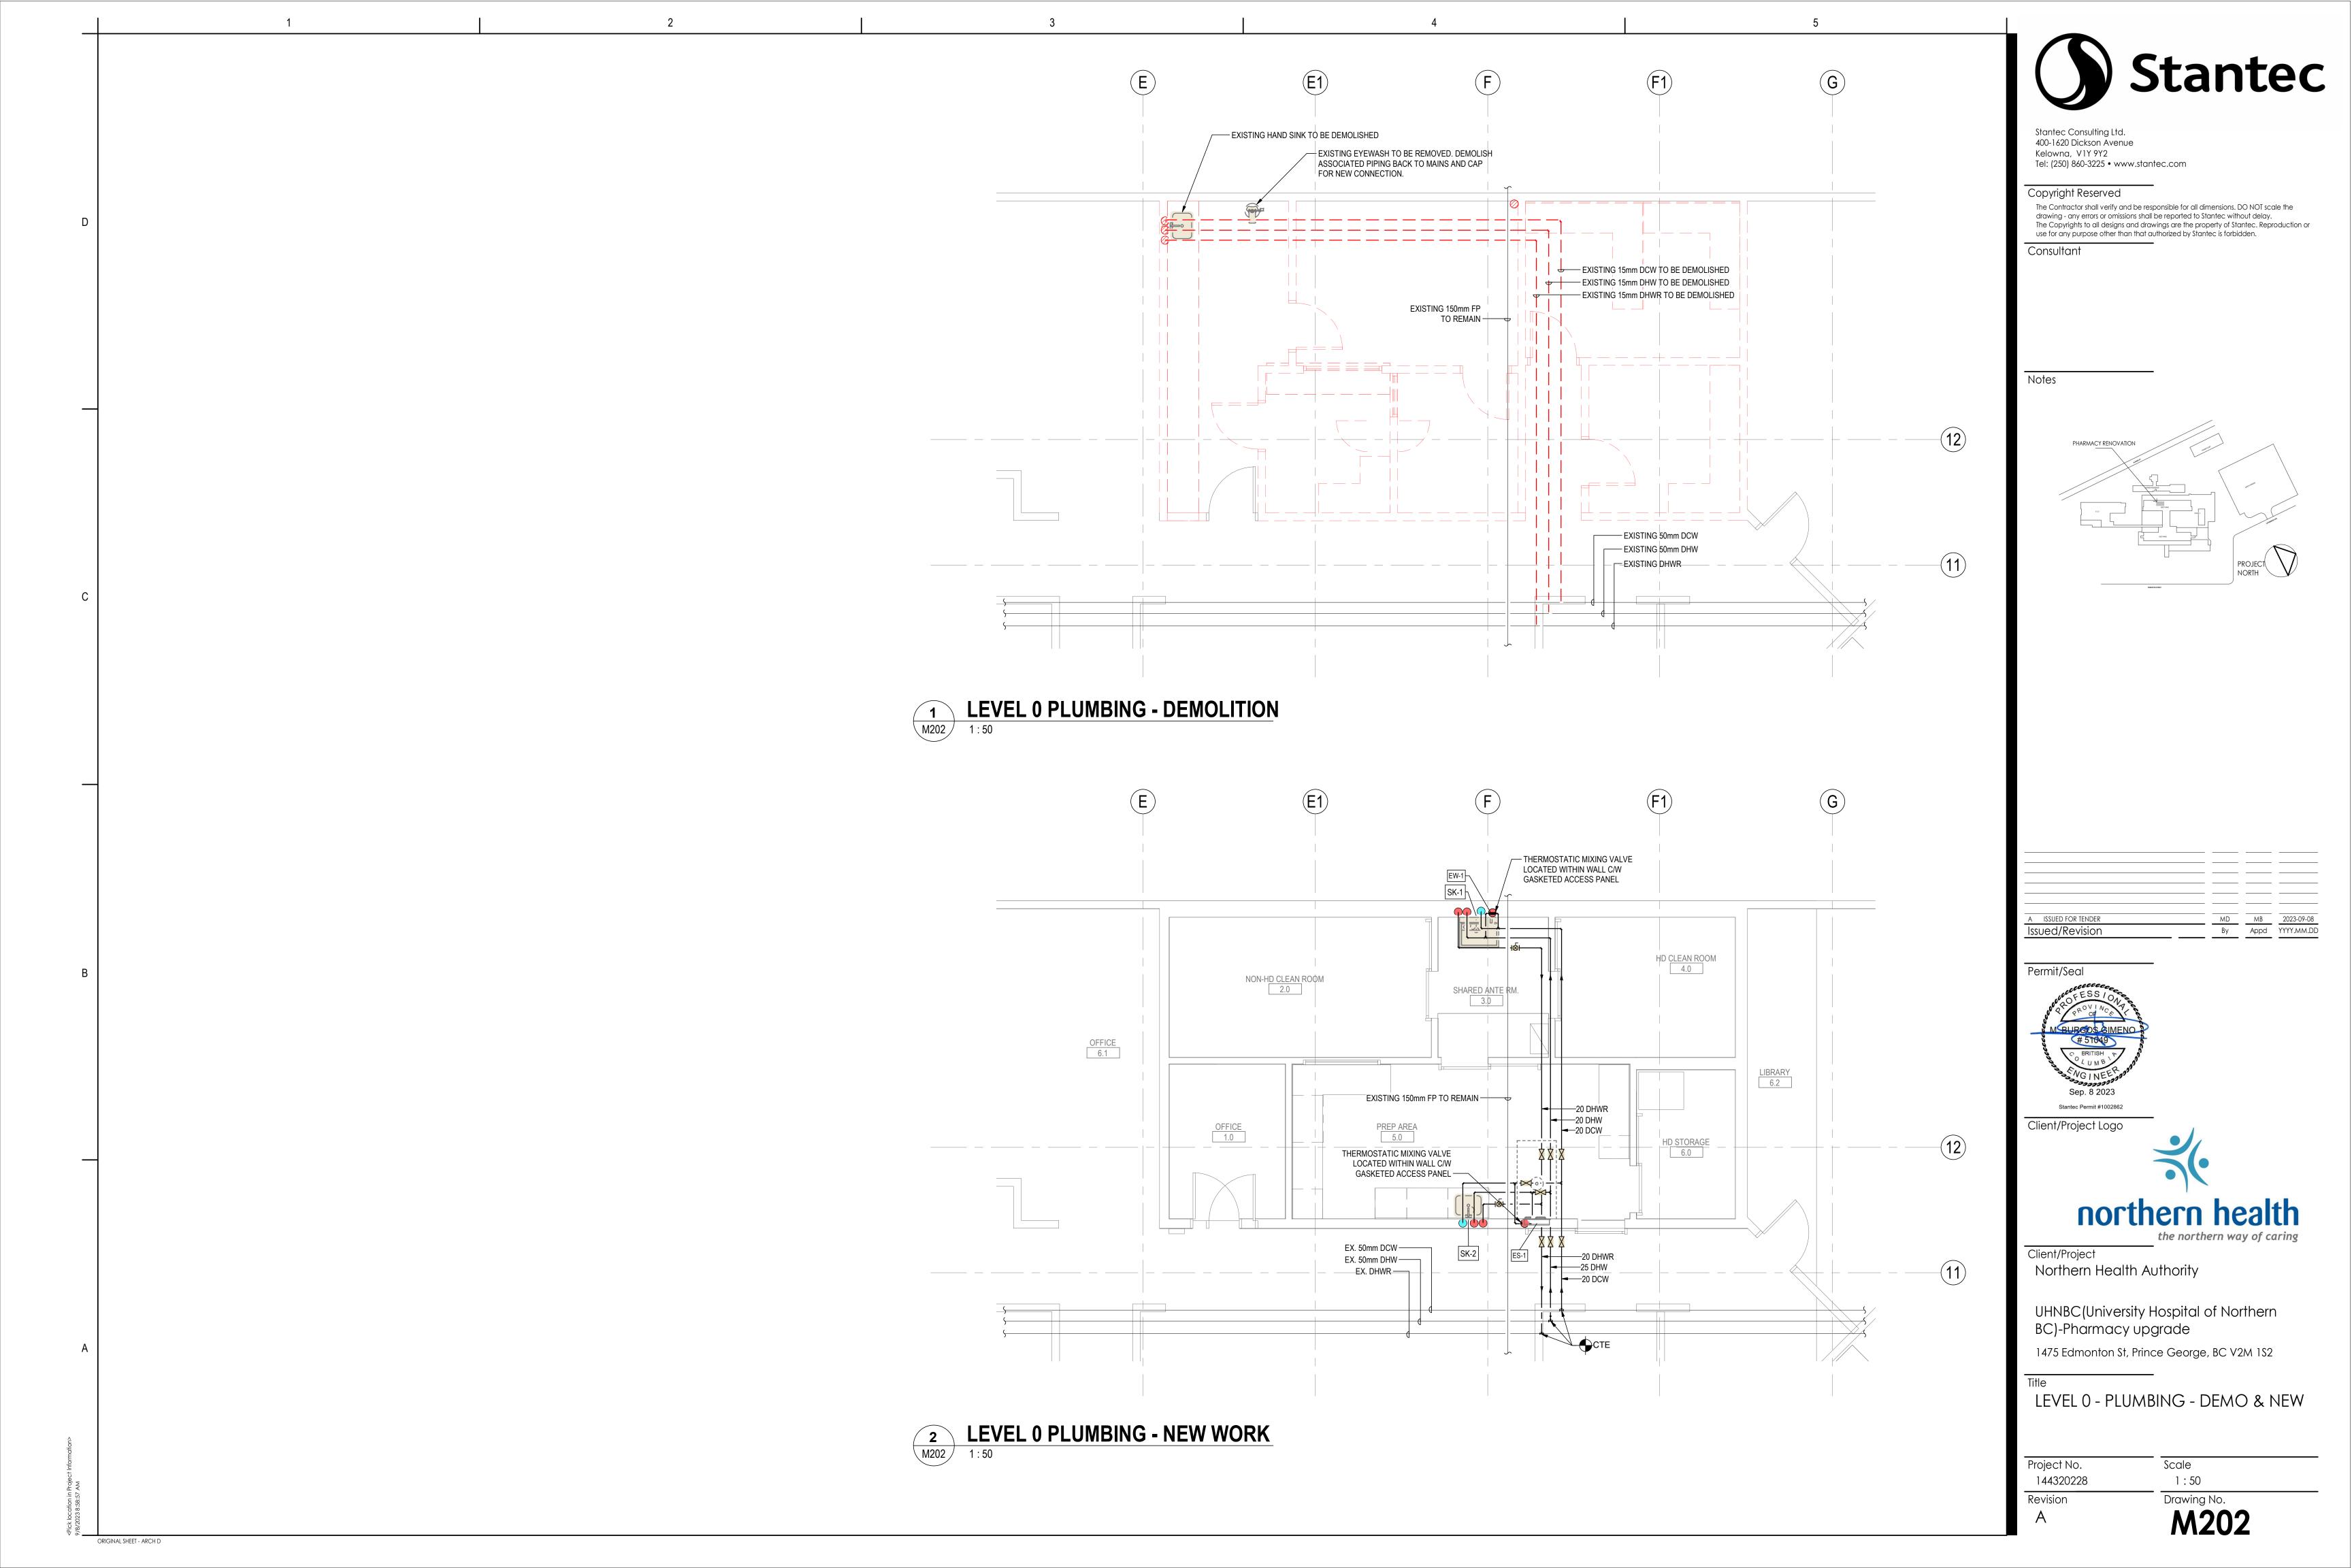
NEW SCRUB SINK (SK-1): WALL HUNG STAINLESS STEEL WITH MIXING VALVE AND ELECTRONIC (NO-TOUCH) FAUCET, SINGLE STATION - NEW FLIP DOWN EYEWASH: GUARDIAN GBF 1819 PROPOSED MODEL: FRANKE SSU1-00 SCRUB SINK WITH DELTA 1500T WALL MOUNTED, LESS BOWL G6020 ELECTRONIC FAUCET (BATTERY POWERED)
C/W THERMOSTATIC MIXING VALVE. NEW WALL MOUNTED FLIP THERMOSTATIC MIXING VALVE Stantec Consulting Ltd. 400-1620 Dickson Avenue DOWN EYEWASH TO BE MOUNTED ABOVE SCRUB SINK ----Kelowna, V1Y 9Y2 G Tel: (250) 860-3225 • www.stantec.com Copyright Reserved The Contractor shall verify and be responsible for all dimensions. DO NOT scale the drawing - any errors or omissions shall be reported to Stantec without delay.

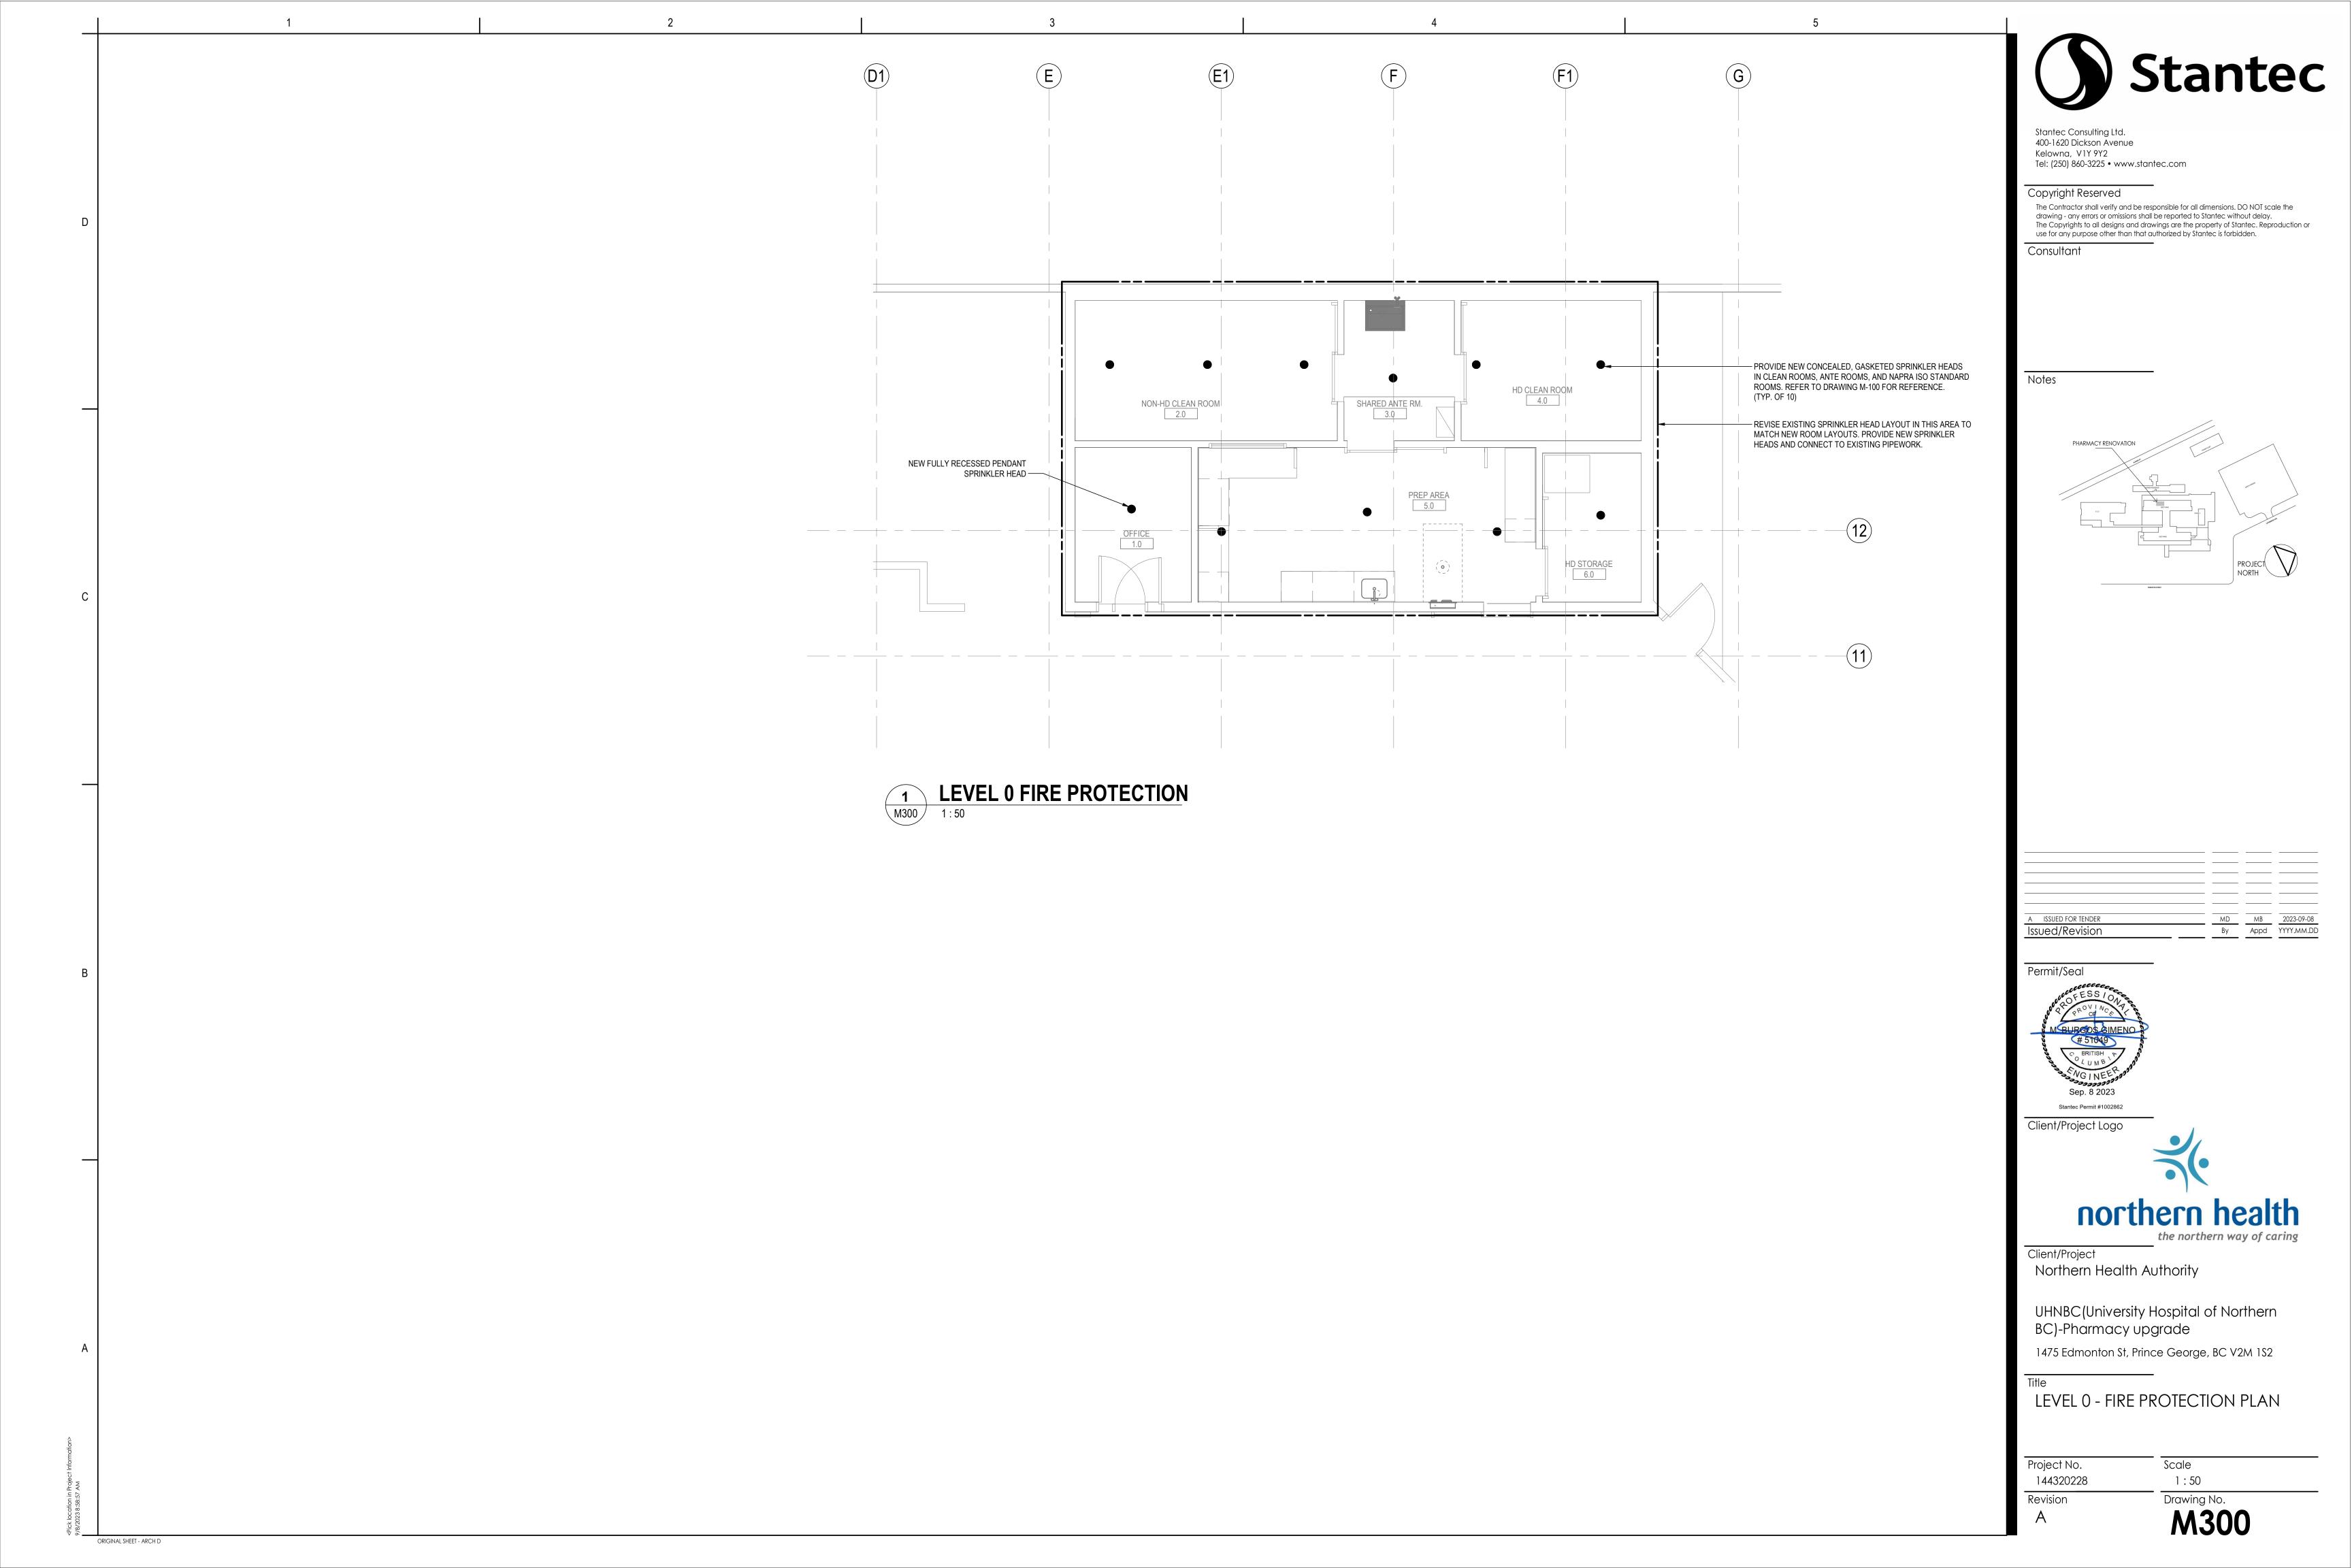
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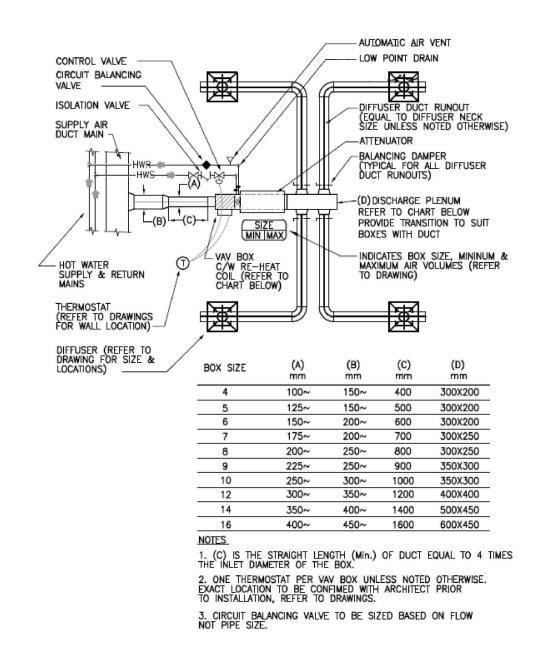
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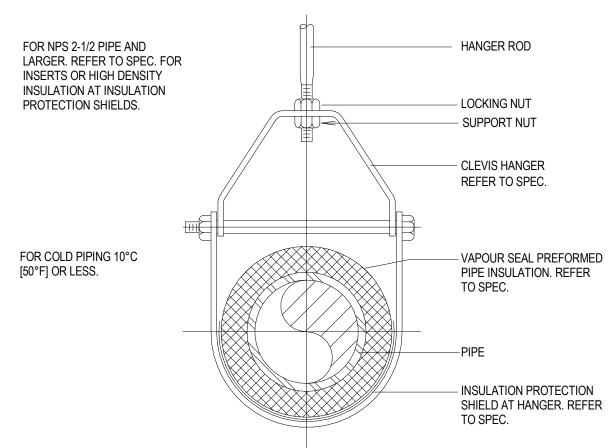




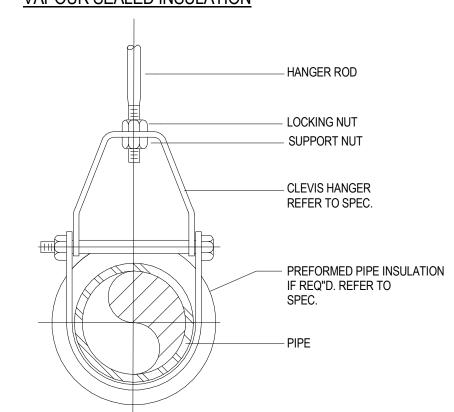




### AIR VALVE INSTALLATION C/W REHEAT



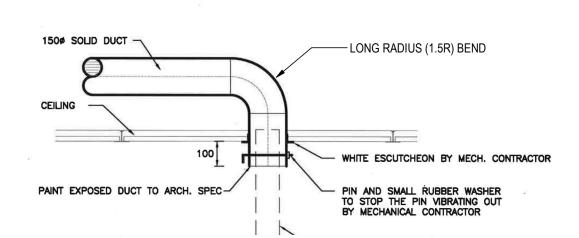
#### HANGER DETAIL FOR PIPING WITH VAPOUR SEALED INSULATION



HANGER DETAIL FOR INSULATED HOT PIPING UP TO NPS 3 (75mm) OR ALL SIZES OF BARE PIPE

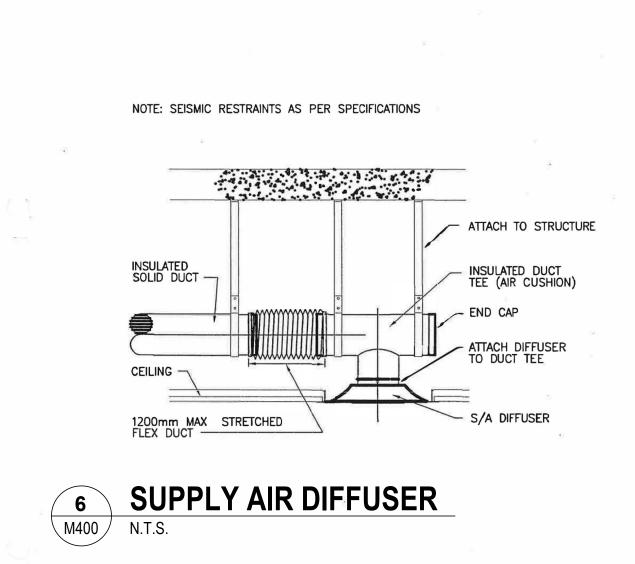
**5** PIPE HANGER DETAIL M400 NTS

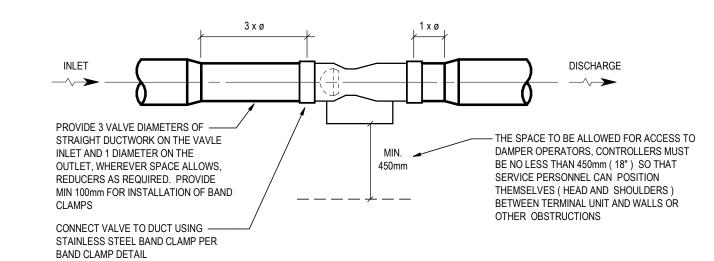
NOTE: SEISMIC RESTRAINTS AS PER SPECIFICATIONS.



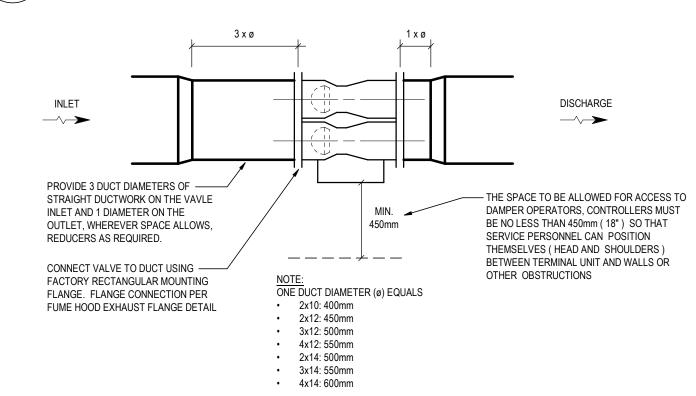
### **EXHAUST AIR OUTLET AT CEILING FOR** PHARMACY EQUIPMENT

M400 N.T.S.





#### INSTALLATION DETAIL - VENTURI AIR VALVE - SINGLE M400

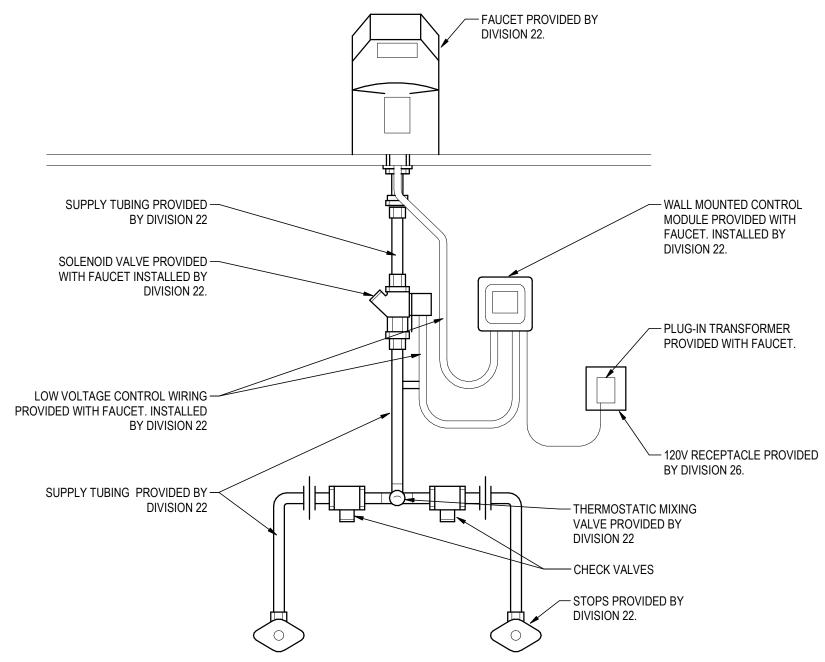


#### INSTALLATION DETAIL-VENTURI AIR VALVE-DUAL \ M400 \ N.T.S.

NOTES:
1. THIS DETAIL IS TYPICAL FOR ALL PUBLIC LAVATORIES AND SINKS

2. INSTALL VALVE IMMEDIATELY ABOVE REMOVABLE CEILING, BELOW IN ACCESSABLE CABINET, OR ACCESS PANEL NEAR FIXTURE.

3. MIXING VALVE TO PROVIDE 43C (110F) WATER TEMPERATURE AT LAVATORY OR SINK OUTLET.



**FAUCET CONNECTION DETAIL** 

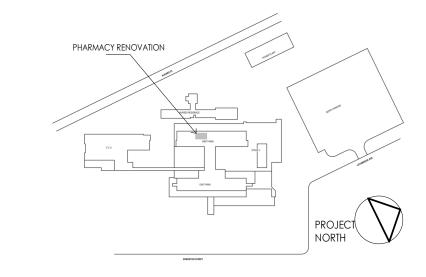
M400 N.T.S.

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MECHANICAL DETAILS

Project No. 144320228

Revision

As indicated Drawing No.

Scale

M400

320.13 15430 LBS

TOTAL CFM COOLING COIL
TYPE: 8 ROW SUPPLY AIR: 3815 CFM RETURN AIR: 3815 CFM SIZES : 1 @ 36 X 31 FILTERS: LIFT-OUT DOWNSTREAM CONN: RIGHT PULL: RIGHT VEL: 493 FPM (A) VELOCITY: 402 FPM DRAIN : LEFT TYPE: 29" DYNAMIC V-8 AIR CLEANERS COOLING COIL
TYPE: 8 ROW SIZES: 2 @ 38 X 18 B FILTERS: LIFT-OUT DOWNSTREAM VELOCITY: 402 FPM SIZES : 1 @ 36 X 31 CONN : RIGHT PULL: RIGHT DRAIN: LEFT VEL: 493 FPM TYPE: 29" DYNAMIC V-8 AIR CLEANERS SIZES: 2 @ 38 X 18 WINTER FILTERS : LIFT-OUT DOWNSTREAM VELOCITY: 477 FPM C Service : SF Fan: SF 16"A EPQN SW, 77% Width, TYPE: 2" (MERV 8) Farr 30/30 Arrangement-4 SIZES: 1 @ 24 X 24 2 @ 24 X 12 Class: 3 Max RPM: 3900 PRE-HEATING COIL OP. PT1 OP. PT2 TYPE : 2 ROW A.F.(cfm): 3815 1908 SIZES : 1 @ 36 X 31 TSP(inWC): 6.50 2.75 CONN: RIGHT PULL: RIGHT ESP(inWC): 3.50 0.00 VEL: 493 FPM RPM: 3251 1904 SUMMER FILTERS: LIFT-OUT UPSTREAM VELOCITY: 477 FPM MOTOR: 10 HP, ODP Prem-Eff, 575/3/60 RPM: 3500 (GROUNDED SHAFT) ISOLATORS: OS DEF: 2 in TYPE: 2" (MERV 8) Farr 30/30 SIZES: 1 0 24 X 24 2 0 24 X 12 FEG67  $\eta_{pt}$ : 61%  $\eta_t / \eta_{pt}$ : 96% WINTER FILTERS : LIFT-OUT DOWNSTREAM D Service : SF Fan: SF 16"A EPQN SW, 77% Width, N VELOCITY : 477 FPM TYPE: 2" (MERV 8) Farr 30/30 Arrangement-4 Class: 3 Max RPM: 3900 OP. PT1 OP. PT2 PRE-HEATING COIL TYPE: 2 ROW A.F.(cfm): 3815 1908 TSP(inWC): 6.50 2.75 SIZES: 1 @ 36 X 31 ESP(inWC): 3.50 0.00 CONN : RIGHT PULL : RIGHT RPM: 3251 1904 VEL: 493 FPM MOTOR: 10 HP, ODP Prem-Eff, 575/3/60 SUMMER FILTERS: LIFT-OUT UPSTREAM RPM: 3500 (GROUNDED SHAFT) VELOCITY: 477 FPM ISOLATORS: OS DEF: 2 in TYPE: 2" (MERV 8) Farr 30/30 FEG67  $\eta_{pt}$ : 61%  $\eta_t / \eta_{pt}$ : 96% SIZES: 1 @ 24 X 24 2 @ 24 X 12 F HUMIDIFIER Q INLET HOOD F HEATING COIL TYPE: 2 ROW R INLET DAMPER : OPPOSED BLADES MAKE : T.A. Morrison 1000 SIZES: 1 @ 36 X 31 SIZE: 29 X 28 CONN: RIGHT PULL: RIGHT S INLET HOOD VEL: 493 FPM HUMIDIFIER T INLET DAMPER : OPPOSED BLADES MAKE : T.A. Morrison 1000 HEATING COIL SIZE: 29 X 28 TYPE: 2 ROW UNIT MOUNTING SIZES: 1 @ 36 X 31 The unit is designed to be mounted on a CONN: RIGHT PULL: RIGHT roof curb. VEL: 493 FPM Note: Calculated unit weights are shipping weights and do not reflect operating conditions, items which are field installed

or ship loose.

NORMALLY CLOSED T1= 5C NORMALLY CLOSED -T1= 5C HOT GLYCOL SUPPLY 
→ NORMALLY CLOSED -HOT GLYCOL RETURN 

← T1= 5C T2= 21.6C NORMALLY CLOSED -T1= 5C

> AHU HYDRONICS SCHEMATIC M401

- PIPE OR DUCT - FLASHING (SEE ARCHITECTURAL DRAWINGS) FIBERGLASS BUILDING INSULATION 0.75 PCF DENSITY ACOUSTICAL SEALANT 25 GA. (MIN.) METAL SLEEVE -(ROOF JACK) ROOF CONSTRUCTION

NOTES:

**AHU SECTION** 

M401 NTS

1. PROVIDE PITCH POCKET CONSTRUCTION, ADDITIONAL FLASHING OR WEATHER CAP AS REQUIRED FOR WATERPROOF CONSTRUCTION. DO NOT RIGIDLY TIE DUCT OR PIPE TO STRUCTURE IN ANY WAY.

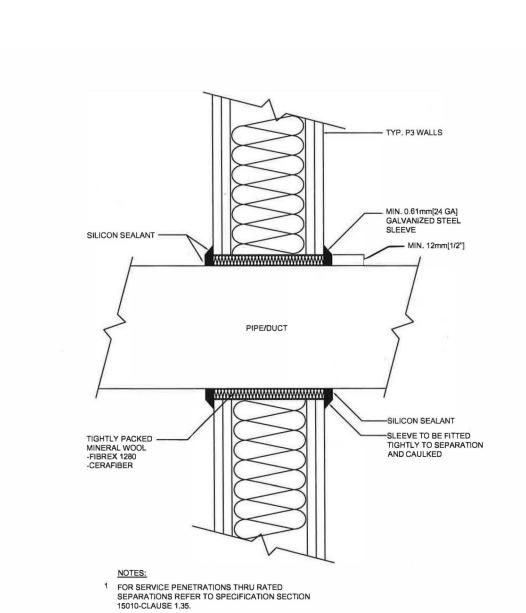
2. SPACE BETWEEN DUCT OR PIPE AND METAL SLEEVE SHALL BE FREE OF ANY FOREIGN MATERIALS.

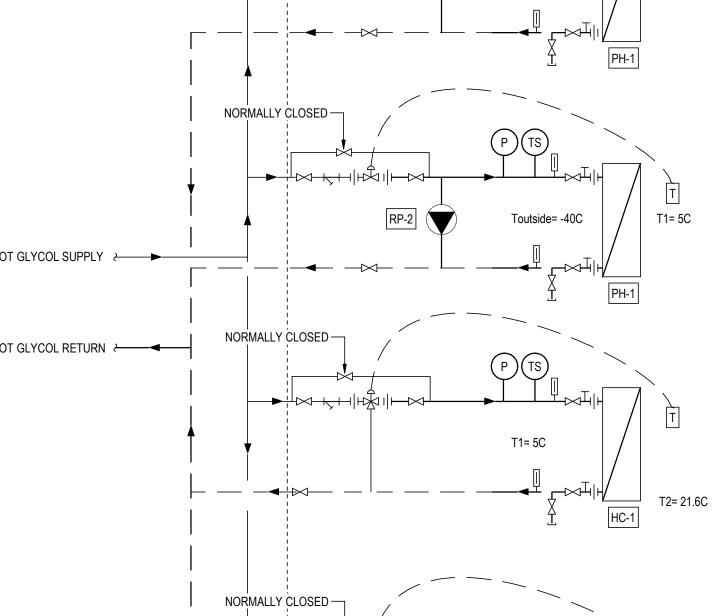
3. DUCT OR PIPE SHALL NOT DIRECTLY CONTACT STRUCTURE. WEDGES SHALL NOT BE USED TO MAINTAIN PIPE IN POSITION

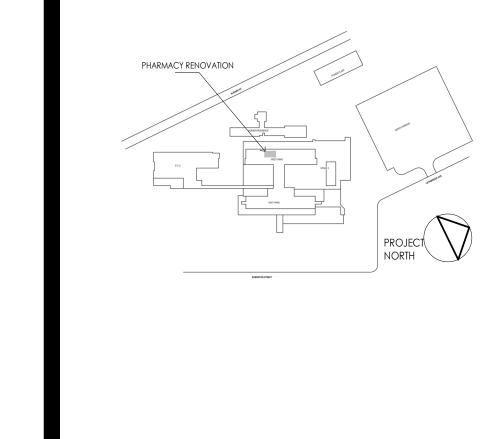
4. DUCT OR PIPE MUST BE APPROX. CENTERED ON OPENING. PROVIDE ADDITIONAL CLEARANCE FOR POSITIONAL CHANGE OF DUCT DUE TO LOADING OF DUCT OR OPERATION OF SYSTEM.

#### PIPE-DUCT PENETRATION THROUGH ROOF DETAIL M401

SERVICE PENETRATION THROUGH NON-RATED WALLS **3** M401







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Client/Project Northern Health Authority

> UHNBC (University Hospital of Northern BC)-Pharmacy upgrade

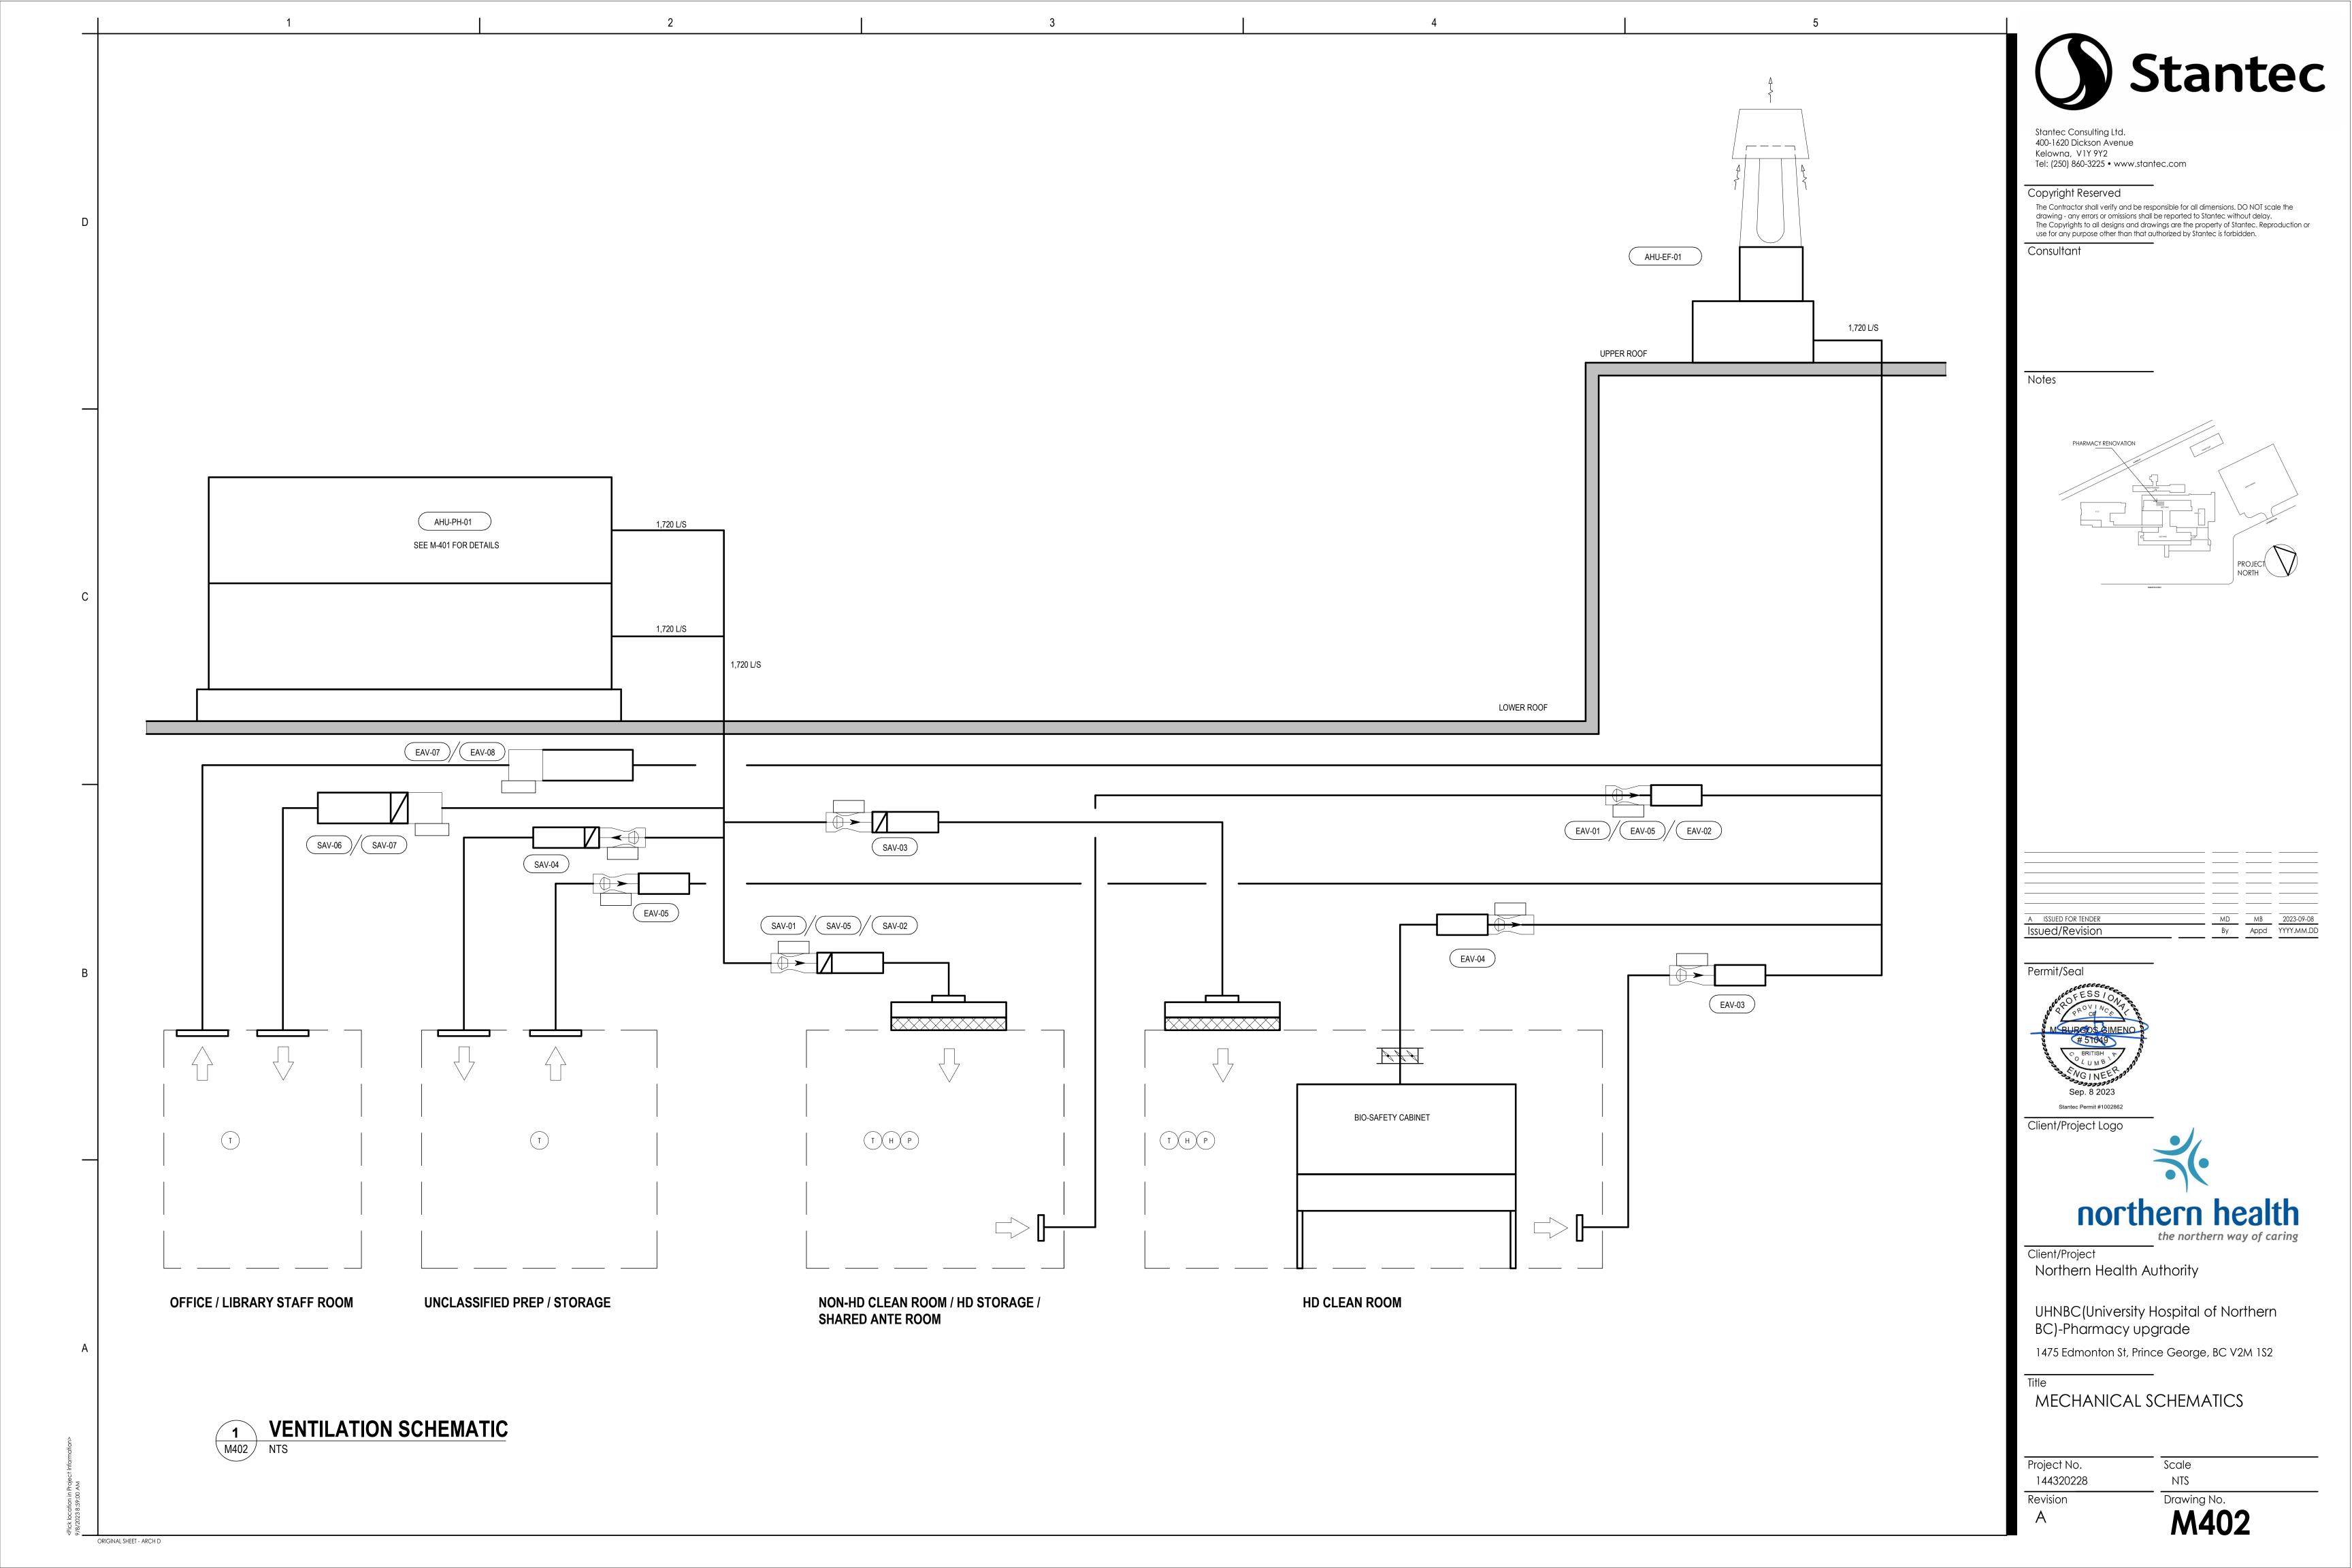
1475 Edmonton St, Prince George, BC V2M 1S2

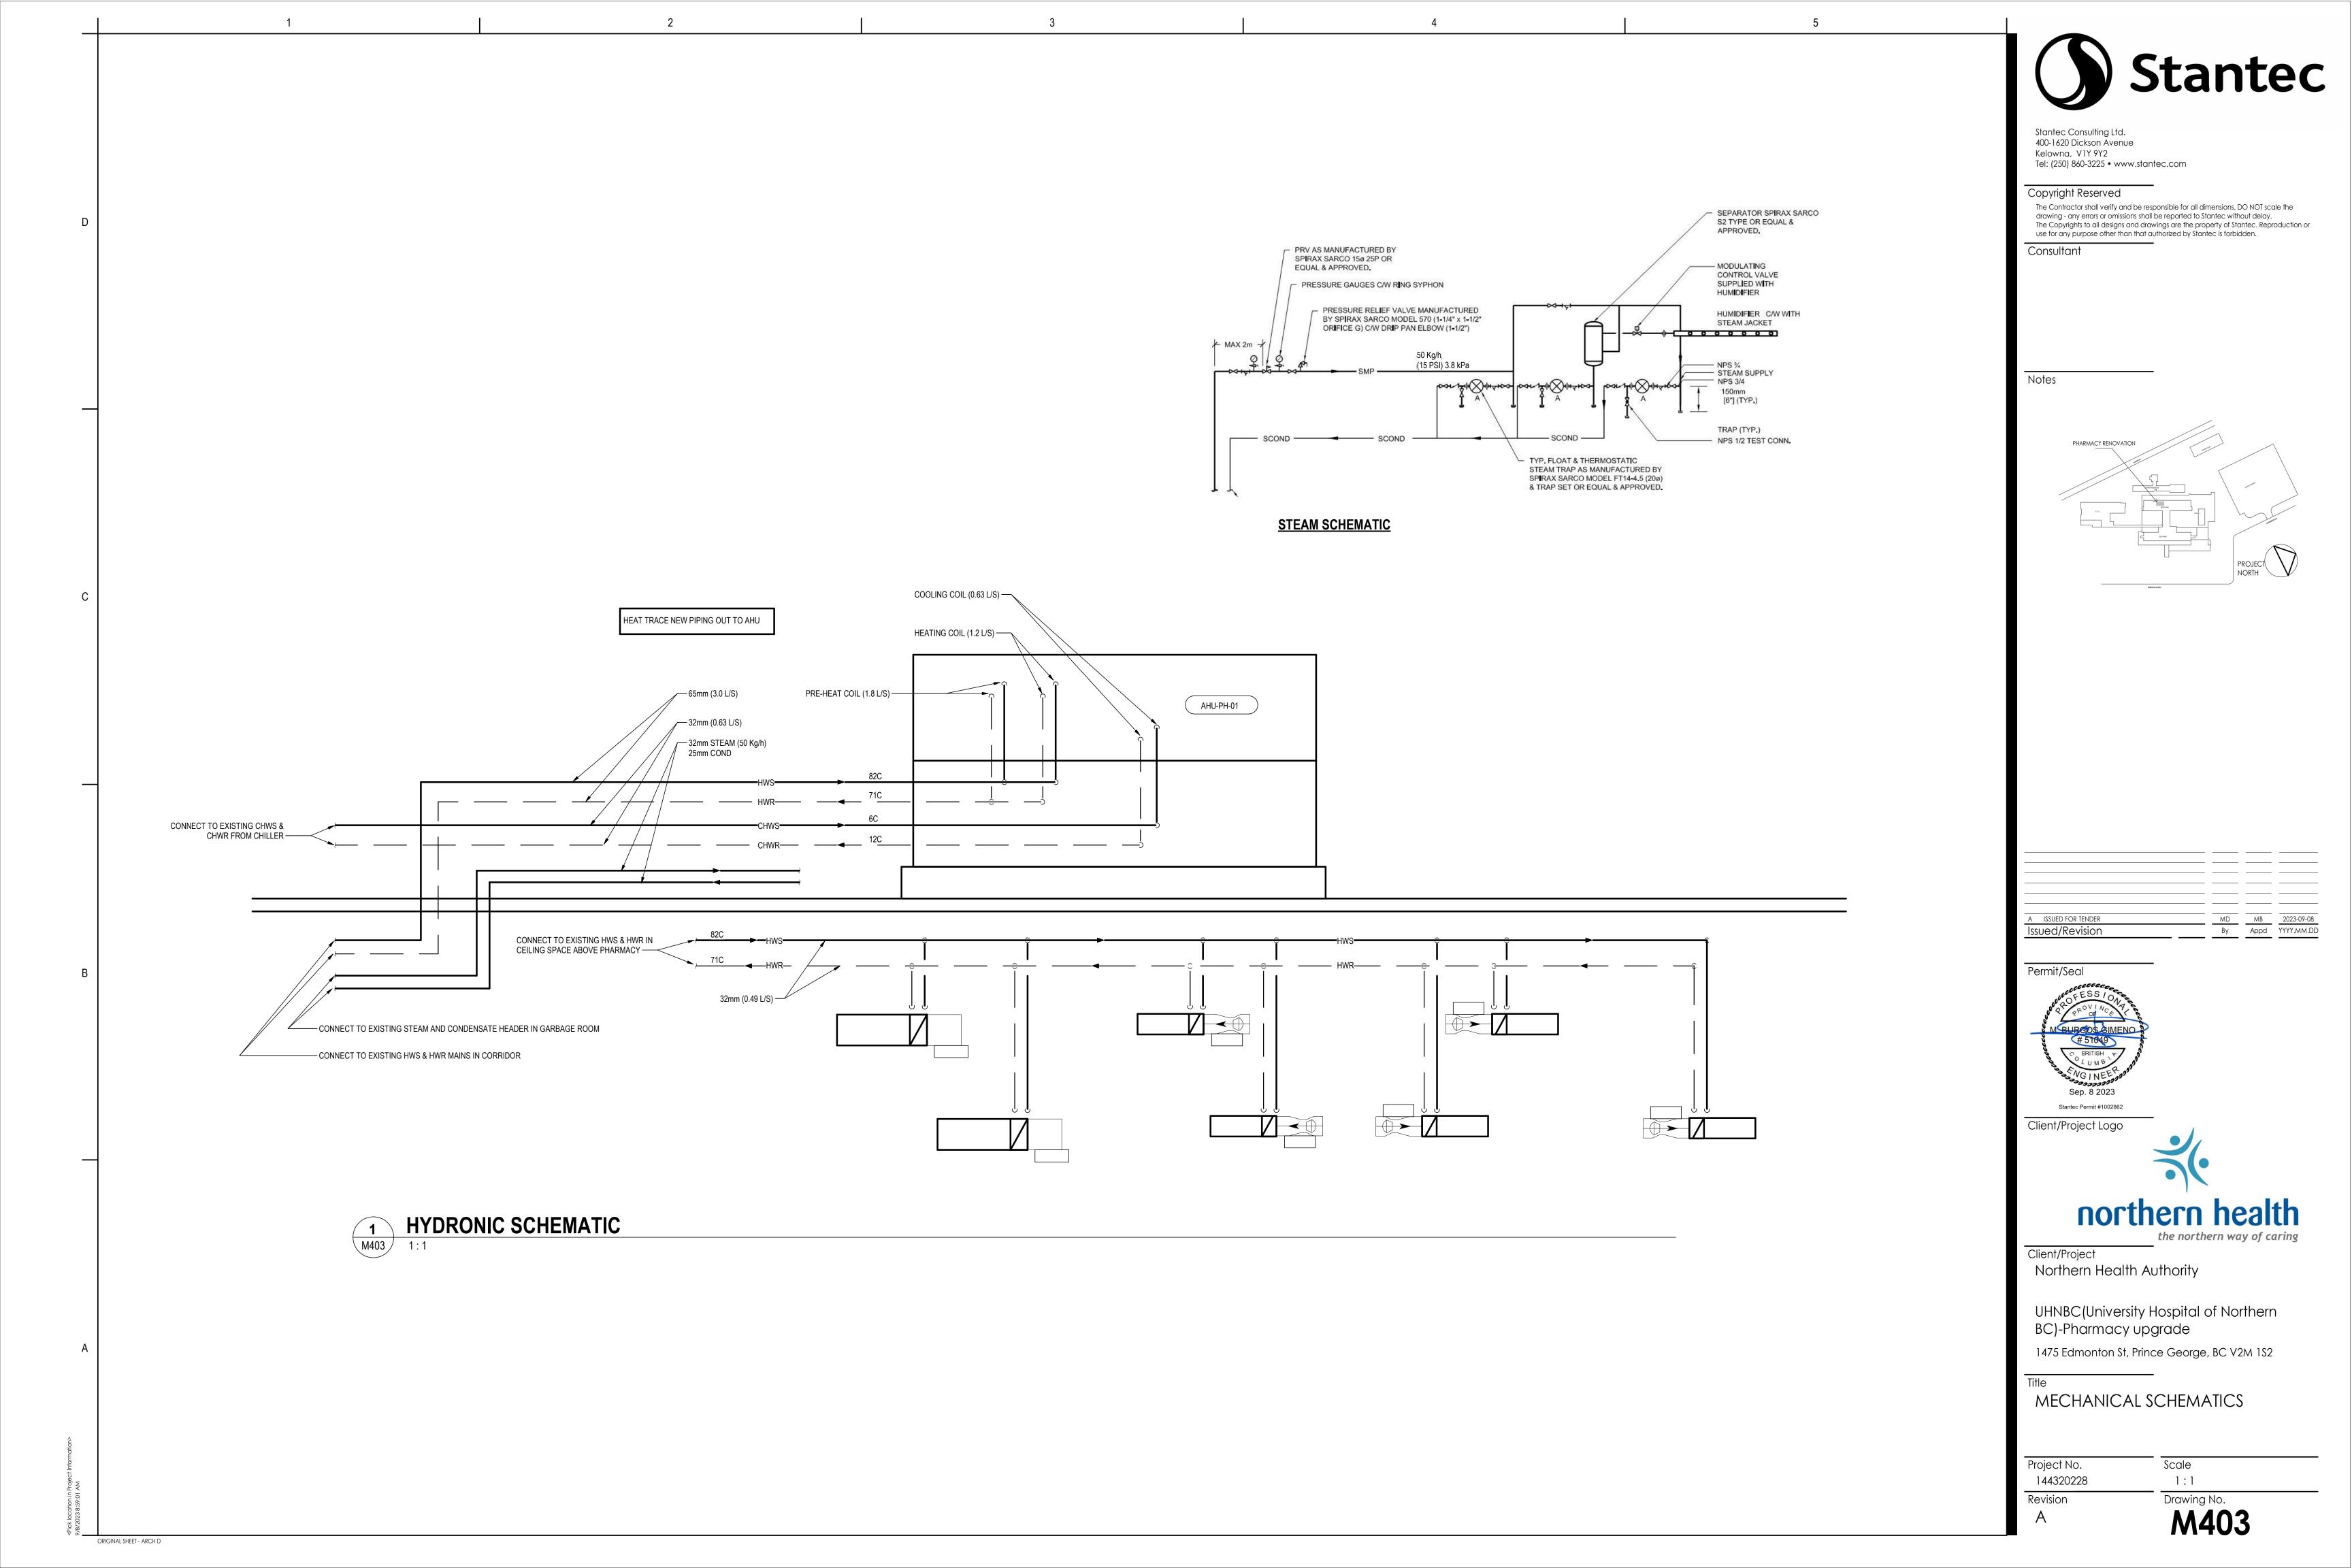
MECHANICAL DETAILS

Project No. 144320228

Scale As indicated Drawing No. M401

Revision





											AIR HANDLING UNIT	SCHEDUL	Ε															
UNIT ID	ENTIFICATION	All	RFLOW	PHY	SICAL CHA	RACTERIS	STICS																					
			Y AIR (L/s) P. OF 2)	UNIT		IUM UNIT [ OR BOTH T	DIMENSIONS	FAN	IS	FILTERS (TYP. OF 2)	STEAM HUMIDIFIER (TYP OF 2)	HYDRON	IC PRE-H	EAT COI	L (TYP. C	)F 2)	HYDRONI	C HEATI	NG COII	L (TYP.	OF 2)	COO	LING CO	OIL (TYP	. OF 2)			
MARK	LOCATION	ON AID ELOW	EXTERNAL	OPERATING	(, )	(1 OK BOTT TOTALES)		SUPPLY FAN		SUPPLY		HEATING PERFORMANCE					HEATING PERFORMANCE					COOLING PERFORMANCE					MANUFACTURER	NOTES
	200/111011	AIR FLOW (I/s)	STATIC PRESSURE (Pa)	WEIGHT (kg)	HEIGHT (mm)	WIDTH (mm)	LENGTH (mm)	QUANTITY	MOTOR RATING (kW)	MERV RATING	SCHEDULED	TOTAL CAPACITY (kW)	EDB (°C)	EWB (°C)	LDB (°C)	LWB (°C)	TOTAL CAPACITY (kW)	EDB (°C)		LDB (°C)	LWB (°C)	TOTAL CAPACITY (kW)		EWB (°C)				
AHU-PH-01	LEVEL 1 ROOF	1,800	875	7,000	2,540	3,110	8,130	2	7.5	8 (PRE) AND DYNAMIC V-8 AIR CLEANERS (FINAL)	SEPARATELY - REFER TO STEAM HUMIDIFIER SCHEDULE	98.03	-40	-	5	-	36.48	5	-	21.6	-	51.44	35.0	20.0	12.0	11.6	HAAKON	ALL

1. ELECTRICAL FOR ALL MOTORS IS 575 / 3 / 60

2. MAXIMUM FACE VELOCITY FOR ALL FILTERS IS 2.5 M/S 3. SINGLE POINT POWER CONNECTION AT 575/3/60 AND SEPARATE 120/1/60 LIGHTING CONNECTION

4. INCLUDES ENCLOSURE FOR STEAM HUMIDIFIER. 5. ALL FANS TO BE INVERTER DUTY, COMPLETE WITH ISOLATOR, AUTOMATIC DAMPER FOR FAN ISOLATION, PIEZOMETER RING AIRFLOW METERING READY FOR CONNECTION TO BMS
6. UNIT COMPLETE WITH STANDARD INSULATED ROOF CURB AND MOTOR LIFTING RAILS

7. REFER TO UNIT SECTIONS FOR MORE DETAILS 8. COILS SHALL BE RATED FOR 150 PSI (1,035 KPa)

9. SUPPLY, INSTALL, AND WIRE VARIABLE FREQUENCY DRIVES (VFD) COMPLETE WITH HARMONIC FILTERS/LINE REACTORS (FOR MOTORS OVER AND INCLUDING 5HP), FOR SPEED CONTROL OF ALL FANS.

10. THE AHU SHALL INCLUDE A HEATED/VENTILATED ENCLOSURE FOR MOUNTING VSD, CONTROLS, AND ELECTRICAL DISCONNECTS ETC.

11. THE AHU SHALL HAVE TWO INDEPENDANT FAN TUNNELS SO THAT ONE FAN CAN BE TAKEN OFFLINE WITH THE UNIT STILL IN OPERATION. REFER TO UNIT DIAGRAM.

12. COIL CAPACITIES SHOWN ARE FOR 100% O/A

	AHU COOLING COIL (WATER)																						
UNIT NO	HORTHERITIE INIT CEDVED TO THE ONLY FORT CONTROLLE ON NOTE OF THE CONTROLLE ON THE CONTROLLE													CONNEC	TION SIZE	HEIGHT	WIDTH	NO. OF	MANUFACTURER	MODEL	NOTES		
	ID NUMBER	SLIVED	(kW)	(kW)	S/A FLOW (I/s)	VELOCITY (m/s)	P.D. (Pa)	EDB (°C)	EWB (°C)	LDB (°C)	LWB (°C)	FLOW (I/s)	P.D. (kPa)	EWT (°C)	LWT (°C)	SUPPLY (mm)	RETURN (mm)	(mm)	(mm)	COILS	WANTO ACTORER	MODEL	NOTES
CC-1	AHU	-PH-01	51.44	50.86	1800	2.6	224	35	20	12	11.6	2.34	14.66	6	12	50	50	762	914	1	DIRECT COIL	5W-12-30.0-10-36.0-15	ALL
CC-2	AHU	-PH-01	51.44	50.86	1800	2.6	224	35	20	12	11.6	2.34	14.66	6	12	50	50	762	914	1	DIRECT COIL	5W-12-30.0-10-36.0-15	ALL

1. STAINLESS STEEL CASING AND DRIP PAN

4. CASING MATERIAL: STAINLESS STEEL

5. AHRI ACHC CERTIFIED

3. 6 ROW, 12 FINS PER INCH

	AHU HEATING COILS (WATER)																			
	NORTHERN				CAPACITY	, AIR						WATER (50% GLYCOL)				CONNECTION SIZE			NO. OF	NOTES
UNIT NO	HEALTH ID NUMBER	SERVICE	MANUFACTURER	MODEL	(kW)	S/A FLOW (L/S)	VELOCITY (M/S)	P.D. (Pa)	EDB (°C)	LDB (°C)	FLOW (I/s)	P.D. (kPa)	EWT (°C)	LWT (°C)	SUPPLY (mm)	RETURN (mm)	(IVIMI)	(MM)	COILS	
PHC-1		AHU-PH-01	DIRECT COIL	5W-01-30.0-13-36.0-5	98.03	1800	2.6	25	-40	5	2.33	29.11	82.2	71.1	50	50	762	914	1	ALL
PHC-2		AHU-PH-01	DIRECT COIL	5W-01-30.0-13-36.0-5	98.03	1800	2.6	25	-40	5	2.33	29.11	82.2	71.1	50	50	762	914	1	ALL
HC-1		AHU-PH-01	DIRECT COIL	5W-01-30.0-08-36.0-5	36.48	1800	2.6	17	5	21.6	0.87	14.66	82.2	71.1	25	25	762	914	1	ALL
HC-2		AHU-PH-01	DIRECT COIL	5W-01-30.0-08-36.0-5	36.48	1800	2.6	17	5	21.6	0.87	14.66	82.2	71.1	25	25	762	914	1	ALL

1. CSA-C CERTIFIED, ULC TESTED

2. THREE-POLE DISCONNETING-TYPE CONTACTOR, AIRFLOW SWITCHES, AUTOMATIC-RESET FUNCTIONAL LIMITS

3. AUTOMATIC-RESET HIGH-TEMPERATURE LIMITS, MANUAL-RESET HIGH-TEMPERATURE LIMITS.

4. PDS FIXED, C/W PITOT TUBE

5. DOOR INTERLOCK DISCONNECT SWITCH

6. GALVANIZED SCREENS BOTH SIDES 7. ENCLOSURE FLUSH TOP AND BOTTOM

							AHU S	UPPLY FA	NS							
UNIT NO	NORTHERN HEALTH ID NUMBER	UNIT SERVED	FAN TYPE	AIR FLOW (I/s)	FAN S.P. (Pa)	FAN E.S.P. (Pa)	FAN MOTOR (kW)	FAN DRAW (kW)	FAN (RPM)	FAN CLASS	IMPELLER DIA (mm)	DRIVE TYPE	VOLTS/PHASE/Hz	MANUFACTURER	MODEL	NOTES
SF-1		AHU-PH-01	PLENUM	1800	1617	871	7.5	6.7	3251	3	406	Direct	575/3/60	HAAKON	16TCEPQN	ALL
SF-2		AHU-PH-01	PLENUM	1800	1617	871	7.5	6.7	3251	3	406	Direct	575/3/60	HAAKON	16TCEPQN	ALL

NOTES

1. INVERTER DUTY MOTOR C/W SHAFT GROUNDING

2. C/W ISOLATOR

3. FAN PIEZO RING FOR AIRFLOW MEASUREMENT

4. ELEVATION: 580 m

						AHU HI	<b>JMIDIFIE</b>	RS				
UNIT NO.	SERVICE	TYPE	MANUF	MODEL	CAPACITY (Kg/HR)	STEAM PRESSURE (kPa)	AIR VOLUME (L/s)	` '	DESIRED DB (C) / DESIRED RH (%)	MAXIMUM ABSORPTION DISTANCE (mm)	STEAM VALVE MODEL	NOTES
HUM-1	AHU-PH-01	STEAM	CAREL	SABCBLI2U0	66.7	103.4	1800	20 / 0	20 / 35	147	SAKV00FEU0	ALL
HUM-2	AHU-PH-01	STEAM	CAREL	SABCBLI2U0	66.7	103.4	1800	20 / 0	20 / 35	147	SAKV00FEU0	ALL

1. AIRFLOW PROVING SWITCH

2. HIGH-LIMIT HUMIDI-STAT, ON-OFF HIGH LIMIT

4. HIGH EFFICIENCY PVDF INSULATED MANIFOLDS AND TUBES

5. 304 S.S. ENCLOSURE AND TUBE

3. TEMPERATURE SWITCH

6. NOT USED. 7. CONDENSATE COOLER FOR DISPERSION MANIFOLD

8. 304 S.S. CONDENSATE DRAIN COOLER C/W TEMPERATURE ACTUATED VALVE AND FLOOR STAND

9. SUPPORT FRAME FOR INSTALLATION OF THE HUMIDIFIER

10. INSUALTED COPPER PIPE BETWEEN THE HUMIDIFIER AND DISPERSION TUBE PER MANUFACTURER'S REQUIREMENTS

						———Pl	JMP SCHED	OULE							
	UNIT IDENTIFICATION			P	ERFORMAN	ICE				ELECT					
MARK	SYSTEM SERVED	CONTROL	FLUID TYPE	FLUID TEMP (°C)	FLOW (l/s)	PUMP HEAD (kPa)	MIN EFFICIENCY (%)	HP	SPEED (RPM)	VOLTS	PHASE	OPERATING WEIGHT (kg)	MANUFACTURER	MODEL NUMBER	NOTES
RP-1	PREHEAT COIL 1	CONTINUOUS	GLYCOL	36	0.94	36	49.74	1	1,200	208	3	73.2	KSB	ETANORM 050-032-1251 GG	
RP-1	PREHEAT COIL 2	CONTINUOUS	GLYCOL	36	0.94	36	49.74	1	1,200	208	3	73.2	KSB	ETANORM 050-032-1251 GG	
NOTES:															

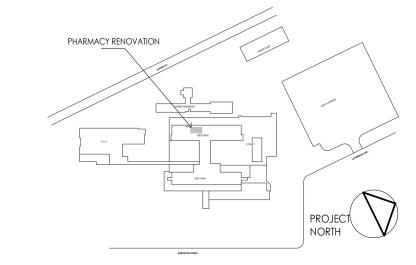


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Client/Project Logo



Client/Project Northern Health Authority

UHNBC (University Hospital of Northern BC)-Pharmacy upgrade

1475 Edmonton St, Prince George, BC V2M 1S2

MECHANICAL SCHEDULES

Project No. 144320228

Revision

Drawing No.

Scale

M500

			PHARMACY A	AIR VALVE SCHED	OULE (AV	)					
AREA SERVED	AIR VALVE No.	MANUFACTURER	MODEL	PHOENIX MODEL NUMBER	SIZE (in)	REHEAT COIL	OCCUPII	ED MODE	UNOCCU	PIED MODE	NOTES
							MAX. (L/s)	MIN. (L/s)	MAX. (L/s)	MIN. (L/s)	
2.0 NON-HD CLEAN ROOM	EAV-01	Phoenix Controls	ACCEL II	EXVA112L	12	-	275	-	275	-	1,2,3,4,5,6,8,9
3.0 SHARED ANTE ROOM	EAV-02	Phoenix Controls	ACCEL II	EXVA108L	8	-	85	-	85	-	1,2,3,4,5,6,8,9
4.0 HD CLEAN ROOM	EAV-03	Phoenix Controls	ACCEL II	EXVA112L	12	-	230	-	230	-	1,2,3,4,5,6,7,8,9
BIO-SAFETY CABINET	EAV-04	Phoenix Controls	ACCEL II	EXVA112L	2x12	-	600	-	600	-	1,2,3,4,5,6,7,8,9,11
5.0 UNCLASSIFIED PREP / STORAGE SPACE	EAV-05	Phoenix Controls	ACCEL II	EXVA108L	8	-	150	-	150	-	1,2,3,4,5,6,8,9
6.0 HD STORAGE	EAV-06	Phoenix Controls	ACCEL II	EXVA108L	8	-	135	-	135	-	1,2,3,4,5,6,7,8,9
2.0 NON-HD CLEAN ROOM	SAV-01	Phoenix Controls	ACCEL II	MAVA212L	12	REFER TO HTG COIL SCHED.	295	295	295	295	1,2,3,4,5,6,8,9,10,12
3.0 SHARED ANTE ROOM	SAV-02	Phoenix Controls	ACCEL II	MAVA108L	8	REFER TO HTG COIL SCHED.	105	105	105	105	1,2,3,4,5,6,8,9,10,12
4.0 HD CLEAN ROOM	SAV-03	Phoenix Controls	ACCEL II	MAVA212L	2x12	REFER TO HTG COIL SCHED.	810	810	810	810	1,2,3,4,5,6,8,9,10,12
5.0 UNCLASSIFIED PREP / STORAGE SPACE	SAV-04	Phoenix Controls	ACCEL II	MAVA108L	8	REFER TO HTG COIL SCHED.	170	170	170	170	1,2,3,4,5,6,8,9,10,12
6.0 HD STORAGE	SAV-05	Phoenix Controls	ACCEL II	MAVA108L	8	REFER TO HTG COIL SCHED.	115	115	115	115	1,2,3,4,5,6,8,9,10,12
NOTEC:							'		'		

L. PRESSURE SWITCH, LOW LIMIT.

2. FAILS TO LAST POSITION.

4. ELECTRONIC VALVE CONTROLLER.

5. CONICAL-SHAPED DIFFUSER VALVE DESIGN. 6. PRESSURE CONTROL (POC) ALTERNATE OFFSET CAPABILITY.

7. PROVIDE PHENOLIC COATING FOR HAZARDOUS EXHAUST.

8. LOW PRESSURE OPERATION.

9. PROVIDE WITH SYSTEM, REMOTE ACCESS CAPABILITY. 10. INCLUDE HYDRONIC RE-HEAT COIL, WORKING FLUID WATER.

11. SHUT-OFF CAPABILITY.

12. INCLUDE DOOR CONTACTS AND PHOENIX CONTROLS PRESSURE INDICATOR AND MONITORING EQUIPMENT.

3. HORIZONTAL VALVE ORIENTATION. CONTRACTOR TO CONFIRM AIR VALVE ORIENTATION PRIOR TO ORDERING.

							DUCT	MOUNTE	D HOT W	ATER HE	EATING COIL S	CHEDULI	E							
	UNIT IDENTIFICATION		(	COIL				AIR					FLUIC	)						
REHEAT COIL NO.	ROOM(S) SERVED	TOTAL CAPACITY (kW)	HEIGHT (mm)	LENGTH (mm)	NUMBER OF ROWS	AIRFLOW (I/s)	EDB (°C)	LDB (°C)	FACE VELOCITY (m/s)	MAX APD (Pa)	FLUID TYPE	FLUID FLOW (I/s)	EWT (°C)	LWT (°C)	TUBE VELOCITY (m/s)	MAX WPD (kPa)	OPERATING WEIGHT (kg)	MANUFACTURER	MODEL NUMBER	NOTES
RH-AV-S1	2.0 NON-HD CLEAN ROOM	4.0	394	425	1	295	15	26.2	2.7	12.51	50% PRO. GLYCOL	0.09	82.2	70.4	0.74	7.42	8.4	HEATCRAFT	4BS0901A 317.50 x 349.25	
RH-AV-S2	3.0 SHARED ANTE ROOM	1.4	279	279	1	105	15	26.0	2.5	16.60	50% PRO. GLYCOL	0.03	82.2	69.8	0.46	3.33	4.9	HEATCRAFT	3BS0801B 203.20 x 203.20	
RH-AV-S3	4.0 HD CLEAN ROOM	11.1	381	724	1	810	15	26.3	4.1	34.54	50% PRO. GLYCOL	0.23	82.2	69.4	1.19	13.02	11.4	HEATCRAFT	5BS1001A 304.80 x 647.70	
RH-AV-S4	5.0 UNCLASSIFIED PREP / STORAGE SPACE	2.4	279	305	1	170	15	26.5	3.7	26.74	50% PRO. GLYCOL	0.05	82.2	69.7	0.79	9.17	5.3	HEATCRAFT	3BS1601A 203.20 x 228.60	
RH-AV-S5	6.0 HD STORAGE	1.5	279	279	1	115	15	26.1	2.8	14.79	50% PRO. GLYCOL	0.03	82.2	68.6	0.48	3.71	5.0	HEATCRAFT	3BS1401A 203.20 x 203.20	

							VAV SC	HEDLILE												
		1	1	ı			VAV 3C	ILDOLL	ı								1			
AREA SERVED	TAG	MANUFACTURER	MODEL	UNIT SIZE	MAX PRIMARY (L/s)	MIN PRIMARY (L/s)	TERMINAL LINER	REHEAT (L/s)	WC CAPACITY (kW)	EAT (°C)	LAT (°C)	FLUID FLOW (L/s)	FPD (kPa)	FLUID TYPE	GLYCOL %	ROWS	MAX COIL APD (Pa)	EWT (°C)	LWT (°C)	NOTES
1.0 EXISTING OFFICE	EAV-07	PRICE	SDE5	4	45	-	FG75													1
6.2 LIBRARY	EAV-08	PRICE	SDE5	7	180	-	FG75													1
1.0 EXISTING OFFICE	SAV-06	PRICE	SDV	4	45	28	FG50	45	0.72	15.00	27.00	0.01	0.18	PG	50.00	1L	2	82.20	66.80	ALL
6.2 LIBRARY	SAV-07	PRICE	SDV	7	180	138	FG50	180	2.64	15.00	27.00	0.09	6.54	PG	50.00	1L	17	82.20	74.40	ALL

1. VAV'S TO BE SUPPLIED WITH ATTENUATORS, TO BE FIBRE FREE.

2. CSA-C CERTIFIED, ULC TESTED ELECTRIC COIL. B. ELECTRIC HEATERS SHALL BE APPROVED FOR ZERO CLEARANCE FOR ALL COMBUSTIBLE MATERIALS.

4. ALL CONTROLS SHALL BE INTEGRATED AND PRE-WIRED WITH A NEMA-1 CONTROL PANEL WHICH INCLUDE A REMOVABLE, HINGED DOOR TO PROVIDE EASY ACCESS.

5. S.C.R. MODULATING ELECTRIC HEATERS SHALL BE SUPPLIED WITH AN ELECTRIC SENSOR ON EACH SIDE OF THE HEATER TO MEASURE THE TEMPERATURE IN ACCORDANCE WITH THE MEASURED PARAMETERS. THE NEPTRONIC HEC CONTROLLER SHALL STOP THE ELECTRIC

5. MANUAL AND AUTOMATIC CUT-OUT.

7. DOOR INTERLOCK DISCONNECT SWITCH

3. 24 V TRANSFORMER

9. LOW WATT DENSITY ELEMENTS, HIGH GRADE NICKEL-CHROME ALLOY

							F	AN SCHE	DULE									
	UNIT IDENTIFI	CATION				FAN WHEEL	-		FAN I	MOTOR		ELEC <sup>-</sup>	TRICAL					
MARK	NORTHERN HEALTH ID NUMBER	SYSTEM	MAX AIRFLOW (I/s)	ESP (Pa)	CONTROL	TYPE	SPEED (RPM)	ВНР	HP	SPEED (RPM)	DRIVE TYPE	VOLTS	PHASE	NOISE LEVEL (dBA)	OPERATING WEIGHT (kg)	MANUFACTURER	MODEL NUMBER	NOTES
EF-PH-1		PHARMACY EXHAUST	1,725	650	VFD	HIGH PLUME REDUNDANT	1,800	3.1 (2)	5 (2)	1,800	DIRECT	575	3	71	1300	GREENHECK	VK-MH-18-85-14	1-10

1. COMPLETE WITH 24" INSULATED ROOF CURB, BACKDRAFT DAMPER, DISCONNECT SWITCH.

2. COMPLETE WITH INLINE SILENCER AND ACOUSTIC BYPASS DAMPERS C/W RAINHOOD. 3. C/W NEMA PREMIUM EFFICIENT MOTOR, INVERTER DUTY, TEFC, CLASS F OR GREATER INSULATION, SHAFT GROUNDING, VFD C/W ENCLOSURE SUITABLE FOR OUTDOOR INSTALLATION.

I. C/W SPRING ISOLATORS AND SEISMIC RESTRAINTS. 5. DISCONNECT SWITCH , JUNCTION BOX MOUNTED AND WIRED.

6. EC MOTOR WITH 0-10VDC INPUT

7. CONTORL TRANSFORMER, MOUNTED AND WIRED 8. OUTLET GUARD

9. JUNCTION BOX MOUNTED AND WIRED 10. MOTOR COVER.

							_
				HVAC GRILLES, REGISTERS AND DIFFUSERS			
TAG	MANUFACTURER	MODEL	DUTY	TYPE	MATERIAL	FACE SIZE	ACCESSORIES
S-1	E.H PRICE	SPD	SUPPLY	SQUARE PLAQUE DIFFUSER	STEEL	SEE DWGS	1,2,3
S-2	E.H PRICE	LFDC	SUPPLY	LAMINAR FLOW DIFFUSER HIGH EFFICIENCY FILTER	STAINLESS STEEL	600x600	1,2,3,4,5
S-3	E.H PRICE	LFDC	SUPPLY	LAMINAR FLOW DIFFUSER HIGH EFFICIENCY FILTER	STAINLESS STEEL	300x1200	1,2,3,4,5
S-4	E.H PRICE	LFDC	SUPPLY	LAMINAR FLOW DIFFUSER HIGH EFFICIENCY FILTER	STAINLESS STEEL	600x1200	1,2,3,4,5
E-1	E.H PRICE	730	EXHAUST	STAINLESS STEEL LOUVERED GRILLE	STAINLESS STEEL	SEE DWGS	1,2,3
E-2	E.H PRICE	630	EXHAUST	LOUVERED FACE EXHAUST GRILLE	ALUMINUM	SEE DWGS	1,2,3
E-3	E.H PRICE	80 SERIES	EXHAUST	EGG CRATE EXHAUST GRILLE	ALUMINUM	SEE DWGS	1,2,3

NOTES:

1. REFER TO ARCHITECTURAL DRAWINGS FOR TYPE OF CEILING AND/ OR SUSPENSION SYSTEM.

2. FINISH SHALL BE OF THE TYPE AND COLOR SELECTED BY THE ARCHITECT. SUBMIT CHART FOR SHOP DRAWINGS.

B. COORDINATE WITH ARCHITECT THE REQUIRED BORDER TYPE, END CAP, FRAME, MOUNTING, FINISH, AND COLOUR PRIOR TO ORDERING

4. COMPLETE WITH AEROSOL INJECTION PORT (INJ)

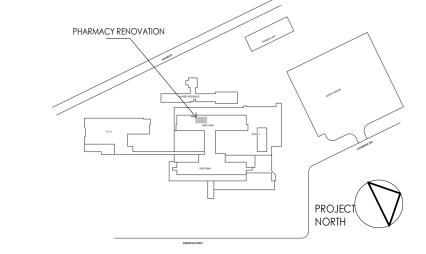
5. COMPLETE WITH HEPA FILTRATION.

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Client/Project Logo



Client/Project Northern Health Authority

UHNBC (University Hospital of Northern BC)-Pharmacy upgrade

1475 Edmonton St, Prince George, BC V2M 1S2

MECHANICAL SCHEDULES

Project No. 144320228

Revision

Drawing No.

Scale

GENERAL SYMBOLS (#) NOTE REFERENCE (##) (####) EQUIPMENT REFERENCE REVISION NUMBER WIRING HOME RUN E604/1 DETAIL REFERENCE (1 DENOTES DETAIL NUMBER, E604 DENOTES SHEET NUMBER)

	SECURITY/ACCESS CONTROL SYMBOLS
CR	CARD READER
CK	CARD READER AND KEYPAD
EDS	ELECTRONIC DOOR STRIKE
ML	MAGNETIC LOCK
DC	DOOR CONTACT
DP	DOOR POSITION SWITCH
RE	REQUEST TO EXIT WALL MOUNTED SENSOR
0	WAVE TO OPEN PUSHBUTTON
1	EMERGENCY PANIC PUSHBUTTON
ADO	AUTOMATIC DOOR OPENER
EL	ELECTRIFIED LOCK SET
	CEILING MOUNTED SECURITY CAMERA

	TELECOMMUNICATIONS SYMBOLS
<b>#</b>	WALL MOUNTED TELECOM OUTLET (# DENOTES NUMBER OF CAT 6A CABLES)
■INTERCOM	WALL MOUNTED BI-DIRECTIONAL INTERCOM
#	CEILING MOUNTED DATA OUTLET (#DENOTES NUMBER OF DATA DROPS)
<b>□</b> → WAP	WIRELESS ACCESS POINT (PROCURED BY OTHERS, INSTALLED BY CONTRACTOR)
Ф	CLOCK RECEPTACLE

	ABBREVIATIONS
AV	AUDIO-VISUAL
ADO	AUTOMATIC DOOR OPENER
AFF	ABOVE FINISHED FLOOR
EX	EXISTING EQUIPMENT TO REMAIN
WAP	WIRELESS ACCESS POINT
BMS	BUILDING MANAGEMENT SYSTEM
FR	FRIDGE/FREEZER
RE	EXISTING EQUIPMENT TO BE REMOVED
RL	EXISTING EQUIPMENT IN A RELOCATED POSITION
HK	HOUSEKEEPING
JB	JUNCTION BOX
LC	LIGHTING CONTROL
MW	MICROWAVE
PC	PERSONAL COMPUTER
TYP	TYPICAL
UC	UNDERCOUNTER
WP	WEATHERPROOF
WRK	STAFF WORKSTATION
GF	GROUND FAULT CIRCUIT INTERRUPTER
ADO	AUTOMATIC DOOR OPENER

	FIRE ALARM SYMBOLS
F	MANUAL STATION
FO	BELL
□⊲HS	HORN SPEAKER
□<  CS	CONE SPEAKER
0	SMOKE DETECTOR
ODC	SMOKE DETECTOR, DC DENOTES DUAL CONTACT
<b>⊘</b> DS	SMOKE DETECTOR, DUCT MOUNTED
<b>⊘</b> SA	SMOKE ALARM
FAA	FIRE ALARM ANNUNCIATOR PANEL
FACP	FIRE ALARM CONTROL PANEL
CACF	CENTRAL ALARM & CONTROL FACILITY
C	EMERGENCY TELEPHONE
	FA CONTROL TERMINAL
Н	FIRE ALARM MAGNETIC DOOR HOLD OPEN DEVICE
$R_{F}$	RELAY INDIVIDUALLY ADDRESSABLE MODULE FOR FIRE ALARM
EOL	OF LINE RESISTOR
ISO	FAULT ISOLATION MODULE
СМ	CONTROL MODULE
MM	MONITOR MODULE

	POWER PLAN SYMBOLS
₩	DUPLEX 5-15R RECEPTACLE
₩	DUPLEX 5-20R RECEPTACLE, T-SLOT
₩	TWO DUPLEX 5-15R RECEPTACLES
J	CEILING MOUNTED JUNCTION BOX AND EQUIPMENT CONNECTION
Ю	WALL MOUNTED JUNCTION BOX AND EQUIPMENT CONNECTION
J	FLOOR MOUNTED JUNCTION BOX AND EQUIPMENT CONNECTION
	PANEL (TYPE AS INDICATED - SECURITY, LIGHTING CONTROL, ETC.)
Ю	WALL MOUNTED DIRECT EQUIPMENT CONNECTION
<u> </u>	SPLITTER
	SURFACE RACEWAY (TYPE AS INDICATED)
•	WAVE TO OPEN PUSHBUTTON
9	MOTOR
<b>ф</b>	MOTOR c/w DISCONNECT SWITCH
ר⊠	COMBINATION DISCONNECT AND MAGNETIC MOTOR STARTER
	DISCONNECT SWITCH
⊠r	FUSED DISCONNECT SWITCH
$\boxtimes$	MAGNETIC MOTOR STARTER
T	THERMOSTAT
<del>r€9-</del> MP	MANUAL MOTOR STARTER c/w PILOT LIGHT
E	CONDUIT STUB
<u> </u>	CONDUIT UP
e	CONDUIT DOWN
<b>₫</b> ₩	DEVICE MOUNTED ABOVE MILLWORK COUNTERTOP
<b>₫</b>	DEVICE MOUNTED WITHIN MILLWORK COUNTERTOP

	LIGHTING PLAN SYMBOLS
	RECESSED LUMINAIRE, 1'x4'
	RECESSED LUMINAIRE, 2'x4'
	RECESSED LUMINAIRE, 2'x2'
$\overline{\mathbf{Z}}$	RECESSED LUMINAIRE / POT LIGHT, 6" DIAMETER OR LARGER
Ø	RECESSED LUMINAIRE / POT LIGHT, LESS THAN 6" DIAMETER
Щ	WALL MOUNTED LUMINAIRE
	LUMINAIRE ON EMERGENCY CIRCUIT (INDICATED BY HALF SHADING)
\$€\$	CEILING MOUNTED EXIT SIGN (TEXT ON SHADED SIDES, ARROWS AS INDICATED)
<b>⊢⊗</b> ↑	WALL MOUNTED EXIT SIGN (TEXT ON SHADED SIDES, ARROWS AS INDICATED)
₩	LINE VOLTAGE SWITCH (120V TO 347V), D- DIMMER SWITCH (0-10V)
€	LOW VOLTAGE SWITCH, D- DIMMER SWITCH (0-10V)
<b>⊕</b> ®	WALL MOUNTED COMBINATION OCCUPANCY SENSOR/LOW VOLTAGE SWITCH, D - DIMMER SWITCH (0 TO 10V
08	CEILING MOUNTED LIGHTING OCCUPANCY SENSOR (TYPE AS INDICATED)
HOS	WALL MOUNTED LIGHTING OCCUPANCY SENSOR (TYPE AS INDICATED)
PC HPC	PHOTOCELL (EXTERIOR, TYPE AS INDICATED)
PC DHPC D	DAYLIGHT SENSOR (INTERIOR PHOTOCELL, TYPE AS INDICATED)
<b>⊕</b> ®	WALL MOUNTED COMBINATION OCCUPANCY SENSOR/LINE VOLTAGE SWITCH
DAC	DALI DAC MODULE (0 - 10V) DALI DIGITAL TO ANALOG CONVERTER (DAC) (0-10v)
OS) PIR	PASSIVE INFRARED OCCUPANCY SENSOR (DALI)
OS <sub>DT</sub>	DUAL TECHNOLOGY OCCUPANCY SENSORS (LOW VOLTAGE)
MS PIR PC	MULTI-SENSOR-PIR OCCUPANCY SENSOR AND DAYLIGHT SENSOR
0	MOMENTARY PUSH BUTTON
OPP	OCCUPANCY SENSOR POWER PACK
4_4	EMERG. LTG. BATTERY PACK (# OF LAMPS AS SHOWN)
	EMERG. LTG. BATTERY PACK
<b>№</b> ∞	CEILING MOUNTED EMERG. LTG. REMOTE HEAD (# OF LAMPS AS SHOWN)
<u> 44</u> Z	WALL MOUNTED EMERG. LTG. REMOTE HEAD (# OF LAMPS AS SHOWN)
4	COMBINATION EXIT SIGN/EMERG. LTG. BATTERY PACK

LIGHT	ING ANNOTATION LEGEND
V-P01:13(a)	— LUMINAIRE TYPE (SCHEDULE REFERENCE) — PANEL — CIRCUIT — SWITCH LEG/ CONTROL ID

	R, LIGHTING, OTHER EQUIPMENT ESIGN (ENERGY)
BC BUILDING CODE:	2018
ELECTRICAL DESIGN:	
ENERGY STANDARD / CODE:	ASHRAE 90.1-2016
POWER COMPLIANCE PATH:	PRESCRIPTIVE
IN ACCORDANCE WITH:	SECTION 8.1.4 (ALTERATIONS TO EXISTING BUILDINGS)
LIGHTING COMPLIANCE PATH:	PRESCRIPTIVE
LIGHTING DESIGN METHOD:	SPACE BY SPACE
IN ACCORDANCE WITH:	SECTION 9 (ALTERNATIONS TO EXISTING BUILDINGS)
OTHER EQUIPMENT PATH:	SECTION 10 (ALTERNATIONS TO EXISTING BUILDINGS)

	DRAWING INDEX
NO.	DRAWING NAME
ELECTRICAL	
E001	COVER PAGE
E010	SYSTEM OVERVIEW
E100	POWER AND SYSTEMS FLOOR PLAN - PHARMACY
E101	POWER & SYSTEMS FLOOR PLAN - ROOF PLANS
E200	LIGHTING PLAN - PHARMACY
E300	PANEL SCHEDULES
E301	LUMINAIRE AND MECHANICAL SCHEDULES
E400	ELECTRICAL DETAILS

#### **GENERAL NOTES**

- DO NOT SCALE THE DRAWINGS. OBTAIN ACCURATE DIMENSIONS FROM THE ARCHITECTURAL AND STRUCTURAL DRAWINGS.
- 2. CONTRACTOR SHALL COMPLETE A DETAILED REVIEW OF THE ARCHITECTURAL DRAWINGS TO COORDINATE INSTALLATION OF FEEDERS AND DEVICE FEEDS INTO THE BUILDING STRUCTURE.
- 3. CONTRACTOR SHALL COMPLETE A DETAILED REVIEW OF THE ARCHITECTURAL DRAWINGS TO COORDINATE INSTALLATION OF FEEDERS AND DEVICES FEEDS INTO THE BUILDING STRUCTURE.
- 4. WORK SHALL BE IN ACCORDANCE WITH THE DRAWINGS AND THEIR INTENT. WORK SHALL INCLUDE THE PROVISION FOR BUT NOT LIMITED TO ALL MATERIALS, LABOUR, TOOLS, EQUIPMENT AND SERVICES REQUIRED FOR CONSTRUCTING, INSTALLING AND PUTTING INTO REGULAR OPERATION THE COMPLETE ELECTRICAL SYSTEM AS SHOWN ON THE DRAWINGS AND AS SPECIFIED IN THIS DOCUMENT.
- 5. CONTRACTOR SHALL REFER TO ARCHITECTURAL DRAWINGS FOR LOCATIONS OF ALL EXPOSED TO VIEW DEVICES, LIGHTING AND EQUIPMENT. EXAMINE AND BRING DISCREPANCIES TO THE ATTENTION OF THE ARCHITECT BY WRITTEN NOTICE FOR CLARIFICATION.
- 6. NOT ALL SYMBOLS INDICATED IN THE SYMBOL SCHEDULES ARE USED IN THE DRAWINGS.

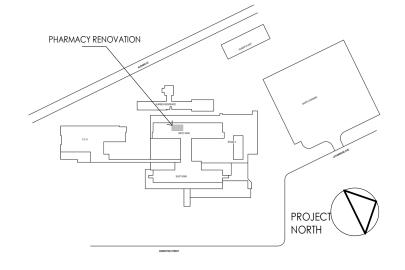


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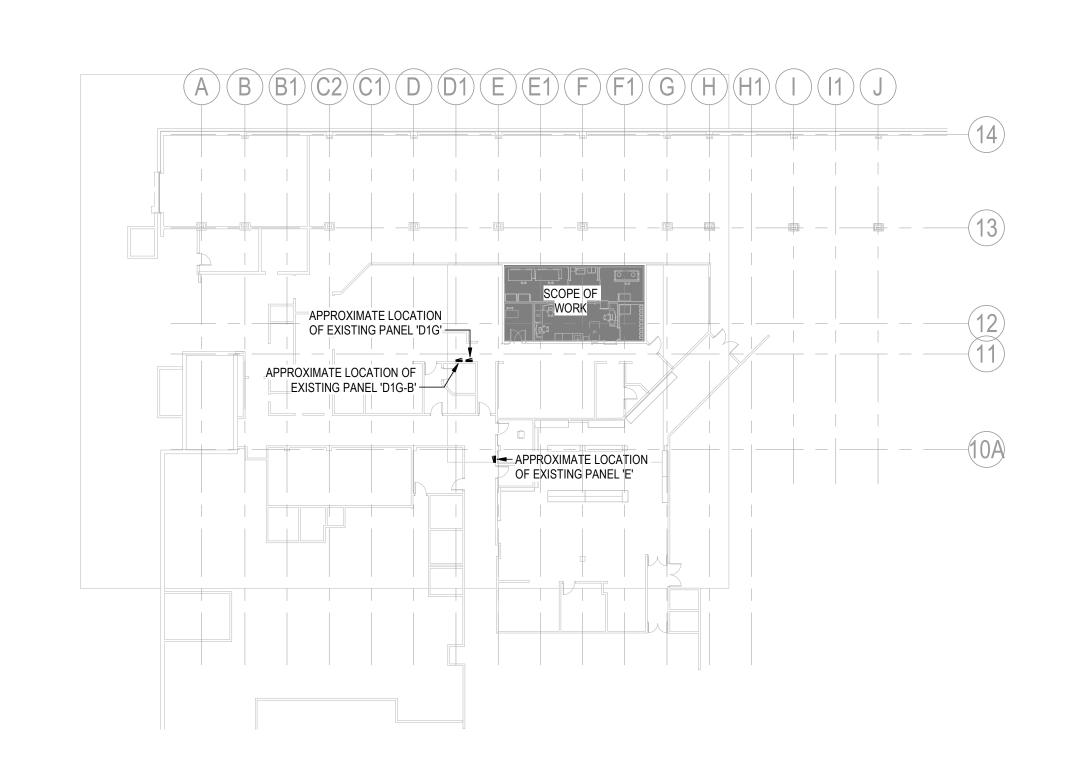
COVER PAGE

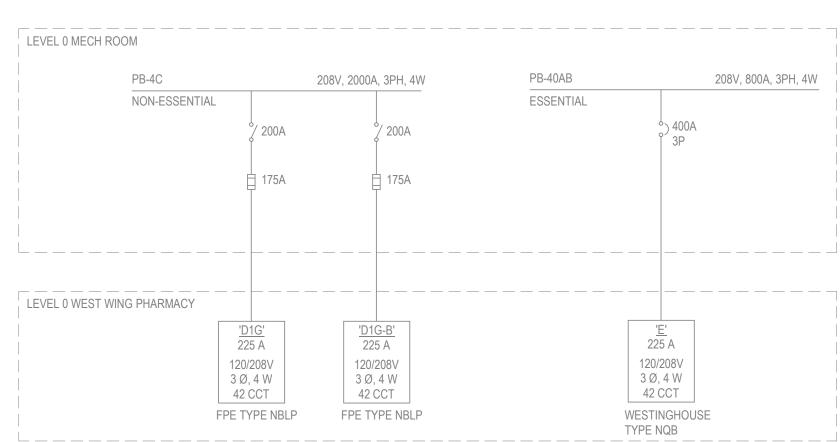
Scale Project No. 144320228

Revision

Drawing No.

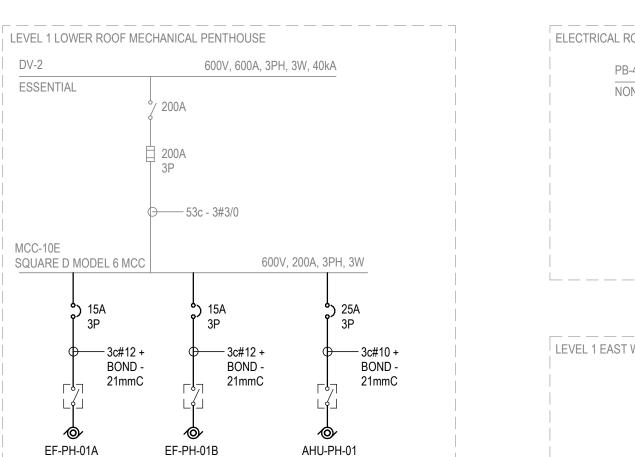
N.T.S



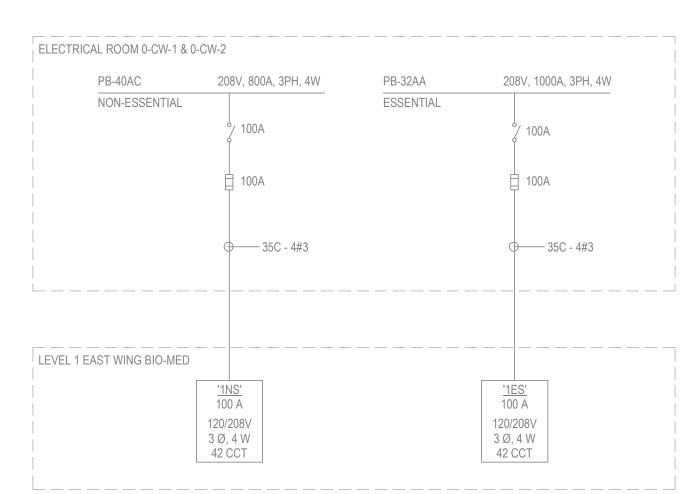


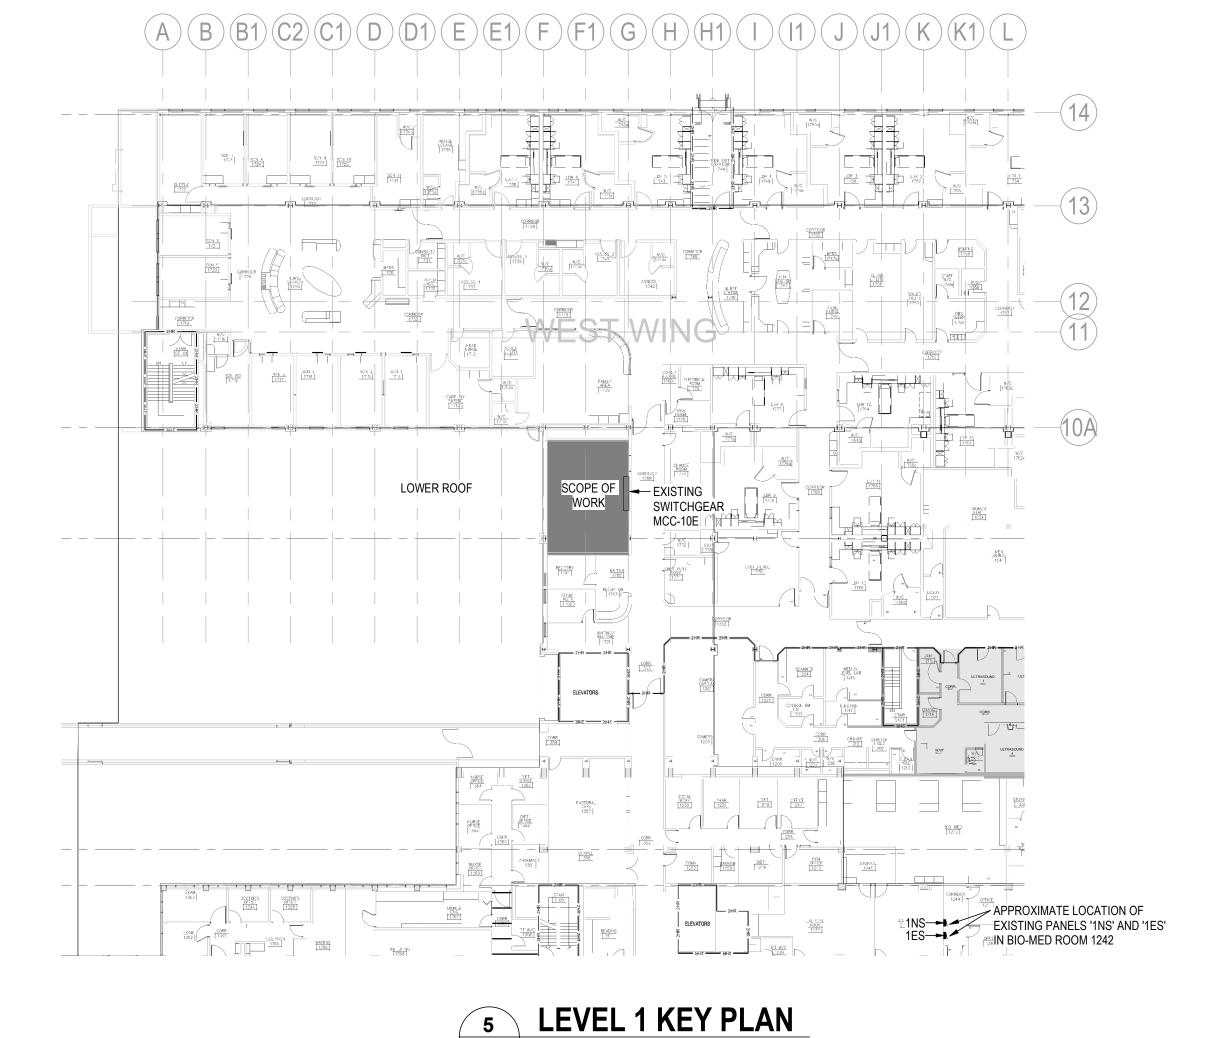
LEVEL 0 KEY PLAN

**1** E010

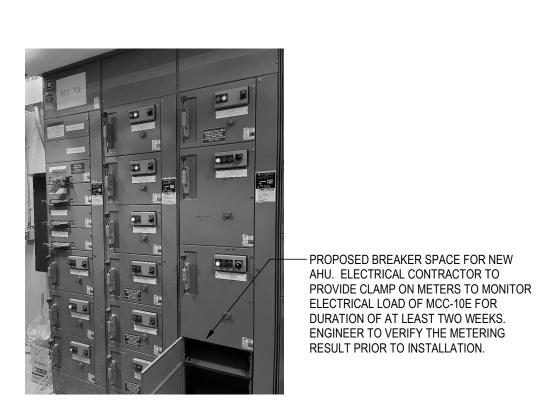


ORIGINAL SHEET - ARCH D

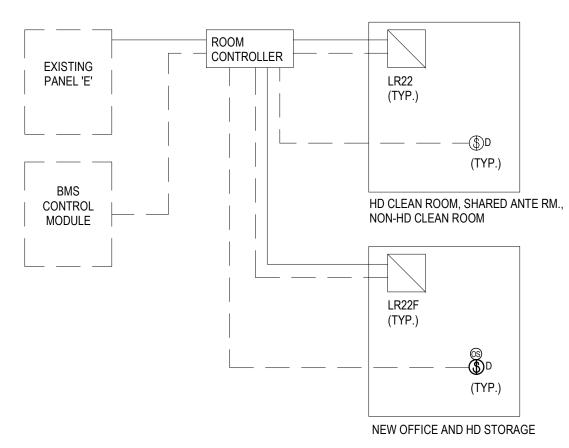




E010 1:300







LINE VOLTAGE WIRING

LOW VOLTAGE WIRING

NOTES:
1. PROVIDE ROOM CONTROLLER AND LIGHTING CONTROL DEVICES TO MATCH EXISTING LIGHTING CONTROL SYSTEM (RELIABLE CONTROLS).

2. LIGHTING CONTROL BEHAVIOUR:

 a. NEW OFFICE AND HD STORAGE: ALL LIGHTING FIXTURES TO BE MANUAL ON, DIMMABLE AND AUTO OFF UPON 15 MINS OF INACTIVITY.
 b. HD CLEAN ROOM, SHARED ANTE RM AND NON-HD CLEAN ROOM: ALL LIGHTING FIXTURES TO BE MANUAL ON AND OFF AND DIMMABLE.



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SYSTEM OVERVIEW

NAPRA Pharmacy Renovation

UHNBC (University Hospital of Northern BC)-

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LIGHTING CONTROL WIRING DIAGRAM

N.T.S

PARTIAL EXISTING SINGLE LINE DIAGRAM
N.T.S

Revision **A** 

Project No.

144320228

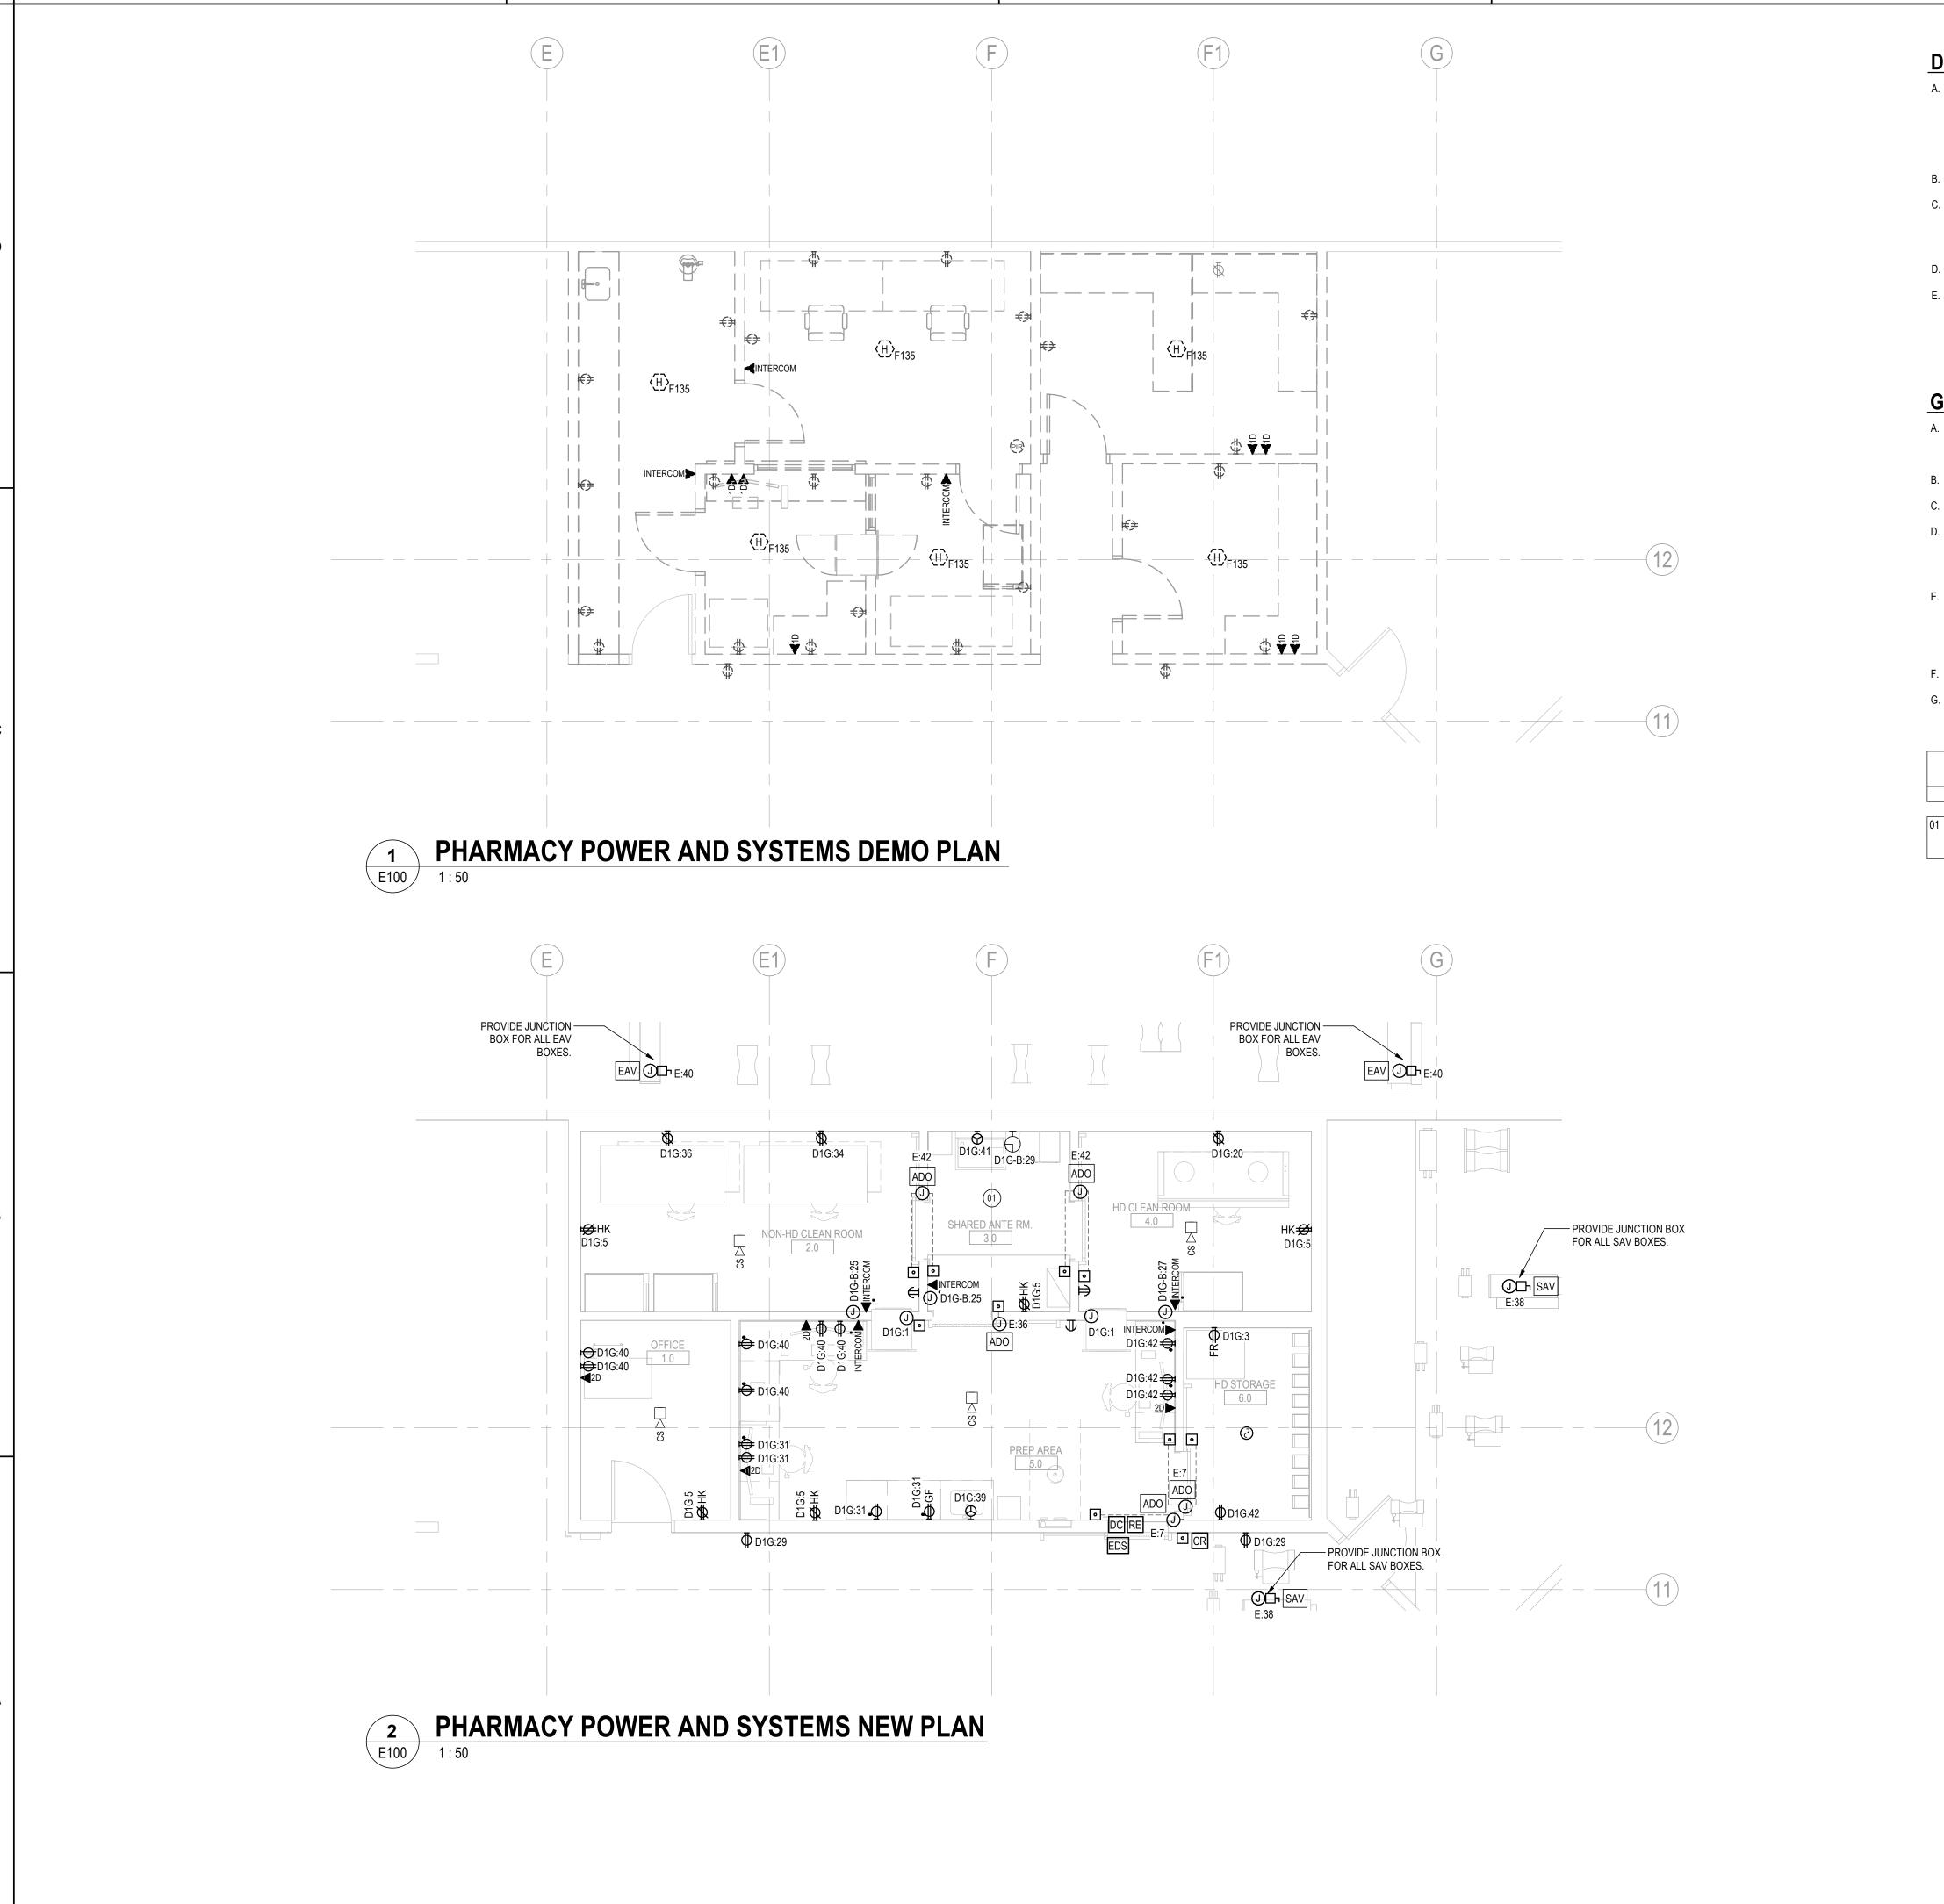
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ORIGINAL SHEET - ARCH D

#### **DEMOLITION NOTES**

- A. THE INFORMATION ON EXISTING DEVICES AND EQUIPMENT PROVIDED ON THIS DRAWING IS A COMPILATION OF DATA FROM EXISTING DRAWINGS AND SITE INVESTIGATIONS. THE CONTRACTOR IS REQUIRED TO REVIEW THE EXISTING SITE CONDITIONS AND DETERMINE THE EXTENT OF DEMOLITION REQUIRED PRIOR TO SUBMITTING A PRICE. EXISTING DEVICES NOT SHOWN BUT REQUIRING REMOVAL WILL BE REMOVED AT NO ADDITIONAL COST TO THE OWNER. DEVICES NOT NOTED THAT REQUIRE REMOVAL OR RELOCATION WILL BE ASSESSED ON SITE DURING CONSTRUCTION AT NO ADDITIONAL COST TO THE OWNER.
- B. GENERAL ELECTRICAL: UNLESS OTHERWISE NOTED AS 'EX' OR 'RL' ON THE PLANS, ALL EXISTING ELECTRICAL EQUIPMENT ON WALLS/CEILINGS TO BE DEMOLISHED.
- C. REMOVE ANY REDUNDANT RACEWAY/WIRING AND CORRECT ANY NON-COMPLIANT INSTALLATIONS. IN THE CASE OF UNSEEN SITE CONDITIONS REGARDING HIDDEN NON-COMPLIANT INSTALLATIONS FROM THE PAST, CONTRACTOR TO IMMEDIATELY BRING THE EXTENT OF WORK TO THE ATTENTION OF THE CONSTRUCTION MANAGER FOR REVIEW AND TO DETERMINE THE PROCEDURE FOR CORRECTING THE INSTALLATIONS.
- D. THE OWNER HAS THE RIGHT TO FIRST REFUSAL FOR ALL REMOVED EQUIPMENT (LIGHTS, PLUGS, ETC...). ALL REMOVED EQUIPMENT NOT CLAIMED BY THE OWNER IS TO BE DISPOSED OF BY THE CONTRACTOR.
- E. UPDATE PANEL SCHEDULE TO REFLECT ADDITIONAL CIRCUIT REQUIREMENTS. FIELD CHECK & CONFIRM AVAILABLE SPACE & SPARE CIRCUITS.

#### **GENERAL NOTES**

- A. COORDINATE ALL WORK WITH ARCHITECTURAL, INTERIOR DESIGN AND MECHANICAL DISCIPLINE DRAWINGS AND COORDINATE ALL WORK WITH ASSOCIATED TRADES. REFER TO INTERIOR DESIGN DRAWINGS FOR MOUNTING HEIGHTS OF ALL DEVICES, AND INSTALLATION REQUIREMENTS IN OR NEAR MILLWORK.
- B. REFER TO ARCHITECTURAL DRAWINGS FOR FIRE-RATED WALL/FLOOR PENETRATIONS DETAILS. FIRESTOP ALL WALL AND FLOOR PENETRATIONS AS REQUIRED.
- C. ALL POWER CONDUCTORS SHALL BE SIZED AS REQUIRED TO LIMIT VOLTAGE DROP TO A MAXIMUM OF
- D. RETAIN A QUALIFIED PROFESSIONAL STRUCTURAL ENGINEER REGISTERED IN THE PROVINCE OF BRITISH COLUMBIA TO DESIGN AND REVIEW SEISMIC RESTRAINTS FOR ALL WORK ASSOCIATED WITH DIVISION 26 (LUMINAIRES, CONDUIT SUPPORTS, ETC.). THE STRUCTURAL ENGINEER SHALL DESIGN, REVIEW/SUPERVISE THE INSTALLATIONS AND SUBMIT THE LETTERS OF ASSURANCE (SCHEDULES 'S-B' AND 'S-C') TO THE ELECTRICAL ENGINEER.
- E. PROVIDE NEW BREAKERS IN EXISTING PANELS AS REQUIRED TO ACCOMMODATE NEW LOADS. REFER TO ELECTRICAL PANEL SCHEDULES AND SINGLE LINE DIAGRAM. CIRCUITS SHOWN INDICATE THE REQUIRED CIRCUITING ARRANGEMENT. DO NOT DEVIATE FROM THE CIRCUITING GROUPING AS SHOWN. SHOW ALL CIRCUIT NUMBERS USED ON RECORD DRAWINGS. CONNECT A MAXIMUM OF THREE (3) WORK STATION OUTLETS PER 15A CIRCUIT AND SIX (6) CONVENIENCE OUTLETS PER 15A CIRCUIT.
- PROVIDE TYPE-WRITTEN PANEL SCHEDULES UPON PROJECT COMPLETION.

  F. PERFORM FIRE ALARM RE-VERIFICATION AT END OF PROJECT COMPLETE WITH AUDIBILITY LEVELS OF
- EACH DEVICE AND AMBIENT AUDIBILITY IN CORRESPONDENCE WITH THE ULC \$537 STANDARD.

  G. PROVIDE PROPER SEALING INSTALLATION ON ELECTRICAL WIRING DEVICES IN HAZARDOUS AREA.

	KEYNOTE LEGEND											
Key Value	Keynote Text											
)1	PROVIDE ADO CAM MOUNTED UNIT SWITCH (BY ADO VENDOR) AT EACH DOOR IN SHARED ANTEROOM TO BE USED AS INTERLOCK SIGNAL TO RESTRICT OTHER DOORS.											

TO OPEN UNLESS DOOR IS FULLY CLOSED.



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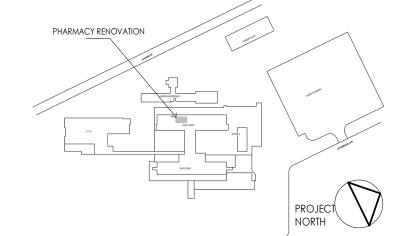
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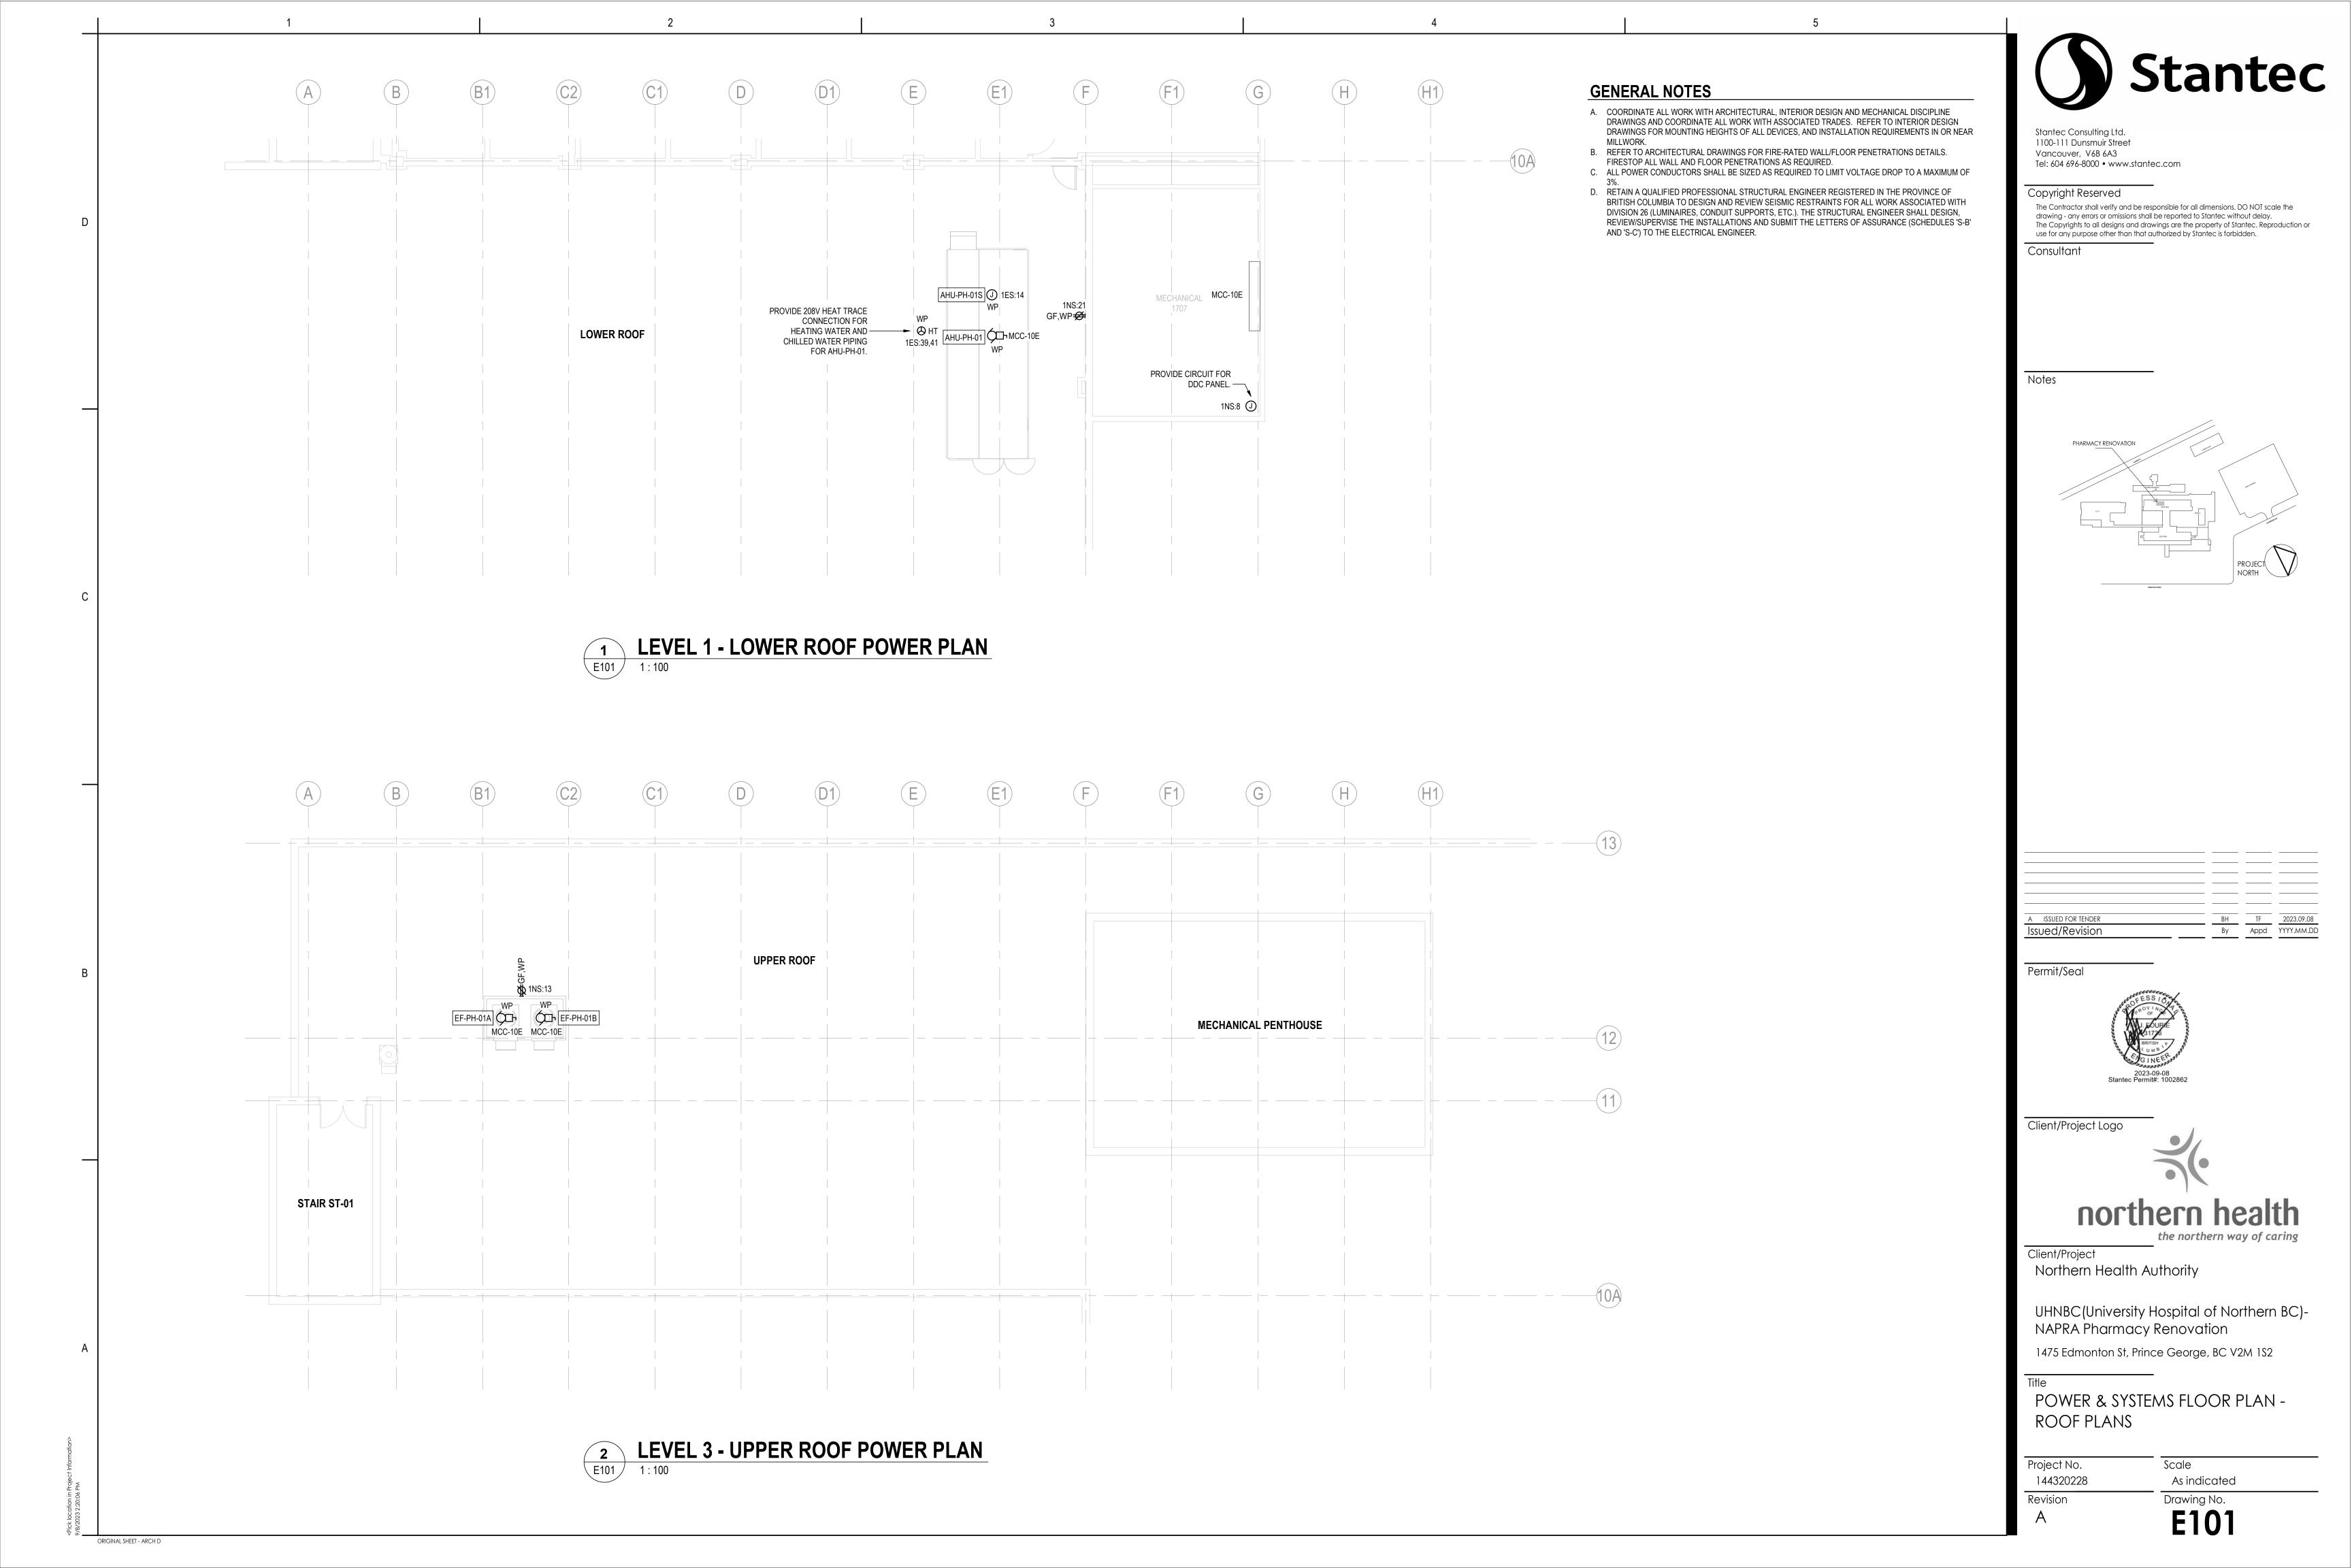
POWER AND SYSTEMS FLOOR PLAN - PHARMACY

Project No. 144320228

Revision

Scale
As indicated
Drawing No.

E100



T----†\_\_\_\_\_ †----<u>-</u> r\_\_\_\_\_\_ <u>\_\_\_\_\_</u> !-----PHARMACY LIGHTING DEMO PLAN PHARMACY LIGHTING NEW PLAN E200

**DEMOLITION NOTES** 

- A. THE INFORMATION ON EXISTING DEVICES AND EQUIPMENT PROVIDED ON THIS DRAWING IS A COMPILATION OF DATA FROM EXISTING DRAWINGS AND SITE INVESTIGATIONS. THE CONTRACTOR IS REQUIRED TO REVIEW THE EXISTING SITE CONDITIONS AND DETERMINE THE EXTENT OF DEMOLITION REQUIRED PRIOR TO SUBMITTING A PRICE. EXISTING DEVICES NOT SHOWN BUT REQUIRING REMOVAL WILL BE REMOVED AT NO ADDITIONAL COST TO THE OWNER. DEVICES NOT NOTED THAT REQUIRE REMOVAL OR RELOCATION WILL BE ASSESSED ON SITE DURING CONSTRUCTION AT NO ADDITIONAL COST TO THE OWNER.
- B. GENERAL ELECTRICAL: UNLESS OTHERWISE NOTED AS 'EX' OR 'RL' ON THE PLANS, ALL EXISTING ELECTRICAL EQUIPMENT ON WALLS/CEILINGS TO BE DEMOLISHED.
- C. REMOVE ANY REDUNDANT RACEWAY/WIRING AND CORRECT ANY NON-COMPLIANT INSTALLATIONS. IN THE CASE OF UNSEEN SITE CONDITIONS REGARDING HIDDEN NON-COMPLIANT INSTALLATIONS FROM THE PAST, CONTRACTOR TO IMMEDIATELY BRING THE EXTENT OF WORK TO THE ATTENTION OF THE CONSTRUCTION MANAGER FOR REVIEW AND TO DETERMINE THE PROCEDURE FOR CORRECTING THE
- D. THE OWNER HAS THE RIGHT TO FIRST REFUSAL FOR ALL REMOVED EQUIPMENT (LIGHTS, PLUGS, ETC...). ALL REMOVED EQUIPMENT NOT CLAIMED BY THE OWNER IS TO BE DISPOSED OF BY THE CONTRACTOR.
- E. UPDATE PANEL SCHEDULE TO REFLECT ADDITIONAL CIRCUIT REQUIREMENTS. FIELD CHECK & CONFIRM AVAILABLE SPACE & SPARE CIRCUITS.
- F. LIGHTING DEMO PHASING PLAN. REFER TO ARCHITECTURAL DRAWINGS FOR EXACT PHASING PLAN FOR WALLS AND CEILINGS. COORDINATE WITH CONTRACTORS FROM OTHER DISCIPLINE TO MAKE A COMPLETE AND OPERABLE SYSTEM DURING TEMP. PHASES:
- a. PHASE I: REMOVE ALL EXISTING LIGHTING FIXTURES, EXIT SIGNS AND LIGHTING SWITCHES AS INDICATED IN THE DRAWINGS.
- b. PHASE II: PROVIDE LIGHTING FIXTURES AND SWITCHES AS INDICATED IN THE DRAWINGS. c. PHASE III: REMOVE THE GASKET FIXTURES 'F1' IN TEMP MIXING ROOM AND ANTE ROOM CAREFULLY AND REUSE THEM IN THE NEW PHARMACY. PROVIDE FIXTURE TYPE 'F2' IN THE OFFICE AFTER THE TEMP. WALLS ARE REMOVED.

#### **GENERAL NOTES**

- 1. COORDINATE ALL WORK WITH THE TRADES (MECHANICAL, FIRE PROTECTION, ARCHITECTURAL,
- INTERIOR DESIGN, ETC.) ON SITE. 2. REFER TO ARCHITECTURAL DRAWINGS FOR FIRE-RATED WALL/FLOOR PENETRATIONS DETAILS.
- FIRESTOP ANY PENETRATIONS MADE THROUGH FIRE SEPARATIONS.
- 3. ALL LIGHTING CONDUCTORS SHALL BE SIZED AS REQUIRED TO LIMIT VOLTAGE DROP TO A MAXIMUM OF 4. RETAIN A QUALIFIED PROFESSIONAL STRUCTURAL ENGINEER REGISTERED IN THE
- PROVINCE OF BRITISH COLUMBIA TO DESIGN AND REVIEW SEISMIC RESTRAINTS FOR ALL WORK ASSOCIATED WITH DIVISION 26 (LUMINAIRES, CONDUIT SUPPORTS, ETC.). THE STRUCTURAL ENGINEER SHALL DESIGN, REVIEW/SUPERVISE THE INSTALLATIONS AND SUBMIT THE LETTERS OF ASSURANCE (SCHEDULES 'S-B' AND 'S-C') TO THE ELECTRICAL ENGINEER.
- 5. ALL MOUNTING HEIGHTS SHALL BE MEASURED FROM ABOVE FINISHED FLOOR TO THE BOTTOM OF THE
- 6. ALL EXISTING DEVICES ARE SHOWN IN APPROXIMATE LOCATIONS. CONTRACTOR SHALL VERIFY EXACT LOCATIONS AS REQUIRED. WHERE FIRE ALARM SPEAKERS OR EXIT SIGNS WILL BE OBSCURED BY THE NEW CIRCULAR CEILING PANELS, OR NEW WALLS, DOORS, PARTITIONS, OR ANY OTHER NEW STRUCTURES, THESE FIRE ALARM SPEAKERS AND EXIT SIGNS SHALL BE RELOCATED TO A LOCATION AS NEAR TO THE ORIGINAL LOCATION AS POSSIBLE BUT WITHOUT BEING OBSCURED BY THE NEW
- 7. LIGHTING CONTROL DEVICES ARE SHOWN DIAGRAMMATICALLY TO SHOW DESIGN INTENT. ZONES DENOTING NUMBER OF RELAYS REQUIRED ON LIGHTING CONTROL DEVICES ARE SHOWN VIA LETTERS ADJACENT TO DEVICE ON PLAN. LETTERS NEXT TO LUMINAIRES DENOTE THEY ARE CONTROLLED BY THE DEVICE. WHERE DIMMERS ARE SHOWN TO PROVIDE CONTROL TO MORE THAN ONE ZONE, EACH ZONE SHALL HAVE ITS OWN DIMMER. WHEN OCCUPANCY/DAYLIGHT SENSOR IS SHOWN CONTRACTOR SHALL COORDINATE ON SITE AND WITH MANUFACTURERS RECOMMENDATIONS FOR PLACEMENT OF THE SENSOR TO ACHIEVE DESIGN INTENT. IF REQUIRED, LARGE ROOM OR ROOMS WITH ABNORMAL LAYOUTS SHALL HAVE MORE THAN ONE OCCUPANCY SENSOR.

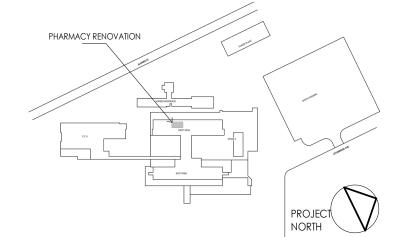


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LIGHTING PLAN - PHARMACY

Project No. 144320228

Revision

Scale As indicated

Drawing No. **E200** 

Name: E Volts: 208Y/120V Mains Type: MLO Type: Location: Phases: 3 Mains... 225 A AIC Rating: Supply... Wires: 4 Max Rating: 200 A Mounting: Surface Enclosure: Type 1 Lugs: Single Lugs Serves: **Trip s CB A**15 A 1 -- 0 0 Circuit Description Circuit Description 1 LIGHTS CORRIDOR -- 1 15 A ESSENTIAL LIGHTS 3 LIGHTS CORRIDOR 15 A HEAT TAPE GRBG RM. DOCK LGT 15 A UPRIGHT FRIDGE PLUG IN CORR 5 ESSENTIAL LIGHTS ADO HD STORAGE/PREP AREA 15 A WASHROOM LIGHTS SANIPAR MEAT TAPE 15 A SPD CHANGE ROOM 1 15 A LIGHT LOADING DOOR 1 15 A CORRIDOR LIGHTS 3 70 A PANEL EE LIGHTING PHARMACY FRIDGE PLUG PHARMACY 15 A LTG STORAGE ROOM & PHARM FRIDGE PLUG PHARMACY 15 A SOILED LAUNDRY LIGHTS FRIDGE PLUG PHARMACY 15 A SOILED LAUNDRY LIGHTS 15 A PIXIS & PREPACK PLUG 15 A FASTPAK EQUIP 15 A FAX MACHINE WORK STATION 15 A ADO PREP SPACE/ANTE RM 7 DISPENSARY PLUGS 1 15 A SAV BOXES 39 PRE-PACK NARCOTICS PLUGS 1 15 A EAV BOXES 41 DOE PRINTERS X3 1 15 A ADO CLEAN ROOMS Total Load: 0.24 kVA 0.87 kVA 0.00 kVA Total Amps: 2 A 8 A 0 A Load Classification Connected Load **Demand Factor** Estimated Demand Panel Totals 125.00% 784 VA 480 VA 100.00% 480 VA Total Conn. Load: 1107 VA Total Est. Demand: 1264 VA Total Conn.: 3 A Total Est. Demand: 4 A CB Legend (blank = circuit breaker): G = GFCI S = Shunt Trip D = Switching Duty A = AFCI H = HID Rated C = HACR Rated † = Existing Circuit ‡ = Revised Circuit

Stant	ec													Panel						
	Name: D1G			,	Volts: 208	Y/120V		Mains Typ	oe: MLO			Туре:								
Lo	cation:			Ph	ases: 3			Mains	s 225 A			AIC Rating:								
ł	upply			V	Vires: 4				ng: 200 A			Mounting: Surface								
ł				v	VIICS. T				•	1100		_								
ł	Serves:							Lu(	gs: Single L	Lugs		Enclosure: Type 1								
Notes	<b>:</b>																			
			Pole									Pole								
СКТ	Circuit Description	Trip		СВ		A	E	3			СВ		Trip	Circ	uit Description	CK				
1	PASS-THROUGHS	15 A	1		0	0						1	15 A	PLUGS BULK	RM, ENTRANCE	2				
3	FRIDGE STORAGE ROOM	15 A	1				600	0				1	15 A	STRG, COUN	TER PLUG PRE-PACK	4				
5	HK RECEPT PHARMACY	20 A	1						1500	0	-	1			UGS PRE PACK RM	6				
7	STRG, COUNTER RCPT PRE-PACK	15 A	1		0	0						1	15 A	PLUGS IN DIS	SPENSARY CORNER	8				
9	HALL AND COUNTER RCPT ANTE	15 A	1				0	0				1	15 A	COUNTER PL	UG NARCOTICS	10				
11	LTG M11,M12,M15,M16,M17,M19,M20	15 A							0	0	-	1			UG PRE-PACK RM	12				
13	LIGHTS M1,M2,M3,M13,M6,M7	15 A	1		0	0						1	15 A	PLUGS WAIT	NG, COUNSELING	14				
15	LIGHTS IN M2,M3,M5,M8,M18	15 A	1				0	0				1	15 A	PLUG ON DIS	PENSARY COUNTER	16				
17	LOCKER RM PLUGS, PHARMACY	15 A	1						0 0		-	1	20 A	PLUGS IN DIS	SPENSARY, COUNTER	18				
19	TELEPHONE POLES	15 A	1		0	300						1	20 A	HD CLEAN RO	DOM HOOD	20				
21	WALL RECEPTION PLUGS	15 A	1				0	0				1	15 A	PHOTO COPY	PLUG IN RECEPTION	22				
23	MW, OFFICE WORKSTATION	15 A	1						0	0		1	15 A	COUNTER PL	UGS IN RECEPTION	24				
25	DED-KITCHEN COUNTER	15 A	1		0	0						1	15 A	FRIDGE		26				
27	DED-KITCHEN COUNTER	15 A	1				0	0				1	15 A	WORKSTATIO	ON PLUG, OFFICE	28				
29	RECEPTACLES HALLWAY	15 A	1						360	0		1	15 A	WORKSTATIO	N PLUG, OFFICE	30				
31	WORKSTATION/COUNTER RCPT	15 A	1		720	0						1	15 A	PLUGS DRUG	INFO, OFFICE	32				
33	SPARE	15 A	3				0	300				1	20 A	NON HD CLE	AN ROOM HOOD	34				
35									0	300		1	20 A	NON HD CLE	AN ROOM HOOD	36				
37					0	0						1	20 A	SPARE		38				
39	PHARMACY SINK	15 A	1				500	1080				1			ON RECEPTACLES	40				
41	SHARED ANTE RM SINK	15 A	_						500	720		1			N/STRG RECEPT	42				
			-	Load:	1.02	kVA	2.48	kVA	3.38	kVA										
				Amps:		A		3 A	30											
Load	Classification				Connect	ed Load	Demand	d Factor	Estimate	d Demand	I			Panel	Totals					
Other					0 V	/A	0.0	0%	0	VA										
Rece	otacle				3700	VA	100.	00%	370	00 VA			Tota	l Conn. Load:	6880 VA					
Rece	otacle (V)				2400	VA	100.	00%	240	00 VA			Total	Est. Demand:	6880 VA					
Rece	otacle GFCI		780	VA	100.	00%	780	0 VA		19 A										
													Total	Est. Demand:	19 A					
l	egend (blank = circuit breaker):						I		1											
	EOLO OL 171 B C 1111 E 1		FC' .		D	11405 =														
	SFCI S = Shunt Trip D = Switching Duty	A = A	FCI H	H = HID	Rated C =	HACR Ra	ated †= Ex	isting Circu	uit ‡= Revi	sed Circuit										

I	Name: D1G-B				Volts: 208	Y/120V		Mains Type	: MLO		Type:									
Lo	cation:			Ph	ases: 3			Mains	225 A			AIC	Ratin	g:						
Su	ıpply			١	Vires: 4			Max Rating					ountin							
	Serves:							Lugs	: Single	: Single Lugs			Enclosure: Type 1							
Notes	::																			
			Pole									Pole								
CKT	Circuit Description	Trip		СВ		A		В		С	СВ	S	Trip		uit Description					
<u>1</u> 3	LIGHTS GARBAGE ROOM LIGHTS IN PRINT SHOP	15 A 15 A			0	0	0					1	15 A	COOLER IN G	SARBAGE RM. 3					
5	LTG IN HALL STORES, BOTTLE RM.	15 A					0		0	0		1	15 Δ	SPARE						
7	BULK STORE LIGHTS	15 A			0	0						<u> </u>		RECEPT GAR	BAGE ROOM					
9	COMPUTER PLUG IN PRINT 28	15 A					0	0				1		COMPUTER F						
	BULK STORE LIGHTS	15 A							0	0		1		EXHAUST FA						
	OFFICES ACROSS FROM DIETARY	15 A		-	0	0						2		STORES / PA						
	OFFICES ACROSS FROM DIETARY	15 A					0	0						-						
17	OFFICES ACROSS FROM DIETARY	15 A							0	0		1	15 A	UH 310 AND U	JH 311					
	OFFICES ACROSS FROM DIETARY	15 A			0	0						1		UH 3105 AND						
	OFFICES ACROSS FROM DIETARY	15 A					0													
23	OFFICES ACROSS FROM DIETARY	15 A							0	0		1	15 A	LTG IN HWAY	STRG/BOTTL					
5	INTERCOMS RM 2,3	15 A			0															
7	INTERCOM RM 4	15 A					0													
9	POWER	15 A	1						0											
1_		1																		
33																				
35		1																		
37		1																		
39 41			-																	
41			Total	⊥ I Load:	0.00	) kVA	0.00	0 kVA	0.00	) kVA										
				Amps:		) A		0 A		) A										
oad	Classification		Total	Amps.	l	ted Load				ed Demand				Panel	 Totals					
)ther						VA		00%		) VA										
owe						VA		00%		) VA			Tota	l Conn. Load:	0 VA					
													Total	Est. Demand:	0 VA					
														Total Conn.:	0 A					
													Total	Est. Demand:	0 A					
B Le	egend (blank = circuit breaker):																			
G = G	FCI S = Shunt Trip D = Switching Duty	A = A	FCI H	H = HID	Rated C	= HACR Ra	ted † = E:	xisting Circuit	‡ = Rev	ised Circuit										
Notes																				
110163																				
110163																				
110103																				
10163																				

Stant	ec										Panel										
	Name: 1NS			,	/olts: 208	//120V		Mains Typ	e: MLO				Тур	e:							
Lo	cation:			Ph	ases: 3			Mains	s 100 A			AIC Rating:									
Sı	ıpply			٧	Vires: 4			Max Ratir	ng: 100 A		Mounting: Surface										
	Serves:								s: Single	Luas	Enclosure: Type 1										
Notes								,	3-		Endodaid. Type i										
СКТ	Circuit Description	Trip	Pole s	СВ		<b>A</b>		В		С	СВ	Pole s	Trip	Circ	uit Description	СКТ					
1	LIGHTING-CORRIDOR	15 A	1		0	0						1		RECEPTACLE	-	2					
3	LIGHTING	20 A	1				0	0				1	15 A	RECEPTACLE	S-OFFICE 1247/1248	4					
5	LTG-EXERCISE AND EDUCATION	20 A	1	-					0	0		1	15 A	RECEPTACLE	S-OFFICE 1246/1249	6					
7	LIGHTING-CAST AREA	15 A	1		0	804						1	15 A	DDC PANEL (	CIRCUIT	8					
9	RECEPT-MARVIN BARG'S OFFICE	15 A					0	0				1	15 A	RECEPTACLE	ES-1242	10					
11	RECEPTACLE-BIOMED	15 A	1						0	0		1	15 A	RECEPTACLE	ES-1242	12					
	SERVICE RECEPTACLE EF-PH-01	20 A			300	0						1		RECEPTACLE		14					
	RECEPTACLE, COLUMN, CEILING	15 A					0	0				1		RECEPTACLE		16					
	RECEPTACLES - ELECTRIC BED	15 A							0	0		1		RECEPTACLE		18					
	RECEPTACLES - ELECTRIC BED	15 A			0	0						1		RECEPTACLE		20					
	SERVICE RECEPTACLE AHU-PH-01	20 A					300	0				1			ES-1242/1238/1237	22					
23	SU CAST	15 A							0	0		1		RECEPTACLE		24					
25	208V/20A WIREMOLD REC.	20 A	2		0	0						1			S-EDUCATION ROOM	26					
27							0	0				1			ES-EDUCATION ROOM	28					
	PREAMIN	15 A		-	_	_			0	0		1			S-EXERCISE ROOM	30					
	PREAMIN	15 A		-	0	0						1			S-EXERCISE ROOM	32					
33	UNDER CABINET REC. BAR 5	15 A		-			0	0				1			S-EXERCISE ROOM	34					
35	20A/220V REC. COLUMN	15 A	<b>+</b>	-					0	0		1		RECEPTACLE		36					
37				-	0	0						1		RECEPTACLE		38					
	UNDER CABINET REC. BAR 5	15 A					0	0				1			H BIO MED XRAY	40					
41	RECEPTACLES - CORRIDOR	20 A							0	0		1	20 A	RECEPTACLE	ES-CORRIDOR	42					
			Tota	Load:		kVA		kVA	0.00	kVA											
		•	Total	Amps:	10	Α	3	Α	0	Α											
Load	Classification				Connect	ed Load	Deman	d Factor	Estimate	ed Demand				Panel	Totals						
Other					804	VA	100	.00%	80	4 VA											
	otacle (V)				600			.00%		0 VA			Tota	l Conn. Load:	1404 VA						
1 1000	oudio (V)					***	100	.0070	-					Est. Demand:							
													TOLAI								
														Total Conn.:							
													Total	Est. Demand:	4 A						
CR I	egend (blank = circuit breaker):						<u> </u>		1												
	GFCI S = Shunt Trip D = Switching Duty	۸ – ۸	ברו ו	1 – חוע	Patod C -	- HACD Da	tod + - Ev	rictina Circ	it + - Dov	icad Circuit											
		A - A	rui i	חוח – ו	rated C=	- паск ка	ıeu   − Ex	isting Circl	iir + - Kev	iseu Oilcult											
Notes	S:																				

Loc Sup	valame: 1ES eation: pply erves:	Pha	/olts: 208 ases: 3 /ires: 4	3Y/12UV		Max Ratir	oe: MLO s 100 A ng: 100 A gs: Single	Luas		М	Typ Ratin ountin closur					
Notes:					Lu	jo. Giligio	_ago			olooui	o. 1900 1					
CKT	Circuit Description	Trip	Pole s	СВ		A		В		СВ	Pole s	Trip	Circ	uit Description	СКТ	
1	LIGHTING - EXIT	15 A	1		0	0						1	15 A	RECEPTACLE	S - 1242	2
	LIGHTING - CORRIDOR	15 A					0	0				1		RECEPTACLE		4
	LIGHTING - CAST ROOM	15 A							0	0		1		RECEPTACLE		6
	SPARE	15 A			0	0						1			S - 1247 & 1242	8
	RECEPTACLES - 1236	15 A					0	0				1		RECEPTACLE		10
	RECEPTACLES - 1236	15 A			_	_			0	0		1		RECEPTACLE	ES - 1249	12
	RECEPTACLES - CAST BEDS	15 A			0	0						1		AHU-PH-01S		14
	RECEPTACLES - CAST BEDS	15 A					0	0				1		RECEPTACLE		16
	RECEPTACLES - CAST BEDS	15 A							0	0		1	15 A	RECEPTACLE	-S - 1252	18
	RECEPTACLES - CAST BEDS	15 A			0							4	45.4	MOAD		20
	RECEPTS - NURSE STATION CAST	15 A					0	0	0			1		MGAP		22
	RECEPTS - NURSE STATION CAST	15 A			0				0	0		1	15 A	EF-415		24
	RECEPTACLES - CAST AREA	15 A			0		0	0				1	1E A	DECEDIACI	C 1011	26
	NURSE CALL PANELS	15 A					0	0	0	0		1		RECEPTACLE		28
	NURSE CALL PANELS LIGHTING - NORTH STAIRWELL	15 A 15 A			0	0			0	0		1		RECEPTACLE EF-416	5 - 1240	30 32
	LIGHTING - NORTH STAIRWELL	15 A			U	U	0	0				3	15 A	EF-410		34
	SPARE	15 A					0	U	0	0						36
	SPARE	15 A	1		0	0						1		EF-415		38
	HEAT TRACE AHU-PH-01	15 A			0		0	0				1		PACK POLE		40
41									0	0		1		PACK POLE		42
71			Total	Load:	0.0	0 kVA	0.00	kVA	-	kVA		'	1071	TAORTOLL		72
				Amps:		0 A		A		A						
	n ::: ::	ı	Olai /	Amps.											<del>-</del>	
	Classification					ted Load		d Factor		ed Demand				Panel	ı otais	
HVAC						VA		00%		VA						
Other					0	VA	0.0	00%	0	VA			Tota	Conn. Load:	0 VA	
													Total	Est. Demand:	0 VA	
														Total Conn.:	0 A	
							1						Total	Est. Demand:		
													. Jui			
	gend (blank = circuit breaker):															
G = GF	FCI S = Shunt Trip D = Switching Duty	A = Al	-CI H	= HID	Rated C	= HACR Ra	ted † = Ex	risting Circu	uit ‡=Rev	ised Circuit						
Notes:	:															

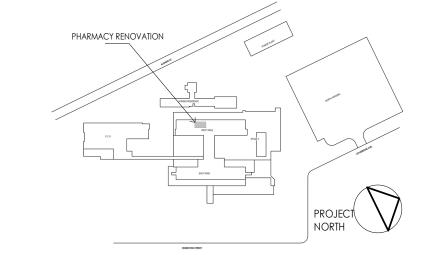


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the northern way of caring

Client/Project Northern Health Authority

UHNBC (University Hospital of Northern BC)-NAPRA Pharmacy Renovation

1475 Edmonton St, Prince George, BC V2M 1S2

PANEL SCHEDULES

Project No. 144320228

Drawing No.

Scale

ORIGINAL SHEET - ARCH D

Revision

E300

**LUMINAIRE SCHEDULE** Remarks Wattage Lumen Output Efficacy CRI Temperature Voltage Manufacturer 2'X4' EXISTING LIGHTING FIXTURE RECESSED 120 V 2'X4' EXISTING LIGHTING FIXTURE RECESSED 120 V 2'X2' | 2'X2' LED RECESSED LIGHT | RECESSED - T-BAR | 37 W | 4300 116 90 3500 120 V FAIL-SAFE ENW-24-2-LD2-43-35-CA08-UNV-ED1D-1-90 SEALED 37 W 4300 116 90 3500 120 V FAIL-SAFE ENC-24-2-LD2-39-35-CA08-UNV-ED1D-1-90-DFCL-2424W-U 2'X2' 2'X2' LED RECESSED LIGHT -RECESSED -**CLEAN ROOM RATED** DRYWALL LR22F

	MECHANICAL EQUIPMENT SCHEDULE																														
											S	TARTI	ER		CONTROLS DISCONNECT																
EQUIPMENT ID	UNIT DESCRIPTION	LOCATION	VOLTAGE (V)	Ф Н2	Z HP	FLA	LOAD	MCA	МОР	GROUPING	TYPE	SUPPLIED	INSTALLED	WIRED	SIZE TVDE(S)	SUPPLIED	INSTALLED WIRED	SUPPLIED	INSTALLED	ACCESSORIES	INTERFACE REQ'D	AUT ON		-		PWR SOURCE TYPE	PANEL	BREAKER	CONDUCTOR SIZE	CONDUIT SIZE	NOTES
AHU-PH-01	PHARMACY AIR HANDLING UNIT	LEVEL 1 LOWER ROOF	600 V	3 60 H	z 0	0.0 A	11200 W	21 A	25 A		VFD	M	M	E	ВА	S M N	<b>И</b> М	E	E	E	No	No	No	No	No	VITAL	MCC-10E	25A/3P	3c#10 + BOND	21mm	
AHU-PH-01S	AHU-PH-01 LIGHT PLUGS CIRCUIT	LEVEL 1 LOWER ROOF	120 V	1 60 H	z 0	0.0 A	1400 W	0 A	0 A						ВА	SM	<b>и</b> М	E	E	Е	No	No	No	No	No	VITAL	1ES	15A/1P	2c#12 + BOND	21mm	
EAV BOX	EXHAUST AIR VALVE BOX CONNECTION	LEVEL 0 PHARMACY	120 V	1 60 H	z 0	1.0 A	120 W	0 A	0 A						ВА	SM	и м	E	E	Е	No	No	No	No	No	VITAL	E	15A/1P	2c#12 + BOND	21mm	
EAV BOX	EXHAUST AIR VALVE BOX CONNECTION	LEVEL 0 PHARMACY	120 V	1 60 H	z 0	1.0 A	120 W	0 A	0 A						ВА	SM	и	E	E	Е	No	No	No	No	No	VITAL	E	15A/1P	2c#12 + BOND	21mm	
EF-PH-01A	HIGH PLUME EXHAUST FAN	LEVEL 3 UPPER ROOF	600 V	3 60 H	z 5	6.1 A	4052 W	15 A	15 A	PCS1	VSD	М	M	E	ВА	S M N	и м	E	E	E	No	No	No	No	No	VITAL	MCC-10E	15A/3P	3c#12+ BOND	21mm	
EF-PH-01B	HIGH PLUME EXHAUST FAN	LEVEL 3 UPPER ROOF	600 V	3 60 H	z 5	6.1 A	4052 W	15 A	15 A	PCS1	VSD	М	M	E	ВА	S M N	и м	E	E	E	No	No	No	No	No	VITAL	MCC-10E	15A/3P	3c#12 + BOND	21mm	
SAV BOX	SUPPLY AIR VALVE BOX CONNECTIONS	LEVEL 0 PHARMACY	120 V	1 60 H	z 0	1.0 A	120 W	0 A	0 A						ВА	SM	ИМ	E	E	E	No	No	No	No	No	VITAL	E	15A/1P	2c#12 + BOND	21mm	
SAV BOX	SUPPLY AIR VALVE BOX CONNECTIONS	LEVEL 0 PHARMACY	120 V	1 60 H	z 0	1.0 A	120 W	0 A	0 A						ВА	SM	ИМ	E	E	E	No	No	No	No	No	VITAL	E	15A/1P	2c#12 + BOND	21mm	

#### **ABBREVIATIONS:**

GENERAL: M MECHANICAL (DIVISIONS 21/22/23/25

ELECTRICAL (DIVISION 26)

FLA FULL LOAD AMPACITY

MCA MINIMUM CIRCUIT AMPACITY MOP MAXIMUM OVERCURRENT PROTECTION DEVICE

BAS BUILDING AUTOMATION SYSTEM

CDP CENTRAL DISTRIBUTION PANEL

FVNR FULL VOLTAGE, NON REVERSING O/C OVERCURRENT O/L OVERLOAD

CONTROLS:

BAS BUILDING AUTOMATION SYSTEM (DDC)
CP SYSTEM CONTROL PANEL (EG IRRIGATION CONTROLLER) ES END SWITCH

FA FIRE ALARM (CONTROL MODULE) FAFS FIRE ALARM (WET SPRINKLER) FLOW SWITCH

FALS FIRE ALARM (SPRINKLER RESERVOIR) LEVEL SWITCH

CACF CENTRAL ALARM & CONTROL FACILITY (FIRE ALARM) FAPS FIRE ALARM (DRY SPRINKLER) PRESSURE SYSTEM FATS FIRE ALARM (SPRINKLER VALVE) TAMPER SWITCH

GS GAS SENSOR

HUMIDISTAT INTERLOCK LEVEL SWITCH

WS WALL SWITCH

TIME CLOCK THERMOSTAT

VARIABLE SPEED SWITCH

RVYD REDUCED VOLTAGE (WYE-DELTA) RVAT REDUCED VOLTAGE (AUTOTRANSFORMER) RVPW REDUCED VOLTAGE (PART WINDING) RVSS REDUCED VOLTAGE (SOFT STARTER) VSD VARIABLE SPEED DRIVE

STARTER TYPE:

MAN MANUAL (c/w O/L)

MAG MAGNETIC (FVNR)

MAG2 MAGNETIC (TWO SPEED)

VFD VARIABLE FREQUENCY DRIVE

MRR MOTOR RATED RELAY (NC/NO)

FVR MAGNETIC, FULL VOLTAGE REVERSING

STARTER GROUPING: PCS1 PACKAGED CONTROL SYSTEM (INTEGRAL TO LOAD[S]) PCS2 PACKAGED CONTROL SYSTEM (SEPARATE FROM LOADS) MCC MOTOR CONTROL CENTRE

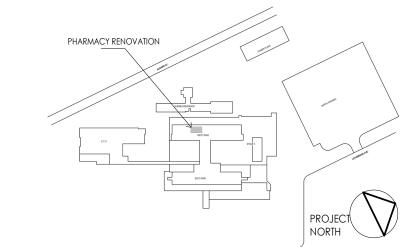
MDC MOTOR DISTRIBUTION CENTRE ('FOUR-PLEX' OR SIMILAR SMALL GROUPED MOTOR CONTROL) LOOSE INDIVIDUALLY-MOUNTED MOTOR STARTER/RELAY/VSD

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Northern Health Authority

UHNBC (University Hospital of Northern BC)-NAPRA Pharmacy Renovation

1475 Edmonton St, Prince George, BC V2M 1S2

LUMINAIRE AND MECHANICAL **SCHEDULES** 

Project No. 144320228 Revision

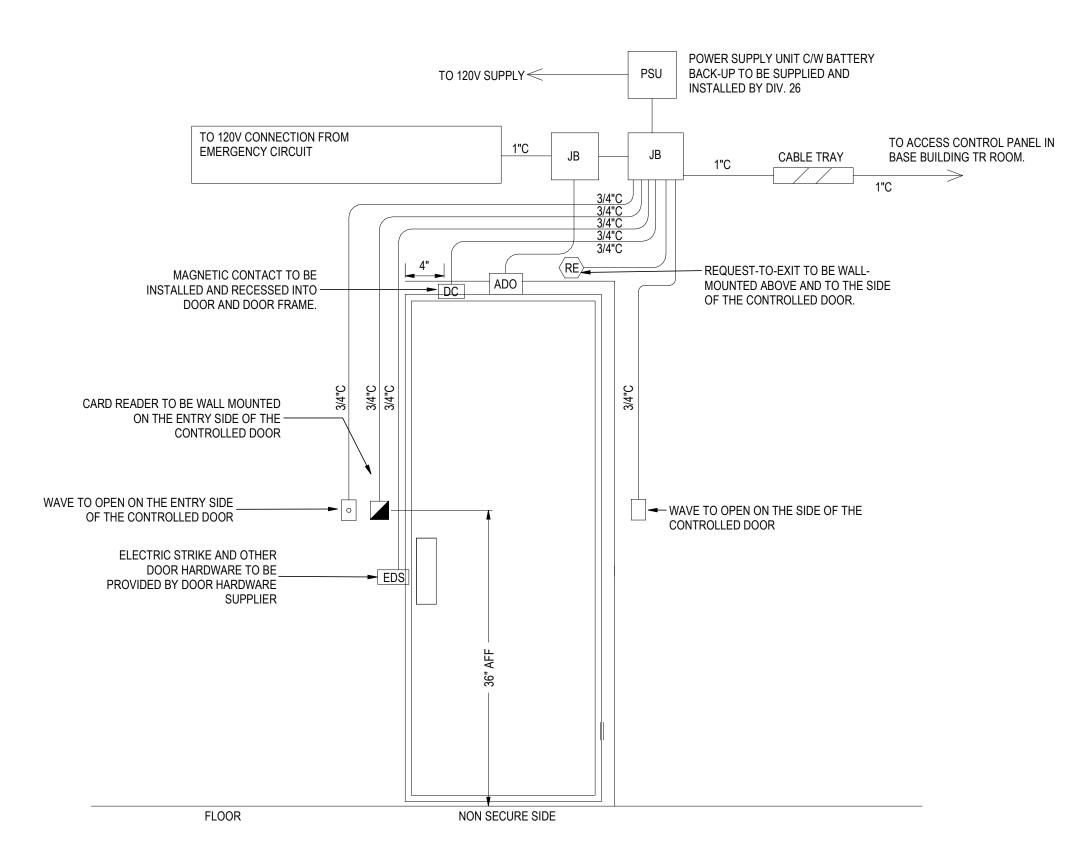
Drawing No.

Scale N.T.S

EMERGENCY BATTERY LIGHTING MOUNTED HORN/ STROBE UNIT RECEPTACLE IN -DISCONNECT PROCESS AREA DOOR ENTRY **PUSH BUTTON** ELECTRICAL PANELBOARD, ELECTRICAL CABINET, FIRE ALARM PANEL STATION COMPUTER RECEPTACLE FINISHED FLOOR

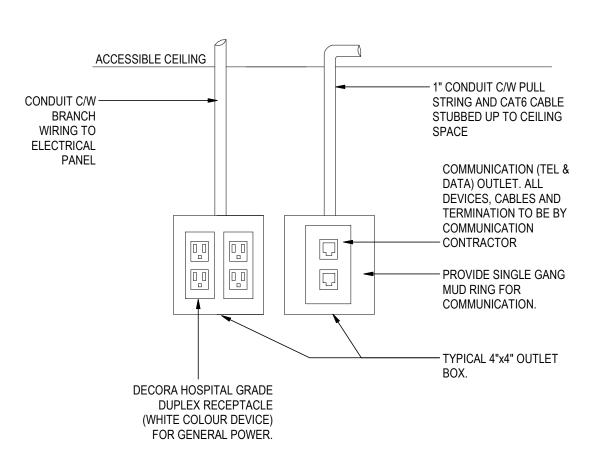
1. ALIGN ALL EQUIPMENT VERTICALLY AND HORIZONTALLY. 2. REFER TO ARCHITECTURAL DETAILS FOR USE OF NON-STANDARD MOUNTING HEIGHTS FOR DEVICES IN SPECIFIC CASES.

STANDARD MOUNTING HEIGHTS



NOTES:
1. PROVIDE CONDUITS, BOXES, AND WIRING AS INDICATED.

TYPICAL CONDUIT LAYOUT FOR A CARD READER ACCESS CONTROL SINGLE DOOR (FULL MONITORING) E400 N.T.S



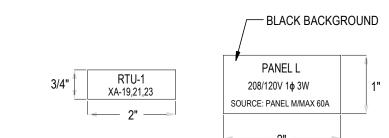
1. DOUBLE DUPLEX RECEPTACLE IS SHOWN, HOWEVER, PROVIDE SINGLE DUPLEX RECEPTACLE WHERE INDICATED ON THE PLANS. PROVIDE WHITE DEVICE WITH WHITE COVER PLATE. CONTRACTOR SHALL CONFIRM DEVICE COLOUR WITH INTERIOR

DESIGNER PRIOR TO PROCUREMENT. 2. PROVIDE MINIMUM OF FOUR (4) PLATES WITH FILLER PLATES FOR EACH UNUSED PORT.

## **TYPICAL COMMUNICATIONS & POWER**

E400 N.T.S

WALL OUTLET DETAILS





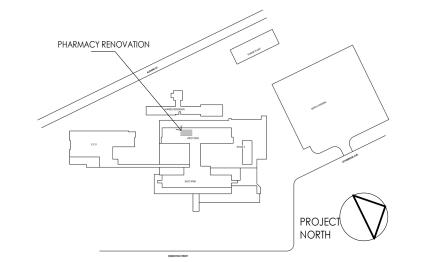


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UHNBC (University Hospital of Northern BC)-NAPRA Pharmacy Renovation

1475 Edmonton St, Prince George, BC V2M 1S2

Revision

ELECTRICAL DETAILS

Project No. 144320228

N.T.S

Scale

Drawing No. **E400** 

CLIMATIC DATA:

RAIN LOAD (1/50), Sr = 0.2 kPa IMPORTANCE FACTOR, Is = 1.25

HOURLY WIND PRESSURE (1/50) = 0.37 kPa

SNOW LOAD (1/50), Ss = 4.3 kPa

le = 1.5 (POST DISASTER)

SITE CLASS = C (ASSUMED)

SEISMIC DATA: Sa(0.2) = 0.113Sa(0.5) = 0.089PGA = 0.049PGV = 0.079

SEISMIC LOAD HAS BEEN DETERMINED USING THE FOLLOWING FACTORS FOR ELEMENT OF STRUCTURES, NON-STRUCTURAL COMPONENTS AND EQUIPMENT: Cp = 1.0, Ar = 2.5, Rp = 2.5

2. THE DESIGN AND CONSTRUCTION SHALL BE IN ACCORDANCE WITH BRITISH COLUMBIA BUILDING CODE 2018 AND CITY OF PRINCE GEORGE BY-LAW NO. 8922 (2018) AND REFERENCED STANDARDS WITHIN.

#### DELEGATED DESIGN

- 1. PORTIONS OF THE DETAILED DESIGN ARE DELEGATED TO THE CONTRACTOR. RETAIN A PROFESSIONAL ENGINEER REGISTERED IN THE PROVINCE OF BRITISH COLUMBIA TO COMPLETE THE DESIGN.
- 2. SUBMIT SHOP DRAWINGS FOR COMPONENTS REQUIRING DELEGATED DESIGN UNDER THE SEAL AND SIGNATURE OF THE ENGINEER RESPONSIBLE FOR THE
- 3. THE FOLLOWING COMPONENTS REQUIRE DELEGATED DESIGN:
  - 3.1 STRUCTURAL STEEL CONNECTIONS 3.2 SUPPLEMENTAL SUPPORT STEEL FOR MEP/ARCH ELEMENTS, INCLUDING PIPE SUPPORTS, PLATFORMS, STAIRS, AND ANCHORAGES
  - 3.3 SEISMIC RESTRAINT FOR MEP/ARCH ELEMENTS 3.4 SEISMIC RESTRAINT AND CONNECTION FOR MECHANICAL EQUIPMENT
- 4. THE ENGINEER RESPONSIBLE FOR THE DESIGN IS ALSO RESPONSIBLE FOR REVIEW OF FABRICATION AND INSTALLATION OF THE COMPONENTS. UPON COMPLETION OF THE WORK, PROVIDE SCHEDULES S-B's AND S-C's TO THE ENGINEER OF RECORD.

#### RENOVATIONS

- 1. THE CONTRACT DOCUMENTS ARE BASED ON ASSUMED AS-BUILT DIMENSIONS FOR THE EXISTING BUILDING STRUCTURE AND ASSUMPTIONS IN ACCORDANCE WITH DETAILING AND PLACING PRACTICE. THESE ASSUMPTIONS MAY VARY FROM THE ACTUAL ON-SITE CONDITIONS. THE CONTRACTOR SHALL IMMEDIATELY INFORM THE CONSULTANT OF ANY ACTUAL VARIATIONS FROM THE ASSUMED CONDITIONS.
- MINOR MODIFICATIONS WILL BE REQUIRED TO THE WORK INDICATED ON THESE DRAWINGS TO REFLECT ACTUAL SITE CONDITIONS. THE CONTRACTOR WILL COOPERATE WITH THE CONSULTANT AND STANTEC IN THIS REGARD. MINOR MODIFICATIONS WILL BECOME THE RESPONSIBILITY OF THE CONTRACTOR AND WILL NOT RESULT IN A CHANGE IN THE CONTRACT PRICE.
- ENSURE THAT ALL NECESSARY JOB DIMENSIONS ARE TAKEN AND ALL TRADES ARE COORDINATED FOR THE PROPER EXECUTION OF THE WORK. THE CONTRACTOR SHALL ASSUME COMPLETE RESPONSIBILITY FOR THE ACCURACY AND COMPLETENESS OF SUCH DIMENSIONS, AND FOR COORDINATION.
- 4. PRIOR TO FABRICATION OF ANY STRUCTURAL MEMBERS, THE CONTRACTOR SHALL COMPLETE THIS SITE REVIEW OF CRITICAL "TIE-IN" DIMENSIONS AND
- CONFIRM ALL DIMENSIONS TO ENSURE PROPER FIT OF NEW WORK TO EXISTING. REPORT ANY DISCREPANCIES TO STANTEC PRIOR TO STARTING WORK.
- 5. COMMENCEMENT OF CONSTRUCTION OR ANY PART THEREOF CONSTITUTES ACCEPTANCE OF EXISTING CONDITIONS AND MEANS DIMENSIONS AND ELEVATIONS HAVE BEEN CONSIDERED, VERIFIED AND ARE ACCEPTABLE.
- 6. DO NOT INSTALL OPENINGS, SET INSERTS, DRILL OR ATTACH TO THE STRUCTURAL BUILDING COMPONENTS, EXCEPT AS NOTED ON THE STRUCTURAL DRAWINGS, WITHOUT WRITTEN CONSENT OF THE STRUCTURAL ENGINEER.
- 7. UNLESS NOTED OTHERWISE ON THE STRUCTURAL DRAWINGS, THE CORING OR CUTTING OF OPENINGS AND HOLES SHOWN ON THE STRUCTURAL DRAWINGS THROUGH THE EXISTING STRUCTURE SHALL NOT CUT ANY REINFORCING BARS. THE CONTRACTOR SHALL LOCATE THE POSITION OF EXISTING REINFORCING BARS IN THE VICINITY OF THE HOLES AND SLEEVES TO BE CUT OR CORED, AND THE HOLES AND SLEEVES SHALL BE LOCATED TO AVOID CUTTING OF REINFORCING BARS. WHERE THIS IS NOT POSSIBLE, IT SHALL BE REPORTED TO STANTEC FOR REVIEW.
- 8. NO OPENINGS OR CORE HOLES WILL BE PERMITTED THROUGH EXISTING SLAB / SLAB BANDS.
- 9. NEW OPENINGS OR HOLES TO BE CUT OR CORED THROUGH EXISTING FLOOR SLAB OR WALLS SHALL BE CLEARLY MARKED OUT BY THE CONTRACTOR. THE CONTRACTOR SHALL NOTIFY STANTEC ONCE THE MARKING OUT HAS BEEN COMPLETED SO THAT STANTEC CAN REVIEW THE PROPOSED LOCATIONS OF ALL NEW OPENINGS. DO NOT PROCEED WITH CUTTING OF NEW OPENINGS WITHOUT THE REVIEW AND ACCEPTANCE BY STANTEC.
- 10. THE CONTRACTOR IS RESPONSIBLE FOR SAFETY IN AND ABOUT THE JOB SITE DURING CONSTRUCTION, AND THE DESIGN AND ERECTION OF ALL TEMPORARY STRUCTURES, FORMWORK, FALSEWORK, SHORING, BRACING, ETC., REQUIRED TO COMPLETE THE WORK (SUBMIT SHORING DRAWINGS SEALED BY A SPECIALTY STRUCTURAL ENGINEER).
- 11. DRILL AND SITE MEASURE BOLT / ANCHOR HOLES IN EXISTING STRUCTURE PRIOR TO FABRICATING STEEL CONNECTION PLATES. BOLT / ANCHOR HOLES MAY HAVE TO BE MOVED FROM WHAT IS SHOWN ON THE DRAWINGS TO AVOID CUTTING EXISTING REINFORCING OR TO AVOID OTHER SITE CONDITIONS. SITE MODIFICATION OF STEEL CONNECTION PLATES WILL NOT BE ACCEPTED WITHOUT THE PRIOR APPROVAL OF STANTEC.
- 12. STRUCTURAL MODIFICATION IS LIMITED TO THE AREA(S) SHOWN ON THESE DRAWINGS. FOR THE REMAINDER OF THE EXISTING BUILDING, THE CURRENT PERFORMANCE LEVEL IS MAINTAINED AND SEISMIC OR OTHER STRUCTURAL EVALUATION AND UPGRADING (INCLUDING UPGRADING TO CARRY GRAVITY LOADS) I S NOT INCLUDED IN THE SCOPE OF THE PROJECT. STANTEC ACCEPTS NO RESPONSIBILITY FOR THE STRUCTURAL ADEQUACY OF THE REMAINDER OF THE
- 13. ALL EXISTING CONSTRUCTION ALTERED OR DAMAGED DURING COURSE OF WORK TO BE REPAIRED BY THE CONTRACTOR.

EXISTING BUILDING (WHICH REMAINS THE RESPONSIBILITY OF THE ORIGINAL STRUCTURAL ENGINEER).

#### SHOP DRAWINGS

- 1. SUBMIT SHOP DRAWINGS OF ALL MATERIALS PRIOR TO INSTALLATION WITH A MINIMUM OF 2 WEEKS FOR REVIEW. DOCUMENTS REQUIRING THE SEAL OF A SPECIALTY STRUCTURAL ENGINEER OR MATERIALS CONSULTANT SHOULD BE SEALED AND ACCOMPANIED BY APPROPRIATE LETTERS OF ASSURANCE WHEN SUBMITTED FOR DOCUMENTS RECEIVED WITHOUT APPROPRIATE USE OF THE SEAL MAY BE RETURNED AND ALL INCOMPLETE SUBMISSIONS MAY REQUIRE A FURTHER COMPLETE SUBMISSION
- 2. REVIEW OF SHOP DRAWINGS IS ONLY FOR GENERAL COMPATIBILITY WITH THE DESIGN CONCEPT. THE CONSULTANT DOES NOT WARRANT OR REPRESENT THAT THE INFORMATION CONTAINED ON THE SHOP DRAWINGS IS EITHER ACCURATE OR COMPLETE. SOLE RESPONSIBILITY FOR CORRECT DESIGN, DETAILS AND DIMENSIONS SHALL REMAIN WITH THE PARTIES SUBMITTING THE DRAWING. REVIEW IS NOT APPROVAL OF DESIGN AND SHALL NOT RELIEVE THE CONTRACTOR OF RESPONSIBILITY TO SATISFY REQUIREMENTS OF THE CONTRACT DOCUMENTS.

#### STRUCTURAL STEEL

- 1. DESIGN, FABRICATION, ERECTION, AND OTHER CONSTRUCTION PRACTICES TO CONFORM TO CSA-S16 AND THE CISC CODE OF STANDARD PRACTICE FOR
- 2. CONTRACTOR TO RETAIN A PROFESSIONAL ENGINEER REGISTERED IN THE PROVINCE OF BRITISH COLUMBIA TO COMPLETE THE DESIGN FOR STRUCTURAL STEEL CONNECTIONS. THE ENGINEER RESPONSIBLE FOR THE DESIGN IS ALSO RESPONSIBLE FOR THE REVIEW OF FABRICATION AND INSTALLATION OF THE COMPONENTS. SUBMIT SHOP DRAWINGS AND LETTERS OF ASSURANCE OF THE DELEGATED DESIGN (SCHEDULE S-B AND S-C) BEARING ENGINEER'S SIGNATURE
- 3. SUBMIT SHOP DRAWINGS SHOWING ALL STRUCTURAL STEEL MEMBERS FOR REVIEW PRIOR TO FABRICATION. WELDING TO CONFORM TO CSA-W59.
- 4. SHOP GALVANIZING TO CONFORM TO CAN/CSA-G164 AND ASTM A123 / A123M.
- 5. GALVANIZE ALL EXPOSED STEEL AND CONNECTION COMPONENTS UNLESS NOTED OTHERWISE. PRESSURE RELIEF HOLES TO BE DESIGNED BY FABRICATOR AND
- 6. PROVIDE STRUCTURAL STEEL TO MEET THE REQUIREMENTS OF CSA STANDARD G40.21-13 WITH THE FOLLOWING GRADES. WIDE FLANGE SECTIONS

CHANNELS AND ANGLES HSS SECTIONS (CLASS 'C') 350W 300W STRUCTURAL BARS AND PLATES ANCHOR RODS ASTM F1554 GR 36 HILTI HAS ROD

- 7. ALL BOLTED CONNECTIONS TO USE FULLY PRETENSIONED HIGH-STRENGTH BOLTS A325 HOT DIP GALVANIZED UNLESS OTHERWISE NOTED ON THE DRAWINGS.
- 8. PROVIDE 10 mm MINIMUM PLATE STIFFENERS EACH SIDE OF BEAM AT ALL BEARING CONNECTIONS UNLESS OTHERWISE NOTED ON THE DRAWINGS.
- 9. DO NOT SPLICE MATERIAL WITHOUT THE WRITTEN ACCEPTANCE OF THE ENGINEER. WHERE GRANTED, A COMPLETE NON-DESTRUCTIVE EXAMINATION WILL BE MANDATORY AND PAID FOR BY THE SUB-CONTRACTOR.
- 10. FIELD WELDING AND FIELD MODIFICATION OF STRUCTURAL STEEL WILL NOT BE ALLOWED WITHOUT PRIOR REVIEW AND WRITTEN ACCEPTANCE BY THE STRUCTURAL ENGINEER.

#### FIELD REVIEW BY STANTEC

1. FIELD REVIEW IS AT THE PROFESSIONAL DISCRETION OF STANTEC AND IS TO ASCERTAIN GENERAL COMPLIANCE WITH THE STRUCTURAL PLANS AND SUPPORTING DOCUMENTS FOR THE INTEGRITY OF THE PRIMARY STRUCTURAL COMPONENTS OF THE BUILDING ONLY. FIELD REVIEW DOES NOT MAKE STANTEC GUARANTORS OF THE CONTRACTOR'S WORK. FIELD REVIEW IS NOT FOR THE BENEFIT OF THE CONTRACTOR AND MAY NOT FORM PART OF THE CONTRACTORS CONSTRUCTION QUALITY CONTROL WHICH SHALL REMAIN THE RESPONSIBILITY OF THE CONTRACTOR(S). STANTEC SHALL NOT BE RESPONSIBLE FOR ACTS OR OMISSIONS OF THE CONTRACTOR OR FOR THE CONTRACTORS FAILURE TO FULFILL THE INTENT OF THE DESIGN DRAWINGS.

#### ANCHOR AND THRU-BOLT INSTALLATION

- 1. CONTRACTOR SHALL SURVEY AND CONFIRM ALL RELEVANT EXISTING BUILDING DIMENSIONS PRIOR TO FABRICATION AND CONSTRUCTION.
- 2. EXISTING REINFORCEMENT SHALL NOT BE DAMAGED. CONCRETE IN THE VICINITIES OF PROPOSED HOLE LOCATIONS SHALL BE SCANNED TO LOCATE REINFORCEMENT, ADJUSTMENT AS SHOWN SHALL BE MADE TO AVOID REINFORCEMENT HIT.
- 3. PRIOR TO DRILLING, SUBMIT THE SCAN RESULTS WITH MARKED HOLE LOCATIONS TO DEPARTMENTAL ENGINEER FOR REVIEW.
- 4. HOLES ON MOUNTING PLATES SHALL BE DRILLED TO SUIT THE FINAL THRU BOLTS ARRANGEMENTS.
- DO NOT OVERSIZE DRILL HOLES ON PLATES.
- 6. THRU HOLES IN CONCRETE SHALL BE FILLED WITH NON-SHRINK GROUT TO PROVIDE TIGHT FIT FOR BOLTS.

#### STANDARD STRUCTURAL DRAWING ABBREVIATIONS

AR or A.ROD

ANCHOR ROD

ADDITIONAL

ALTERNATE ALUM ALUMINUM APPD APPROVED APPROX or ± APPROXIMATELY ARCHITECT BACK TO BACK BOTTOM BLOCK BOTTOM LOWER LAYER BEARING BTWN BETWEEN BUILT-UP BOTTOM UPPER LAYER EPOXY COATED REBAR C (i.e 10M<u>C</u>) COMPLETE WITH CANTILEVER CAST IN PLACE CONTROL JOINT CL or CENTERLINE CONC  $\not\subseteq$ CONCRETE CONN CONNECTION CONT CONTINUOUS D or DP DEEP or DEPTH DIA or Ø DIAMETER DIAG DEAD LOAD DRAWING EACH END EACH FACE EXPANSION JOINT EACH SIDE EACH WAY **ELEVATION** ELEC ELECTRICAL **EMBED EMBEDDED** EXTRA EXIST FXISTING **EXTERIOR** FDTN FOUNDATION FAR SIDE FOOTING FULL TENSION SPLICE GALVANIZED GR BM GRADE BEAM H OR HT HIGH OR HEIGHT HOOK ONE END HOOK TWO ENDS HORIZ HORIZONTAL INSIDE DIAMETER INSIDE FACE INCLUDING INSUL INSULATION INTERIOR LOCATION LIVE LOAD LONG LEG HORIZONTAL LONG LEG VERTICAL LONGIT LONGITUDINAL MAX MAXIMUM MECHANICAL MEZZ MEZZANINE MIDDI F MINIMUM MISCELLANEOUS NOT IN CONTRACT NEAR SIDE N STUD NELSON STUD NOT TO SCALE NTS NO or # NUMBER ON CENTER OUTSIDE DIAMETER OUTSIDE FACE OPP OPPOSITE OPNG OPENING OWSJ OPEN WEB STEEL JOIST PRCST PERIM PERP PERIMETER PERPENDICULAR PKG PL or PLYWD PLATE PI YWOOD POLY POLYETHYLENE PROJ QTY QUANTITY R OR RAD RADIUS REINFORCE WITH REINF REINFORCING REM REMAINDER REQD REQUIRED RTU ROOF TOP UNIT SECT SECTION SIM P SIMILAR SAWCUT JOINT SOG SLAB ON GRADE SPMDD STANDARD PROCTOR MAXIMUM DRY DENSITY STAINLESS STEEL STIF STIFFENER STIR STIRRUP STRUCT STRUCTURAL SYMM SYMMETRICAL TOP & BOTTOM TOP LOWER LAYER TOP UPPER LAYER UNLESS NOTED OTHERWISE UNO UNDERSIDE VERT VERTICAL WORKING POINT WELDED WIRE MESH WELDED HEADED STUD

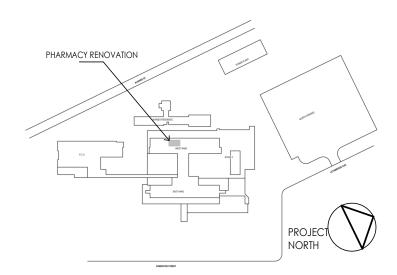


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Consultant



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Issued/Revision



Stantec Permit: 1002862

By Appd YYYY.MM.DD

Client/Project Logo



Client/Project Northern Health Authority

UHNBC (University Hospital of Northern

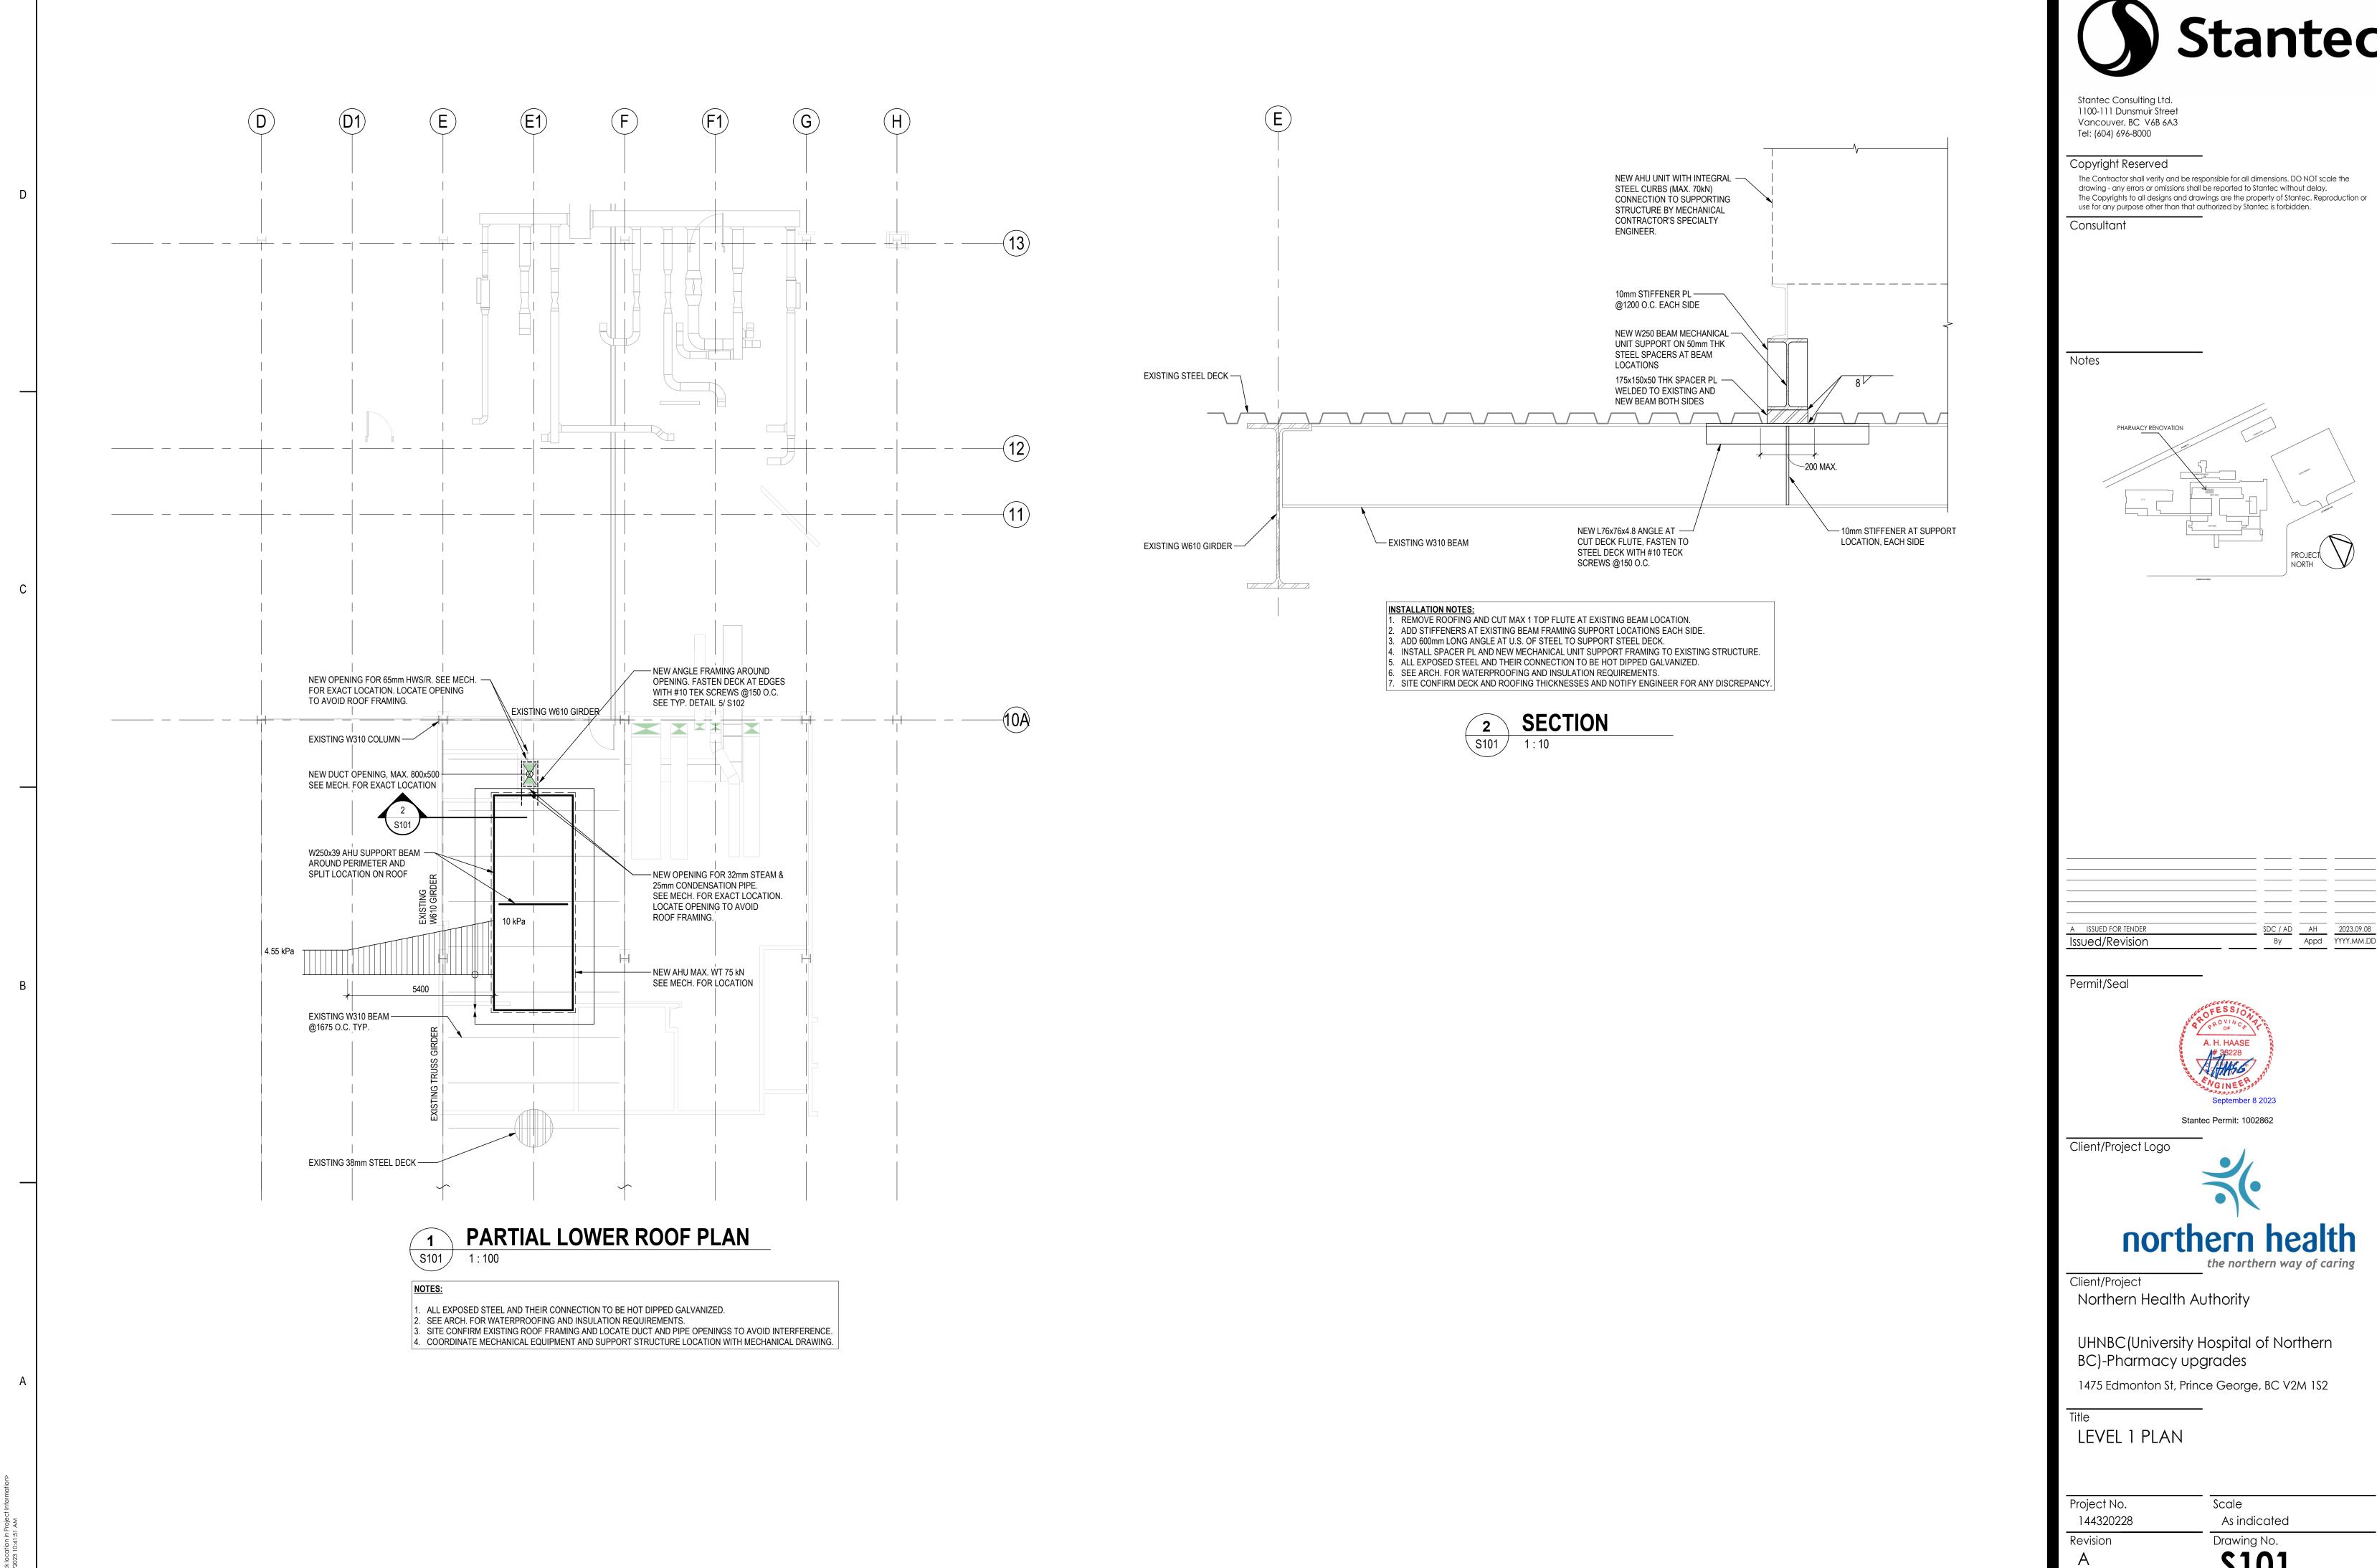
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GENERAL NOTES

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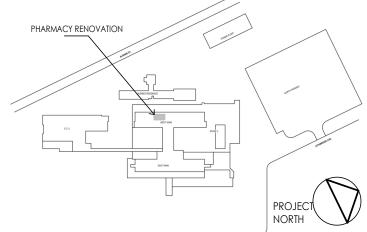
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ORIGINAL SHEET - ARCH D

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