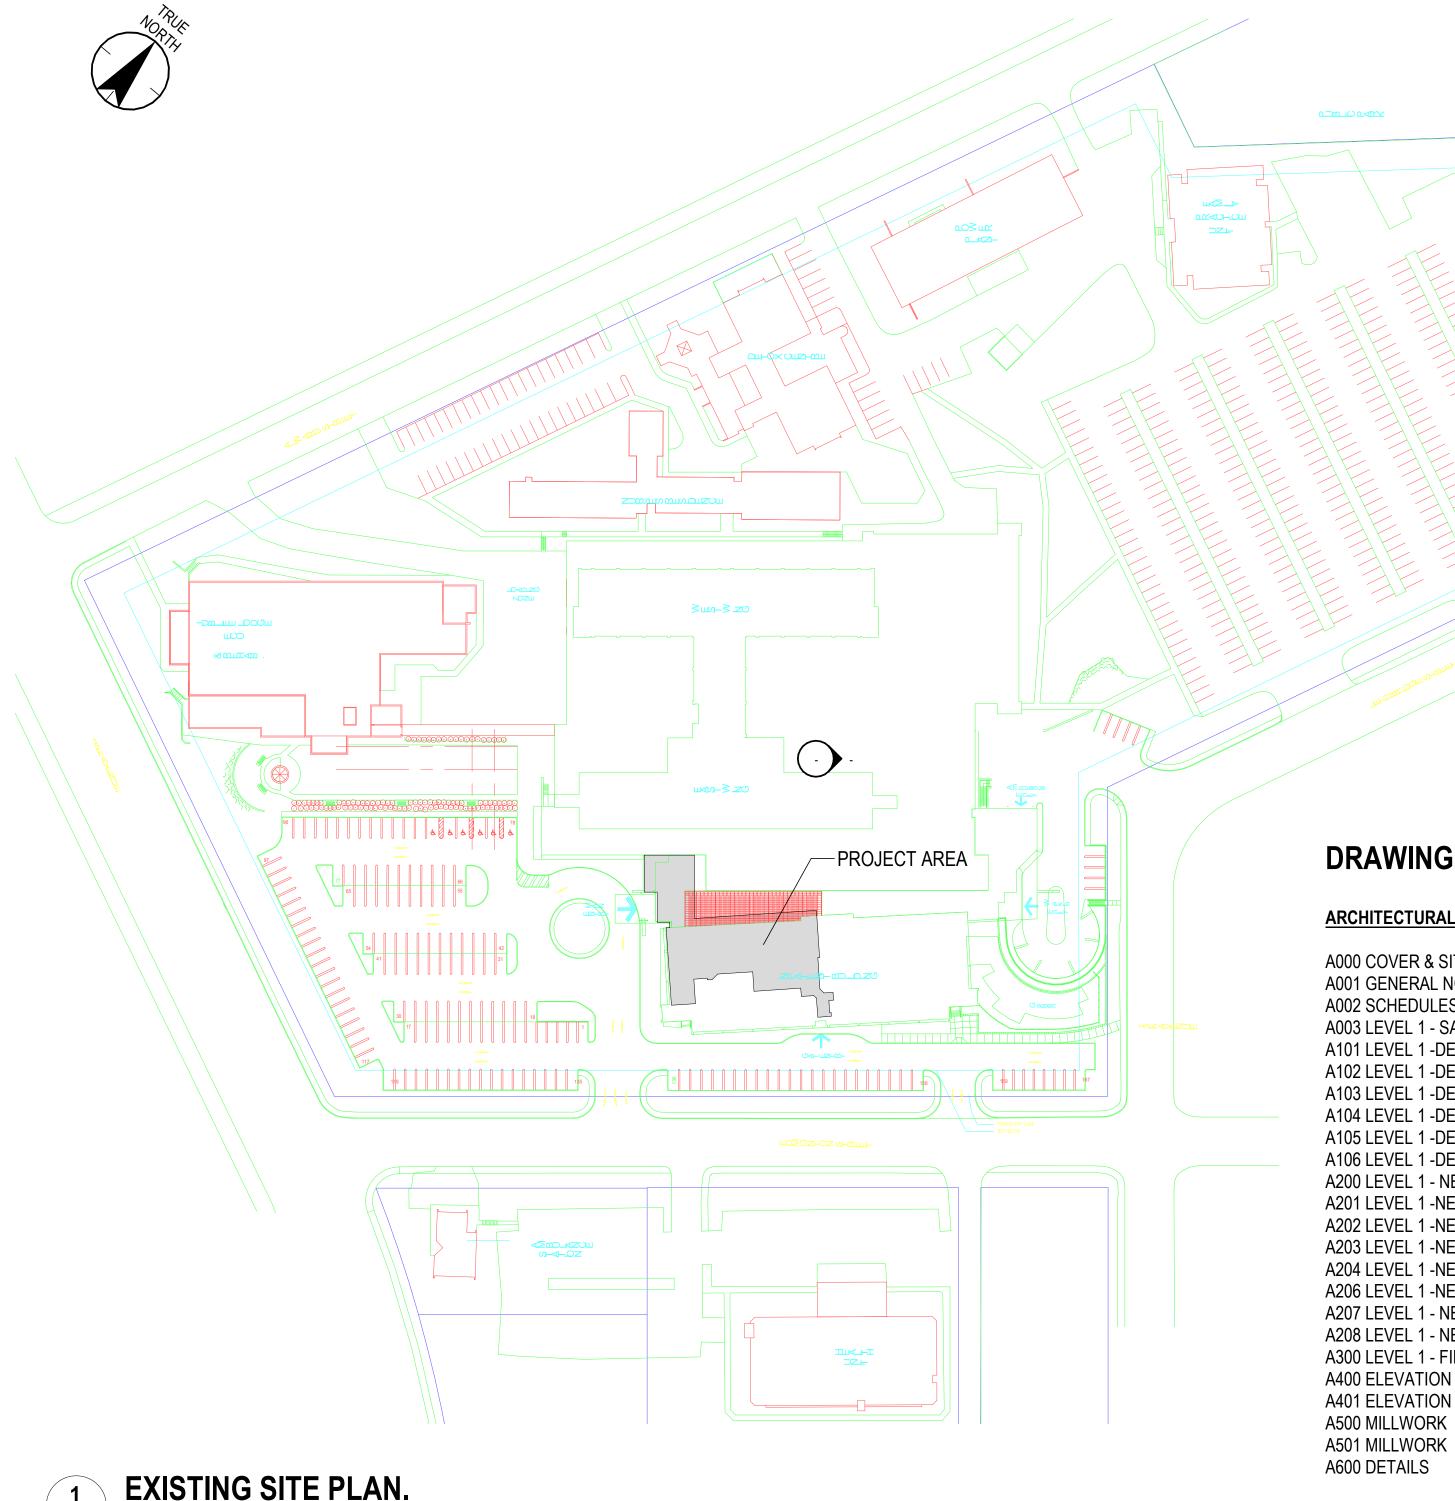
UHN - Cardiac Diagnostic Services - Phase 3



PROJECT ADDRESS: 1475 Edmonton St, Prince George, BC V2M 1S2 PROJECT LEGAL ADDRESS: LOT 4 DL343 PLAN 34806 PID 016348362



DRAWING LIST:

A000 COVER & SITE PLAN A001 GENERAL NOTES, SYMBOLS & ABBREVIATIONS A002 SCHEDULES & MOUNTING ELEVATION A003 LEVEL 1 - SAFETY PLAN A101 LEVEL 1 -DEMOLITION FLOOR PLAN - EAST SIDE A102 LEVEL 1 -DEMOLITION FLOOR PLAN - WEST SIDE A103 LEVEL 1 -DEMOLITION FLOOR PLAN - NORTH SIDE A104 LEVEL 1 -DEMOLITION REFLECTED CEILING PLAN - EAST SIDE A105 LEVEL 1 -DEMOLITION REFLECTED CEILING PLAN - WEST SIDE A106 LEVEL 1 -DEMOLITION REFLECTED CEILING PLAN - NORTH SIDE

A200 LEVEL 1 - NEW FLOOR PLAN A201 LEVEL 1 -NEW EQUIPMENT FLOOR PLAN A202 LEVEL 1 -NEW FLOOR PLAN - EAST SIDE A203 LEVEL 1 -NEW FLOOR PLAN - WEST SIDE A204 LEVEL 1 - NEW FLOOR PLAN - NORTH SIDE A206 LEVEL 1 -NEW REFLECTED CEILING PLAN - EAST SIDE

A207 LEVEL 1 - NEW REFLECTED CEILING PLAN - WEST SIDE A208 LEVEL 1 - NEW REFLECTED CEILING PLAN - NORTH SIDE A300 LEVEL 1 - FINISHES FLOOR PLAN

A401 ELEVATION A500 MILLWORK A501 MILLWORK

M001 MECHANICAL LEGEND M002 GENERAL NOTES & DRAWINGS LIST M003 LEVEL 1 - MECHANICAL HVAC DEMO - EAST SIDE M004 LEVEL 1 - MECHANICAL HVAC DEMO - WEST SIDE M005 LEVEL 1 - MECHANICAL HVAC DEMO - NORTH SIDE M006 LEVEL 1 - MECHANICAL HYDRONIC DEMO - EAST SIDE M007 LEVEL 1 - MECHANICAL HYDRONIC DEMO - WEST SIDE M008 LEVEL 1 - MECHANICAL HYDRONIC DEMO - NORTH SIDE M009 LEVEL 1 - PLUMBING DEMO - EAST SIDE M010 LEVEL 1 - PLUMBING DEMO - WEST SIDE M011 LEVEL 0 - PLUMBING DEMO - EAST SIDE M012 LEVEL 0 - PLUMBING DEMO - WEST SIDE M013 LEVEL 1 - MEDICAL GAS DEMO - EAST SIDE M014 LEVEL 1 - MEDICAL GAS DEMO - WEST SIDE M015 LEVEL 1 - FIRE SUPPRESSION DEMO - EAST SIDE M016 LEVEL 1 - FIRE SUPPRESSION DEMO - WEST SIDE M017 LEVEL 1 - FIRE SUPPRESSION DEMO - NORTH SIDE M100 LEVEL 1 - MECHANICAL HVAC ENVIRONMENTAL CONTROL M101 LEVEL 1 - MECHANICAL HVAC NEW - EAST SIDE M102 LEVEL 1 - MECHANICAL HVAC NEW - WEST SIDE M103 LEVEL 1 - MECHANICAL HVAC NEW - NORTH SIDE M104 LEVEL 1 - MECHANICAL HYDRONIC NEW - EAST SIDE M105 LEVEL 1 - MECHANICAL HYDRONIC NEW - WEST SIDE M106 LEVEL 1 - MECHANICAL HYDRONIC NEW - NORTH SIDE M201 LEVEL 1 - PLUMBING NEW - EAST SIDE M202 LEVEL 1 - PLUMBING NEW - WEST SIDE M203 LEVEL 1 - PLUMBING NEW - NORTH SIDE M204 LEVEL 0 - PLUMBING NEW - EAST SIDE M205 LEVEL 0 - PLUMBING NEW - WEST SIDE M206 LEVEL 0 - PLUMBING NEW - NORTH SIDE M301 LEVEL 1 - MEDICAL GAS NEW - EAST SIDE M302 LEVEL 1 - MEDICAL GAS NEW - WEST SIDE M303 LEVEL 1 - MEDICAL GAS NEW - NORTH SIDE M401 LEVEL 1 - FIRE SUPPRESSION NEW - EAST SIDE M402 LEVEL 1 - FIRE SUPPRESSION NEW - WEST SIDE M403 LEVEL 1 - FIRE SUPPRESSION NEW - NORTH SIDE M500 EQUIPMENT SCHEDULES

E001 COVER PAGE E100 LEVEL 1 - PATIENT CARE AREA CLASSIFICATIONS PLAN E200 LEVEL 1 - POWER & COMMUNICATIONS DEMO - EAST SIDE E201 LEVEL 1 - POWER & COMMUNICATIONS DEMO - WEST SIDE E202 LEVEL 1 - POWER & COMMUNICATIONS DEMO - NORTH SIDE E210 LEVEL 1 - FIRE ALARM, ACCESS CONTROL & NURSE CALL SYSTEM DEMO - EAST SIDE E211 LEVEL 1 - FIRE ALARM, ACCESS CONTROL & NURSE CALL SYSTEM DEMO - WEST SIDE E212 LEVEL 1 - FIRE ALARM, ACCESS CONTROL & NURSE CALL SYSTEM DEMO - NORTH SIDE E220 LEVEL 1 - LIGHTING DEMO - EAST SIDE E221 LEVEL 1 - LIGHTING DEMO - WEST SIDE E222 LEVEL 1 - LIGHTING DEMO - NORTH SIDEE E300 LEVEL 1 - POWER & COMMUNICATIONS NEW - EAST SIDE E301 LEVEL 1 - POWER & COMMUNICATIONS NEW - WEST SIDE E302 LEVEL 1 - POWER & COMMUNICATIONS NEW - NORTH SIDE E310 LEVEL 1 - FIRE ALARM, ACCESS CONTROL & NURSE CALL SYSTEM NEW - EAST SIDE E311 LEVEL 1 - FIRE ALARM, ACCESS CONTROL & NURSE CALL SYSTEM NEW - WEST SIDE E312 LEVEL 1 - FIRE ALARM, ACCESS CONTROL & NURSE CALL SYSTEM NEW - NORTH SIDE E320 LEVEL 1 - LIGHTING NEW - EAST SIDE E321 LEVEL 1 - LIGHTING NEW - WEST SIDE E322 LEVEL 1 - LIGHTING NEW - NORTH SIDE E400 ELECTRICAL SCHEDULES & DIAGRAMS (1 OF 2) E401 ELECTRICAL SCHEDULES & DIAGRAMS (2 OF 2) **E405 ELECTRICAL PANEL SCHEDULES**

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0'-0" VERTICAL ELEVATION — VERTICAL ELEVATION PROJEC1 NORTH ARROW DRAWING REVISION

NSTALLED AS REQUIRED PRIOR TO THE COMMENCEMENT OF WORK.

FECHNICAL INSTRUCTOR PRIOR TO COMMENCEMENT OF WORK

EXISTING WALL & DOOR CONSTRUCTION

NEW WALL & DOOR CONSTRUCTION

EXISTING WALL & DOOR CONSTRUCTION

TO BE DEMOLISHED

DEMOLITION NOTES:

- REMOVE ALL EXISTING FLOORING, WALL BASE AND ADHESIVES WITHIN THE AREA OF RENOVATION. LEVEL AND PATCH DAMAGE TO SUBFLOORS CAUSED BY REMOVAL OF FLOOR FINISHES AND FLOOR SCRAPING. REMOVE LOOSE FLOOR LEVELING COMPOUND AS REQUIRED. ALL LOOSE DEBRIS TO BE REMOVED FROM FLOOR PRIOR TO START OF RENOVATION WORK. REFER TO RENOVATION PLANS FOR COORDINATION. REFER TO ASBESTOS REPORT FOR ASBESTOS CONTAINING MATERIALS.
- DEMOLISH AND REMOVE EXISTING WALL AS INDICATED, REMOVE WALL FROM TOP OF CONCRETE SLAB TO UNDERSIDE OF TRUSSES ABOVE. REMOVE ALL CONNECTION DEVICES INCLUDING BOLTS, INSERTS, REINFORCING BARS, TIES, ETC. FROM CONCRETE SLABS AND FROM REMAINING WALLS, REFER ALSO TO MECHANICAL / PLUMBING AND ELECTRICAL DEMOLITION DOCUMENTS AND NOTES. REFER TO ASBESTOS REPORT FOR ASBESTOS CONTAINING MATERIALS
- REMOVE EXISTING DOOR AND FRAME INCLUDING CONNECTIONS TIES AND ANCHORS.
- REMOVE EXISTING CEILING FINISH AS INDICATED INCLUDING ALL CONNECTION DEVICES, BOLTS, INSERTS, TIES, ANCHORS, ETC. REFER ALSO TO MECHANICAL / PLUMBING AND ELECTRICAL DEMOLITION DOCUMENTS AND NOTES.
- ALL LOOSE EQUIPMENT AND FURNITURE TO BE REMOVED BY OWNER PRIOR TO START OF DEMOLITION AND CONSTRUCTION. ANY REMAINING LARGE EQUIPMENT AND FIXED EQUIPMENT TO BE COORDINATED BETWEEN THE OWNER AND CONTRACTOR FOR REMOVAL AND RELOCATION. TURN OVER ANY REMAINING EQUIPMENT TO THE OWNER UPON REQUEST
- REFER TO MECHANICAL AND ELECTRICAL DRAWINGS FOR EXTENT OF EXISTING SERVICES TO BE REMOVED. INFILL FRAMING AS NEEDED.
- SCAN ALL CONCRETE FLOOR SLABS AND WALLS PRIOR TO START OF CONSTRUCTION TO DETERMINE THE EXTENT AND LOCATION OF BURIED SERVICES AS REQUIRED.
- REMOVE ALL EXISTING WALL MOUNTED ACCESSORIES AND EQUIPMENT NOT REMOVED BY THE OWNER CONTRACTOR TO COORDINATE AND TURN OVER ANY FOUIPMENT REMAINING TO
- REMOVE EXISTING PLUMBING FIXTURE REFER TO MECHANICAL FOR EXTENT OF WORK AND SERVICES TO BE REMOVED.
- PROTECT ADJACENT FINISHES DURING DEMOLITION AND CONSTRUCTION. PROVIDE FLOOR AND
- EXISTING DEMISING WALL TO REMAIN. REMOVE EXISITING GWB FINISH TO EXPOSE STUDS. PATCH AND MAKE GOOD ALL DEFICIENT FIRE STOPPING IN AREA OF WORK. FIRE STOP ANY EXISTING PENETRATIONS WHERE EXISTING MECHANICAL OR ELECTRICAL SERVICES ARE
- REMOVE CEILING AND WALL HUNG MECHANICAL EQUIPMENT. REFER TO MECHANICAL DRAWINGS.
- REMOVE EXISTING GWB FINISH ON EXTERIOR WALL TO EXPSOE STUDS. CHECK FOR MOLD AND WATER DAMAGE.
- REMOVE EXISTING MECHANICAL AND ELECTRICAL FIXTURES/DEVICES AS INDICATED ON THE MECHANICAL AND ELECTRICAL DRAWINGS. TERMINATE AND CAP OFF ALL PROJECTING MECHANICAL, ELECTRICAL, PLUMBING AND COMMUNICATIONS SYSTEMS INDICATED TO BE REMOVED. ENGINEERS DRAWINGS GOVERN THE EXTENT AND METHOD OF REMOVAL, CAPPING OFF AND MAKING SAFE OF MECHANICAL, ELECTRICAL, PLUMBING AND COMMUNICATION SYSTEMS. PATCH AND MAKE GOOD SLAB AT ALL PENETRATIONS WHERE SERVICES ARE
- REMOVE ANY REMAINING MILLWORK THROUGHOUT THE SPACE.

<u> MILLWORK:</u>

- REMOVE ALL LOOSE WALL FINISHES AND TRIMS AT EXTERIOR WALLS. EXISTING EXTERIOR BLOCK WALL STRUCTURE TO REMAIN. PATCH AND MAKE GOOD ALL INSULATION AND VAPOUR BARRIER AT EXTERIOR WALLS WHEN EXPOSED DURING DEMOLITION AND CONSTRUCTION
- DEMOLISH WALL TO ACCOMMODATE NEW DOORS. CUT WOOD VENIER IN THE MAIN LOBBY AS REQUIRED AND REINSTALL IT OR ADD NEW FINISH TO MATCH EXISTING AFTER WALL/DOOR
- REMOVE EXISTING ACT CEILING AFFECTED BY DEMOLITION ACTIVITIES. PROVIDE NEW TILES

ARCHITECTURAL MILLWORK" PUBLISHED BY AWMAC.

ELECTRICAL CONSULTANTS' DRAWINGS AND SPECIFICATIONS.

ENSURE DOORS DON'T BIND AND OPERATE AS INTENDED.

TO ADJACENT MILLWORK AND/OR PARTITIONS.

REQUIRED BY "GOOD PRACTICE" STANDARDS.

ALL MILLWORK FASTENERS SHALL BE CONCEALED.

ACCORDANCE WITH SPECIFICATIONS.

PROVIDE FULL BACK TO ALL CABINETS

COLORS WITH DESIGN CONSULTANT

USE P.LAM W/ PLYWOOD CORE

REFER TO SPECIFICATIONS FOR ALL HARDWARE INFORMATION.

SCRIBE ALL COUNTERTOPS AND BACKSPLASHES TIGHT TO WALLS.

SIZE OF OPENINGS FOR ALL FOLIPMENT WITH DESIGN CONSULTANT

TO FARRICATION OF MILL WORK

APPROVAL PRIOR TO FABRICATION

HOARDING TYPE HARD / SOFT TO BE CONFIRMED WITH OWNER AND AS PER INFECTION CONTROLL REQUIRMENT. PRIOR TO HOARDING INSTALLATION CONTRACTOR TO SCHEDULE AND CONFIRM WITH OWNER ACCESS ROUTES AND SECURITY DETAILS HORDING ON AREAS AND WALLS FITH FIRE SEPARATION TO MATCH EXISTING FIRE RATING

ALL MILLWORK SHALL MEET THE CUSTOM GRADE STANDARD. FOLLOW "QUALITY STANDARDS FOR

CONTRACTOR SHALL CONFIRM ALL DIMENSIONS ON SITE PRIOR TO SUBMITTING SHOP DRAWINGS PRIOR

SUBMIT THREE (3) SETS OF SHOP DRAWINGS FOR ALL MILLWORK ITEMS TO DESIGN CONSULTANT FOR

COORDINATE LOCATION OF PLUMBING AND ELECTRICAL COMPONENTS. REFER TO MECHANICAL AND

MILLWORK SUB CONTRACTOR SHALL CONFIRM WITH GENERAL CONTRACTOR THAT THERE IS

ADEQUATE BLOCKING IN WALLS WHERE SHELVING AND MILLWORK ARE REQUIRED. GENERAL

PROVIDE CLEAR SILICONE BEAD AT HORIZONTAL AND VERTICAL INTERSECTIONS OF MILLWORK

CONFIRM ALL APPLIANCE AND EQUIPMENT SIZES PRIOR TO MILLWORK FABRICATION, CONFIRM

PROVIDE 13mm (1/2") REVEAL WHERE MILLWORK MEETS CEILING, BULKHEADS AND WALLS.

PROVIDE ADEQUATE SPACE WHERE CABINET DOORS MEET AT 90 DEGREE CORNERS TO

CONTRACTOR SHALL SUPPLY BLOCKING AS REQUIRED BY MILLWORK SPECIFIED.

WHERE REQUIRED, ALL LOCKS SHALL BE KEYED TO OWNER SPECIFICATIONS.

COORDINATE ALL EXISTING RELOCATED AND NEW EQUIPMENT WITH CONSULTANT.

ALL SURFACES OF INTERIOR CABINETS INCLUDING; GABLES. ADJUSTABLE AND NON

ADJUSTABLE SHELVES, AND DRAWER INTERIORS SHALL PLAM FINISH U.N.O. CONFIRM

DRAWER SIDES AND ENDS SHALL BE FULLY GLUED AND PNEUMATICALLY NAILED AT ALL

PROVIDE SHELVES WITH PULL-OUT HARDWARE WHERE SHELF IS INDICATED TO PULL IN

ALL CABINETS SHALL HAVE ADJUSTABLE SHELVES C/W RECESSED STANDARDS, U.N.O.

TO ENSURE A PROPER BOND AND TO PREVENT DISRUPTION OF SEAMS DUE TO

MOISTURE VARIANCES REMOVE EXCESS GLUE UPON COMPLETION OF THE WORK

JOINTS, SCREW ATTACH TO DRAWER FACE. IN OPEN ASSEMBLY OF CABINETS ALL SURFACES

IN OPEN CABINET AREA SHALL FINISHED AS SPECIFIED. REFER TO ELEVATIONS AND DETAILS.

PROVIDE SHELF SUPPORTS, BRACKETS AND RECESSED SHELF STANDARDS AS SPECIFIED OR

PROVIDE 75mm (3") BORDER OF CARPENTER'S WHITE GLUE AT ALL EDGES AND SEAMS IN LAMINATE

CONFIRM SIZES OF KITCHEN EQUIPMENT BEFORE CONSTRUCTION OF MILLWORK. MILLWORK NOTES

CONSTRUCTION NOTES:

- PATCH AND MAKE GOOD EXISTING FLOOR SLAB PRIOR TO INSTALLATION OF NEW FLOORING. SCRAP ALL LOOSE FLOOR LEVELING COMPOUND, ADHESIVE ETC. PROVIDE NEW LEVELING COMPOUND AS REQUIRED TO FIX FLOOR DISCREPANCIES. NOTE CONTRACTOR IS NOT TO USE PERMANENT MARKER ON FLOOR TO PREVENT INK FORM BLEEDING INTO THE FLOOR. PATCH AND MAKE GOOD SLAB WHERE DOWEL HOLES FROM
- COORDINATE WORK THROUGHOUT RENOVATION AREA WITH MECHANICAL AND ELECTRICAL WORK.
- REMOVE ALL PROTRUDING WALL ELEMENTS PRIOR TO INSTALLATION ON NEW FURRING WALL, CAP AND REMOVE ANY ABANDONED SERVICES, PATCH AND MAKE GOOD RATED WALLS AND MISSING OR DAMAGED FIRESTOPPING PRIOR TO INSTALLING NEW FURRING
- EXISTING STUD WALL. PATCH ANY OPENINGS PRIOR TO CONSTRUCTING NEW WALL
- ALL FURNITURE AND APPLIANCES OSOI. LAYOUT SHOWN FOR ILLUSTRATION PURPOSES
- REFER TO MECHANICAL PLANS FOR NEW WATER SERVICE LINE. REFER TO ELECTRICAL DRAWINGS FOR NEW CONDUIT RUNS. RE AND RE FINISHES AS REQUIRED FOR NEW WATER LINE AND CONDUIT INSTALLATION. PATCH AND MAKE GOOD ALL FINISHES DISTURBED BY DEMOLITION ND RENOVATION ACTIVITIES. COORDINATE WORK WITH LANDLORD ON SITE. PROVIDE FLOOR AND WALL PROTECTION AS REQUIRED DURING RENOVATION AND DEMOLITION WORK
- MOP SINK. SEE PLUMBING DRAWINGS FOR SPECIFICATIONS. PROVIDE MOP HOOK AND SHELF AS SPEC'D. REFER TO MECHANICAL FOR EYEWASH LOCATION.
- WALLS AT PERIMETER OF RENOVATION AREA ARE TO EXTEND TO U/S OF DECK AND BE SEALED TO PREVENT AIR LEAKAGE
- UPPER MILLWORK SHELVING/CABINET C/W PLAM FINISH, FILLER TO BE USED TO ENCLOSE GAPS BEETWEEN CEILING AND WALLS. REFER TO ELEVATIONS AND DETAILS.
- REFER TO SPECIFICATIONS FOR INTERIOR SIGNAGE AT DOORS. COORDINATE WITH OWNER FOR EXACT PLACEMENT ON SITE.
- PROVIDE PLYWOOD WALL BACKING AROUND ENTIRE ROOM FROM 60" TO 84" AFF. SCHEDULE ROUGH-IN REVIEW WITH CLIENT AND CONSULTANT TO REVIEW DEVICE
- PLACEMENT PRIOR TO BOARDING WALL MOUNTED HAND HYGIENE SINK C/W WASHROOM ACCESSORIES. REFER TO ELEVATIONS FOR EXTENT OF PLYWOOD BACKING, REFER TO SPECIFICATIONS AND

LOCATION OF WASHROOM ACCESSORIES ON SITE WITH CLIENT.

PROVIDE PLYWOOD WALL BACKING OR SISMIC RESTRAIN FOR TALL STORAGE CABINETS OR WALL MOUNT CABINETS OR EQUIPMENT THAT MAY REQUIRE.

EQUIPMENT LIST FOR EXTENT OF WASHROOM ACCESSORIES. COORDINATE FINAL

- CORRIDORS TO HAVE HAND RAILS AND BUMPER PROTECTION AS PER SPEC AND TO BE AS
- ACCESSIBLE WALL MOUNTED SINK AND CARRIER C/W WASHROOM ACCESSORIES. REFER TO ELEVATIONS AND GENERAL SHEETS FOR DETAILED INFORMATION AND SPECS. REFER TO SPECIFICATIONS AND OWNERS EQUIPMENT LIST FOR OSOL OSCI. AND CSCI ITEMS. PROVIDE GRAB BARS AS INDICATED ON PLANS AND ELEVATIONS. PROVIDE PLYWOOD BACKING AT SINK FOR WALL MOUNTED ACCESSORIES
- ACCESSIBLE FLOOR MOUNTED TOILET (REFER TO MECHANICAL DRAWINGS FOR FIXTURE TYPE) C/W WASHROOM ACCESSORIES. REFER TO ELEVATIONS AND GENERAL SHEETS FOR DETAILED INFORMATION AND SPECS. REFER TO SPECIFICATIONS AND OWNERS EQUIPMENT LIST FOR OSOI, OSCI, AND CSCI ITEMS. PROVIDE PLYWOOD BACKING FOR WALL MOUNTED ACCESSORIES
- WALL MOUNTED OSCI PPE DISPENSER. PROVIDE PLYWOOD BACKING.
- WALL MOUNTED COAT HOOK. PROVIDE PLYWOOD BACKING.
- FOR ITEMS TO BE MOUNTED ON EXISTING WALLS WHEN BACKING IS NOT POSSIBLE. PROVIDE HIGH DENSITY POLYETHYLENE BOARD 12.5mm SURFACE MOUNTED. COORDINATE ON SITE WITH OWNER FOR HEIGHTS AND FINAL LOCATION

FINISH NOTES:

- THE THESE DRAWINGS SHALL BE READ IN CONJUNCTION WITH THE FINISH SPECIFICATION, SCHEDULES AND ALL PLANS FLEVATIONS AND SECTIONS ANY CONTRADICTORY INFORMATION AND SITUATIONS SHOULD BE BROUGHT TO THE ATTENTION OF THE
- CONSULTANT PRIOR TO PROCEEDING WITH A TASK WHERE COLOR OR EXTENT OF FINISH IS IN QUESTION, CONTACT DESIGN CONSULTANT FOR CLARIFICATION
- PRIOR TO PROCEEDING NO SUBSTITUTIONS FOR THE SPECIFIED MANUFACTURER SHALL BE MADE WITHOUT PRIOR WRITTEN APPROVAL
- OF THE DESIGN CONSULTANT. USE THE LARGEST CONTINUOUS PIECE OF MATERIAL, AS PROVIDED BY MANUFACTURED, TO COMPLETE INSTALLATION OF EACH FINISH, ALL FINISHES AND MATERIALS ARE TO BE INSTALLED BY QUALIFIED AND
- EXPERIENCED TRADE WORKERS AS PER MANUFACTURERS' RECOMMENDATIONS. ALL NOTES REFER TO FINISHING OF AREAS IN CONTRACT AND IN ALL AREAS WHERE CONSTRUCTION AND DEMOLITION ACTIVITIES HAVE AFFECTED THE EXISTING FINISHES. REFINISHING IS NOT REQUIRED TO AREAS NOT
- IN CONTRACT UNLESS NOTED OTHERWISE. ALL EXISTING WALLS ARE TO BE PATCHED AND REPAIRED PRIOR TO NEW FINISH.
- PAINT INDICATIONS FOR PERIMETER WALLS INCLUDE BULKHEAD, DRYWALL COLUMNS, AND DRYWALL SILLS, UNLESS NOTED OTHERWISE, FINISH NOTES ALL PAINTED PARTITIONS TO HAVE COMPLETE COVERAGE AND RECEIVE A MINIMUM OF ONE PRIMER COAT AND TWO TOP COATS-PREMIUM LATEX OF THE PRODUCT SPECIFIED. DARKER COLORS TO RECEIVE ADDITIONAL
- COATS AS REQUIRED TO ACHIEVE UNIFORM COLOR APPEARANCE. PAINTED GYPSUM BOARD CEILINGS TO RECEIVE ONE COAT PRIMER, TWO FINISH COATS, FLAT, UNLESS NOTED OTHERWISE
- PAINTED DOORS AND FRAMES TO RECEIVE ONE COAT PRIMER/SEALER, TWO COATS ALKYD PAINT, SEMI-GLOSS. ALL MECHANICAL GRILLES, ETC. TO BE PAINTED TO MATCH CEILING UNLESS NOTED OTHERWISE.
- REFER TO SPECIFICATIONS FOR ADDITIONAL INFORMATION AND/OR INSTRUCTION ON PREPARATION, ADHESIVES,
- AND SEALERS, ETC. FOR MATERIALS INDICATED ON THE FINISHES DRAWING. CONTRACTOR TO ENSURE FLOOR IS SMOOTH AND LEVEL FOR NEW FINISHES PRIOR TO INSTALLATION. PREPARE
- EXISTING FLOOR TO RECEIVE NEW FINISH. WHERE SHEET GOODS ARE BEING INSTALLED, SUBFLOOR TO BE WELL PREPARED SO SUBFLOOR WILL NOT
- ALL FLOOR FINISHES TO BE FLUSH WITH COLUMNS, BUILDING PERIMETER, AND INTERIOR WALLS. FLOORING CONTRACTROR TO COORDINATE INSTALLATION WITH MILLWORK INSTALLER.
- FEATHER FLOOR TO ENSURE SMOOTH TRANSITION BETWEEN DISSIMILAR FLOOR FINISHES. INSTALL TRANSITION STRIPS AS NOTED.
- ALL CHANGES IN FLOOR FINISHES SHALL BE CENTERED IN DOORWAYS, UNLESS NOTED OTHERWISE. INSTALL RUBBER BASE RB-1, INCLUDING COLUMNS AND BENEATH INDUCTION UNITS. UNLESS NOTED OTHERWISE.
- ALL FLOOR FINISHES SHALL EXTEND UNDER MILLWORK/CABINETS TO FACE OF TOE KICK. WHERE EQUIPMENT ON FLOOR CAN BE REMOVED. FLOOR FINISH TO EXTEND INTO RECESS OR CAVITY TO FACE OF WALL
- ALL MISCELLANEOUS METALS, TRIMS, ETC. ON WALLS TO BE PAINTED TO MATCH ADJACENT WALL SURFACE

PARTITION NOTES:

- ANY CONTRADICTORY INFORMATION AND SITUATIONS SHOULD BE BROUGHT TO THE ATTENTION OF THE CONSULTANT PRIOR TO PROCEEDING WITH A TASK.
- PROVIDE SOUND TRAPS AT RETURN AIR OPENINGS IN PARTITIONS EXTENDING ABOVE THE CEILING LINE TO THE DECK AND FIRE DAMPERS FOR ALL FIRE RATED PARTITIONS. COORDINATE WITH MECHANICAL DWGS. CONTRACTOR MUST SEAL ALL OPENINGS. WHETHER BY STRUCTURAL, MECHANICAL OR $\,\,$ ELECTRICAL IN THE FLOOR OR FIRE RATED PARTITION, WITH A FIRE BARRIER MATERIAL EQUAL TO THAT BEING PENETRATED.
- CONSTRUCT NEW PARTITIONS DIRECTLY FROM STRUCTURAL FLOOR. ALL PARTITIONS ARE TO BE TAPED, FILLED, & SANDED SMOOTH TO RECEIVE NEW FINISHES. CONSTRUCTION FOR ALL PARTITION TYPES MUST MAINTAIN ACOUSTICAL INTEGRITY OF THE PARTITION. DO NOT PUNCTURE MULLION TO ANCHOR PARTITIONS.
- PROVIDE ADEQUATE BRACING AND/OR BLOCKING IN PARTITIONS AS INDICATED ON PLANS, TO SUPPORT WALL HUNG MILLWORK, SHELVING, COAT HOOKS, AND ACCESSORIES SHALL BE CENTERED ON LENGTH OF PARTITIONS, FULL WIDTH, PROVIDE DEFLECTION TRACKS AT TOP OF ALL FULL HEIGHT AND/OR FIRE RATED INTERIOR PARTITIONS TO ALLOW
- FOR 25MM DEFLECTION REVO CLIPS OR EQUAL MUST BE USED TO ADHERE ALL NEW PARTITIONS TO T-BAR. UNDER NO
- THE EXISTING WALL & TRANSITION IS TO BE FINISHED TO POINT OF NO PERCEIVED CHANGE IN WALL TYPES. CONSTRUCTION FOR ALL PARTITION TYPES MUST MAINTAIN ACOUSTICAL INTEGRITY OF THE PARTITION.
- CIRCUMSTANCES SHALL PARTITIONS BE SCREWED INTO T-BAR. WHERE NEW PARTITIONS JOIN AT THE END OF AN EXISTING WALL, GWB SHALL BE ALIGNED IN THE SAME PLANE AS

CEILING NOTES:

- THE REFLECTED CEILING PLAN IS PROVIDED FOR CEILING TYPES AND LOCATIONS OF LIGHT FIXTURES ONLY AND SHALL BE READ IN CONJUNCTION WITH MECHANICAL AND ELECTRICAL DRAWINGS.
- REFER TO MECHANICAL & ELECTRICAL DRAWINGS FOR EXACT LOCATIONS OF MECHANICAL & ELECTRICAL COMPONENTS.
- ANY CONTRADICTORY INFORMATION AND SITUATIONS SHOULD BE BROUGHT TO THE ATTENTION OF THE
- CONSULTANT PRIOR TO PROCEEDING WITH A TASK. IF T-BAR MODIFICATION IS REQUIRED TO SUIT SLAB TO SLAB PARTITIONS, MODIFICATION SHALL BE INCLUDED IN
- WORK. REPLACE ALL DAMAGED MAIN TEES AND CROSS TEES, TO MATCH EXISTING AND CLEAN SOILED TEES.
- REUSE SALVAGED SUSPENDED T-BAR SYSTEM AND ACOUSTIC CEILING TILES, SALVAGE LIGHT
- FIXTURES WHERE INDICATED/OR AS SPECIFIED BY THE CONSULTANTS. REPLACE/RELOCATE ALL DAMAGED, SOILED, OR DISCOLORED ACOUSTIC TILE TO MAINTAIN OVERALL UNIFORM APPEARANCE THROUGHOUT TO THE SATISFACTION OF THE DESIGN CONSULTANT.
- PAINT ALL EXPOSED CEILINGS INCLUDING CONCRETE COFFERS, CONCRETE ROOF JOIST, CABLE TRAYS, ACCESS PANELS. AND GYPSUM BOARD CEILINGS AND BULKHEADS. UNLESS NOTED OTHERWISE. ONE COAT PRIMER & TWO COATS TOP COAT, FLAT FINISH.
- PAINT ALL CEILING MOUNTED ACCESS PANELS AND GRILLES SAME AS ADJACENT CEILING UNLESS ALL MISCELLANEIOUS METALS, TRIMS ON CEILING ETC. TO BE PAINTED TO MATCH ADJACENT CEILING SURFACE.

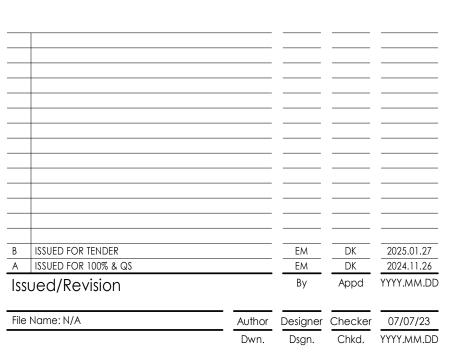
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Consultant





Permit/Seal



Client/Project Logo



Client/Project Northern Health

Project No.

Revision

144320012

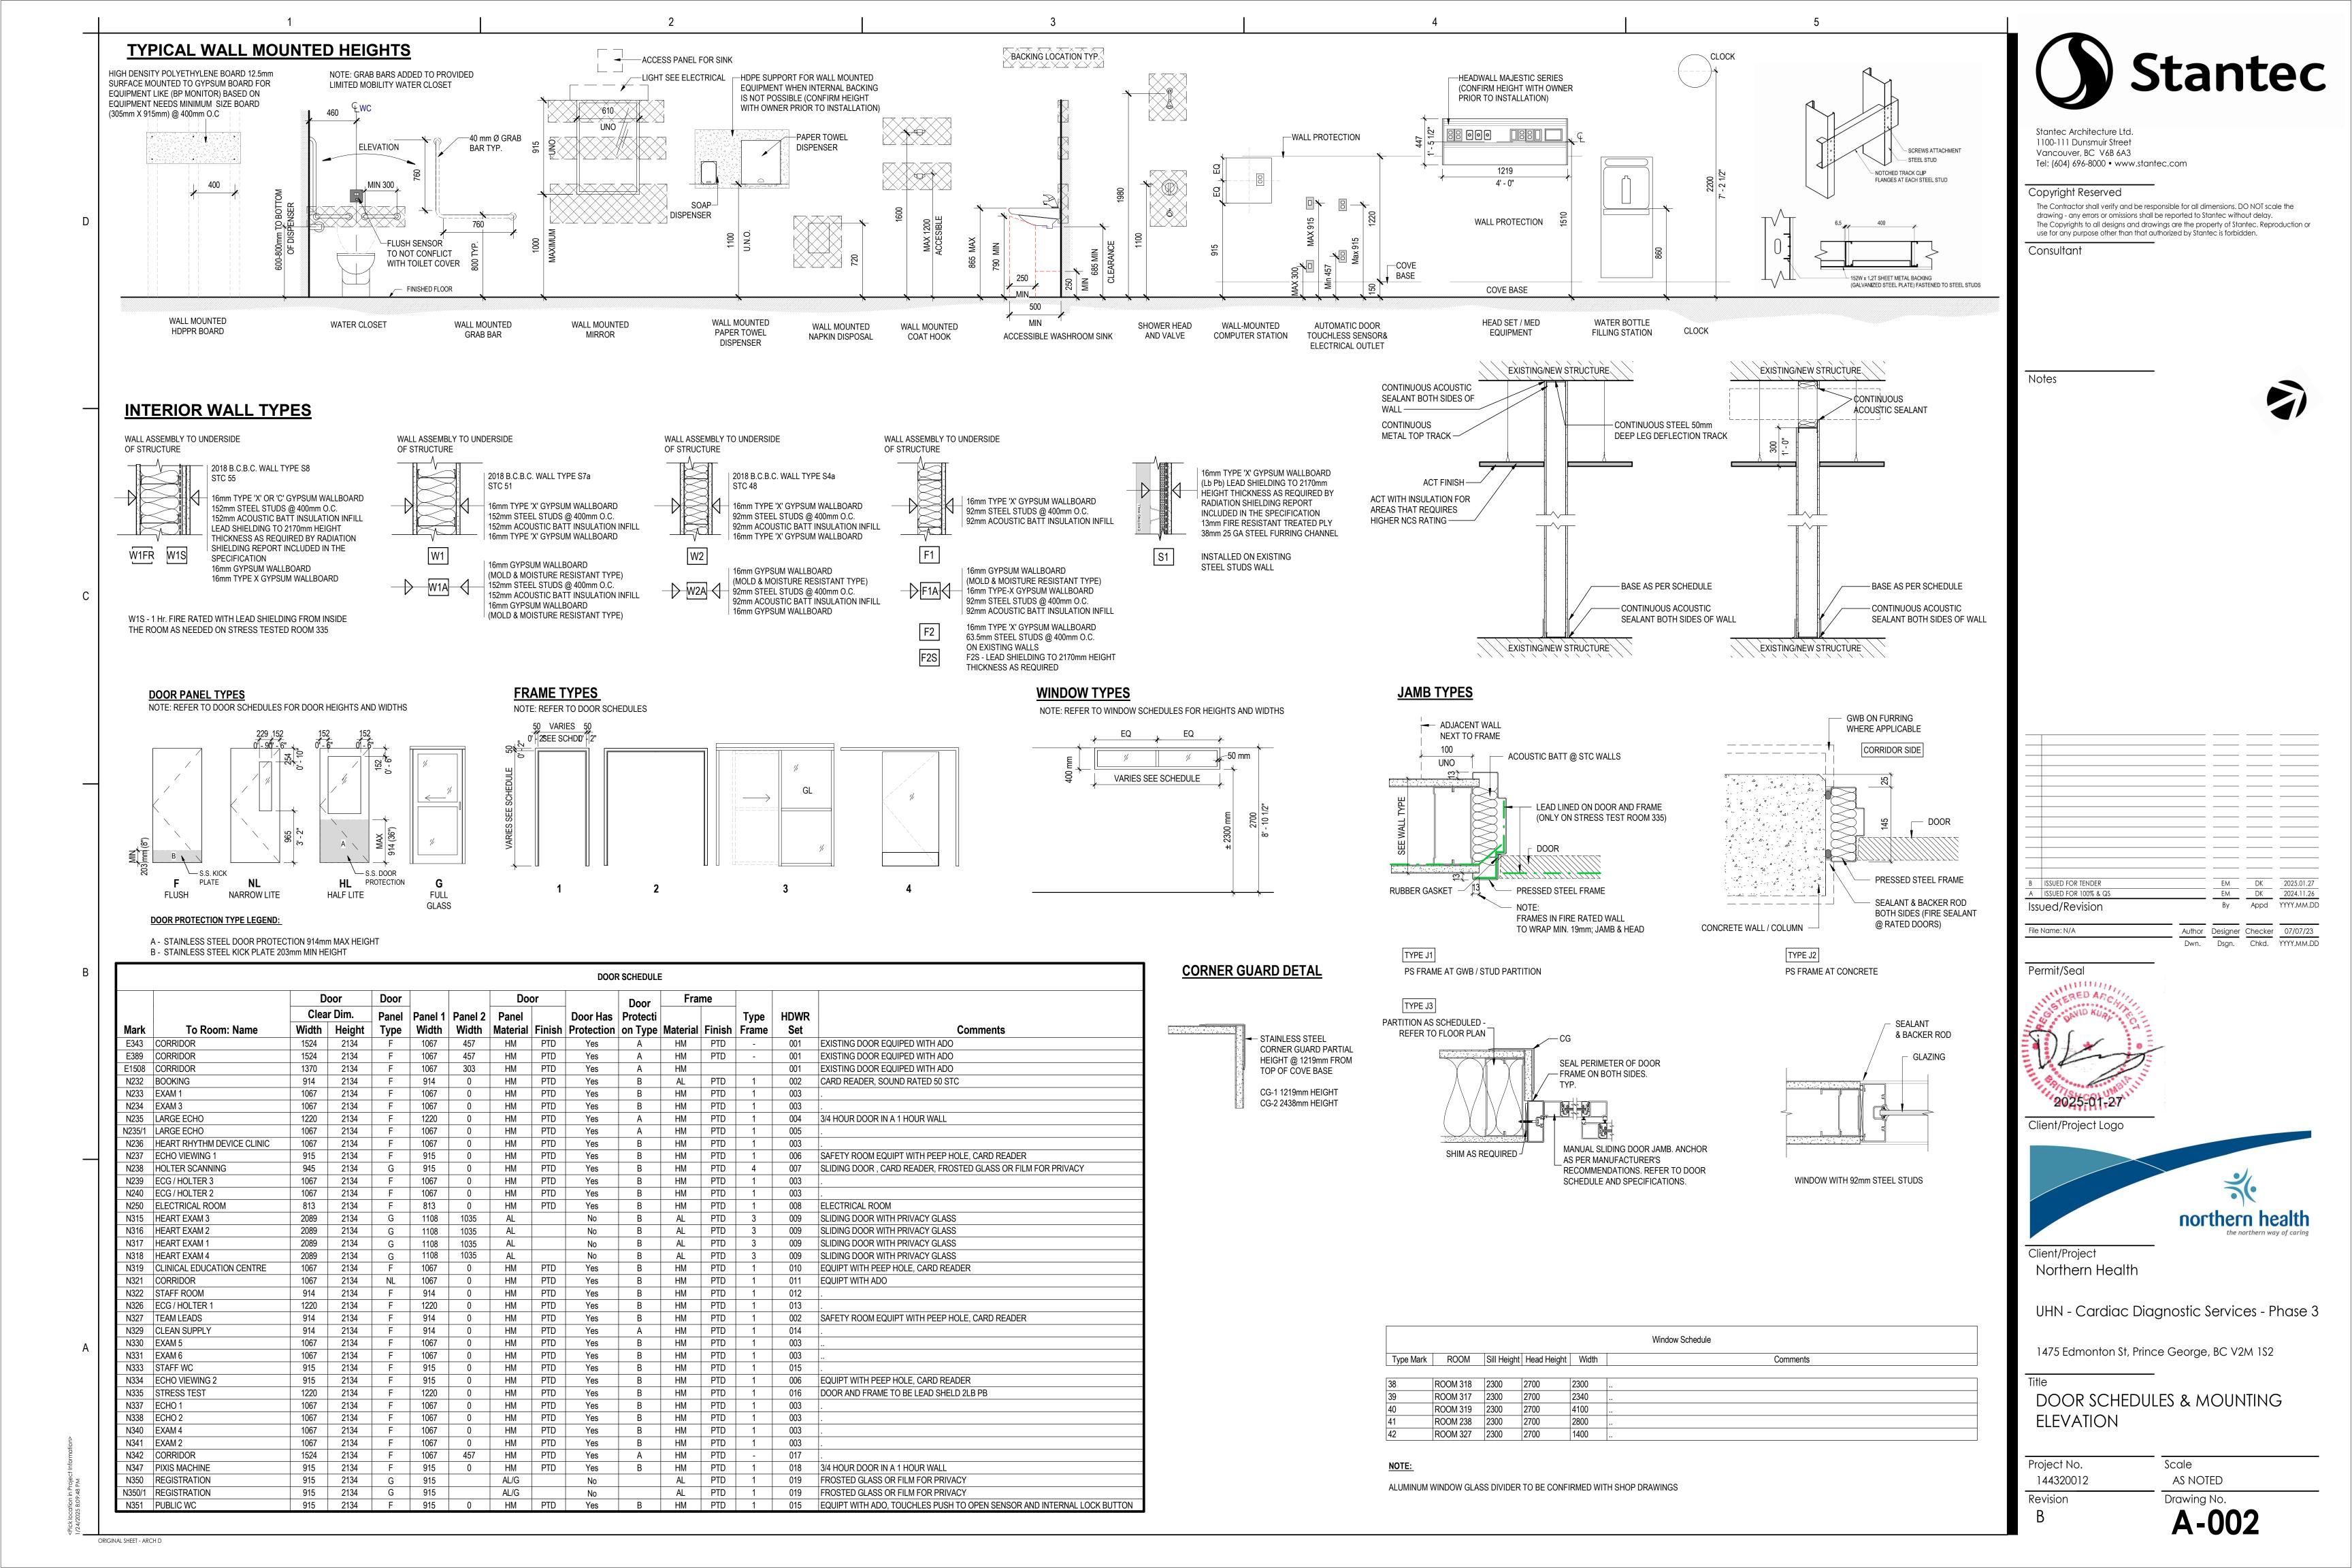
UHN - Cardiac Diagnostic Services - Phase 3

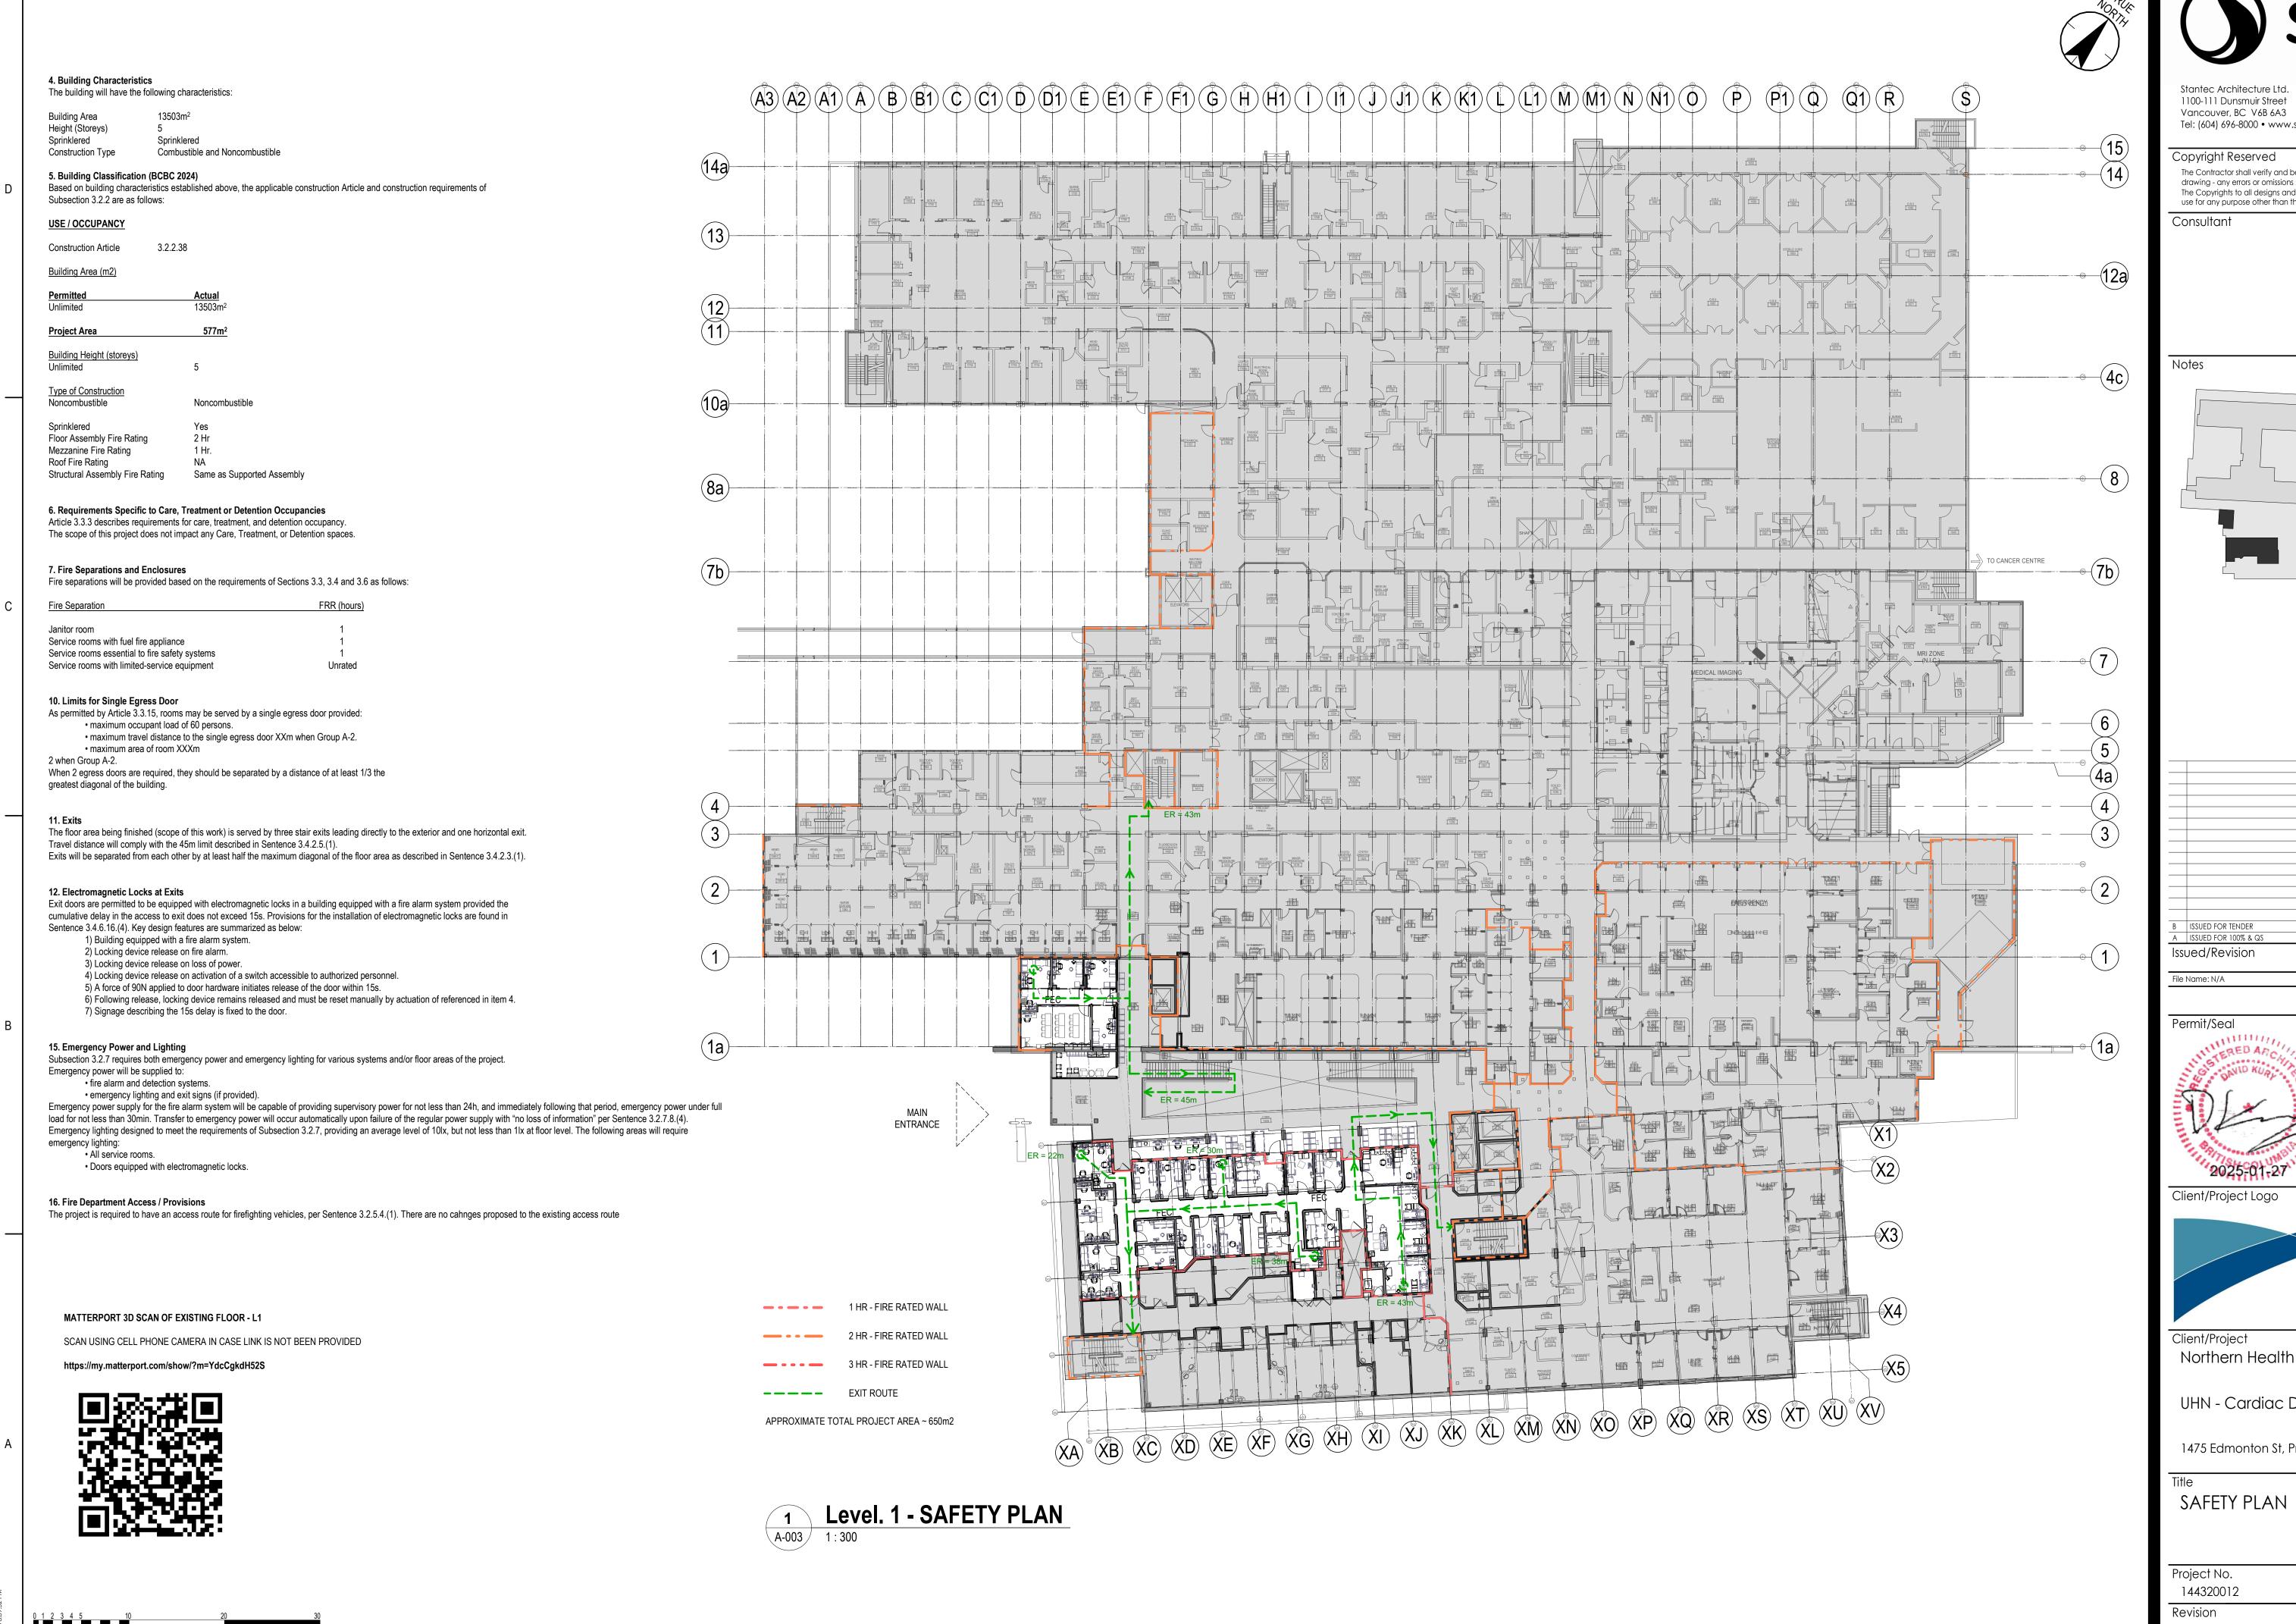
1475 Edmonton St, Prince George, BC V2M 1S2

GENERAL NOTES, SYMBOLS, **ABBREVIATIONS**

> Scale AS NOTED

Drawing No.





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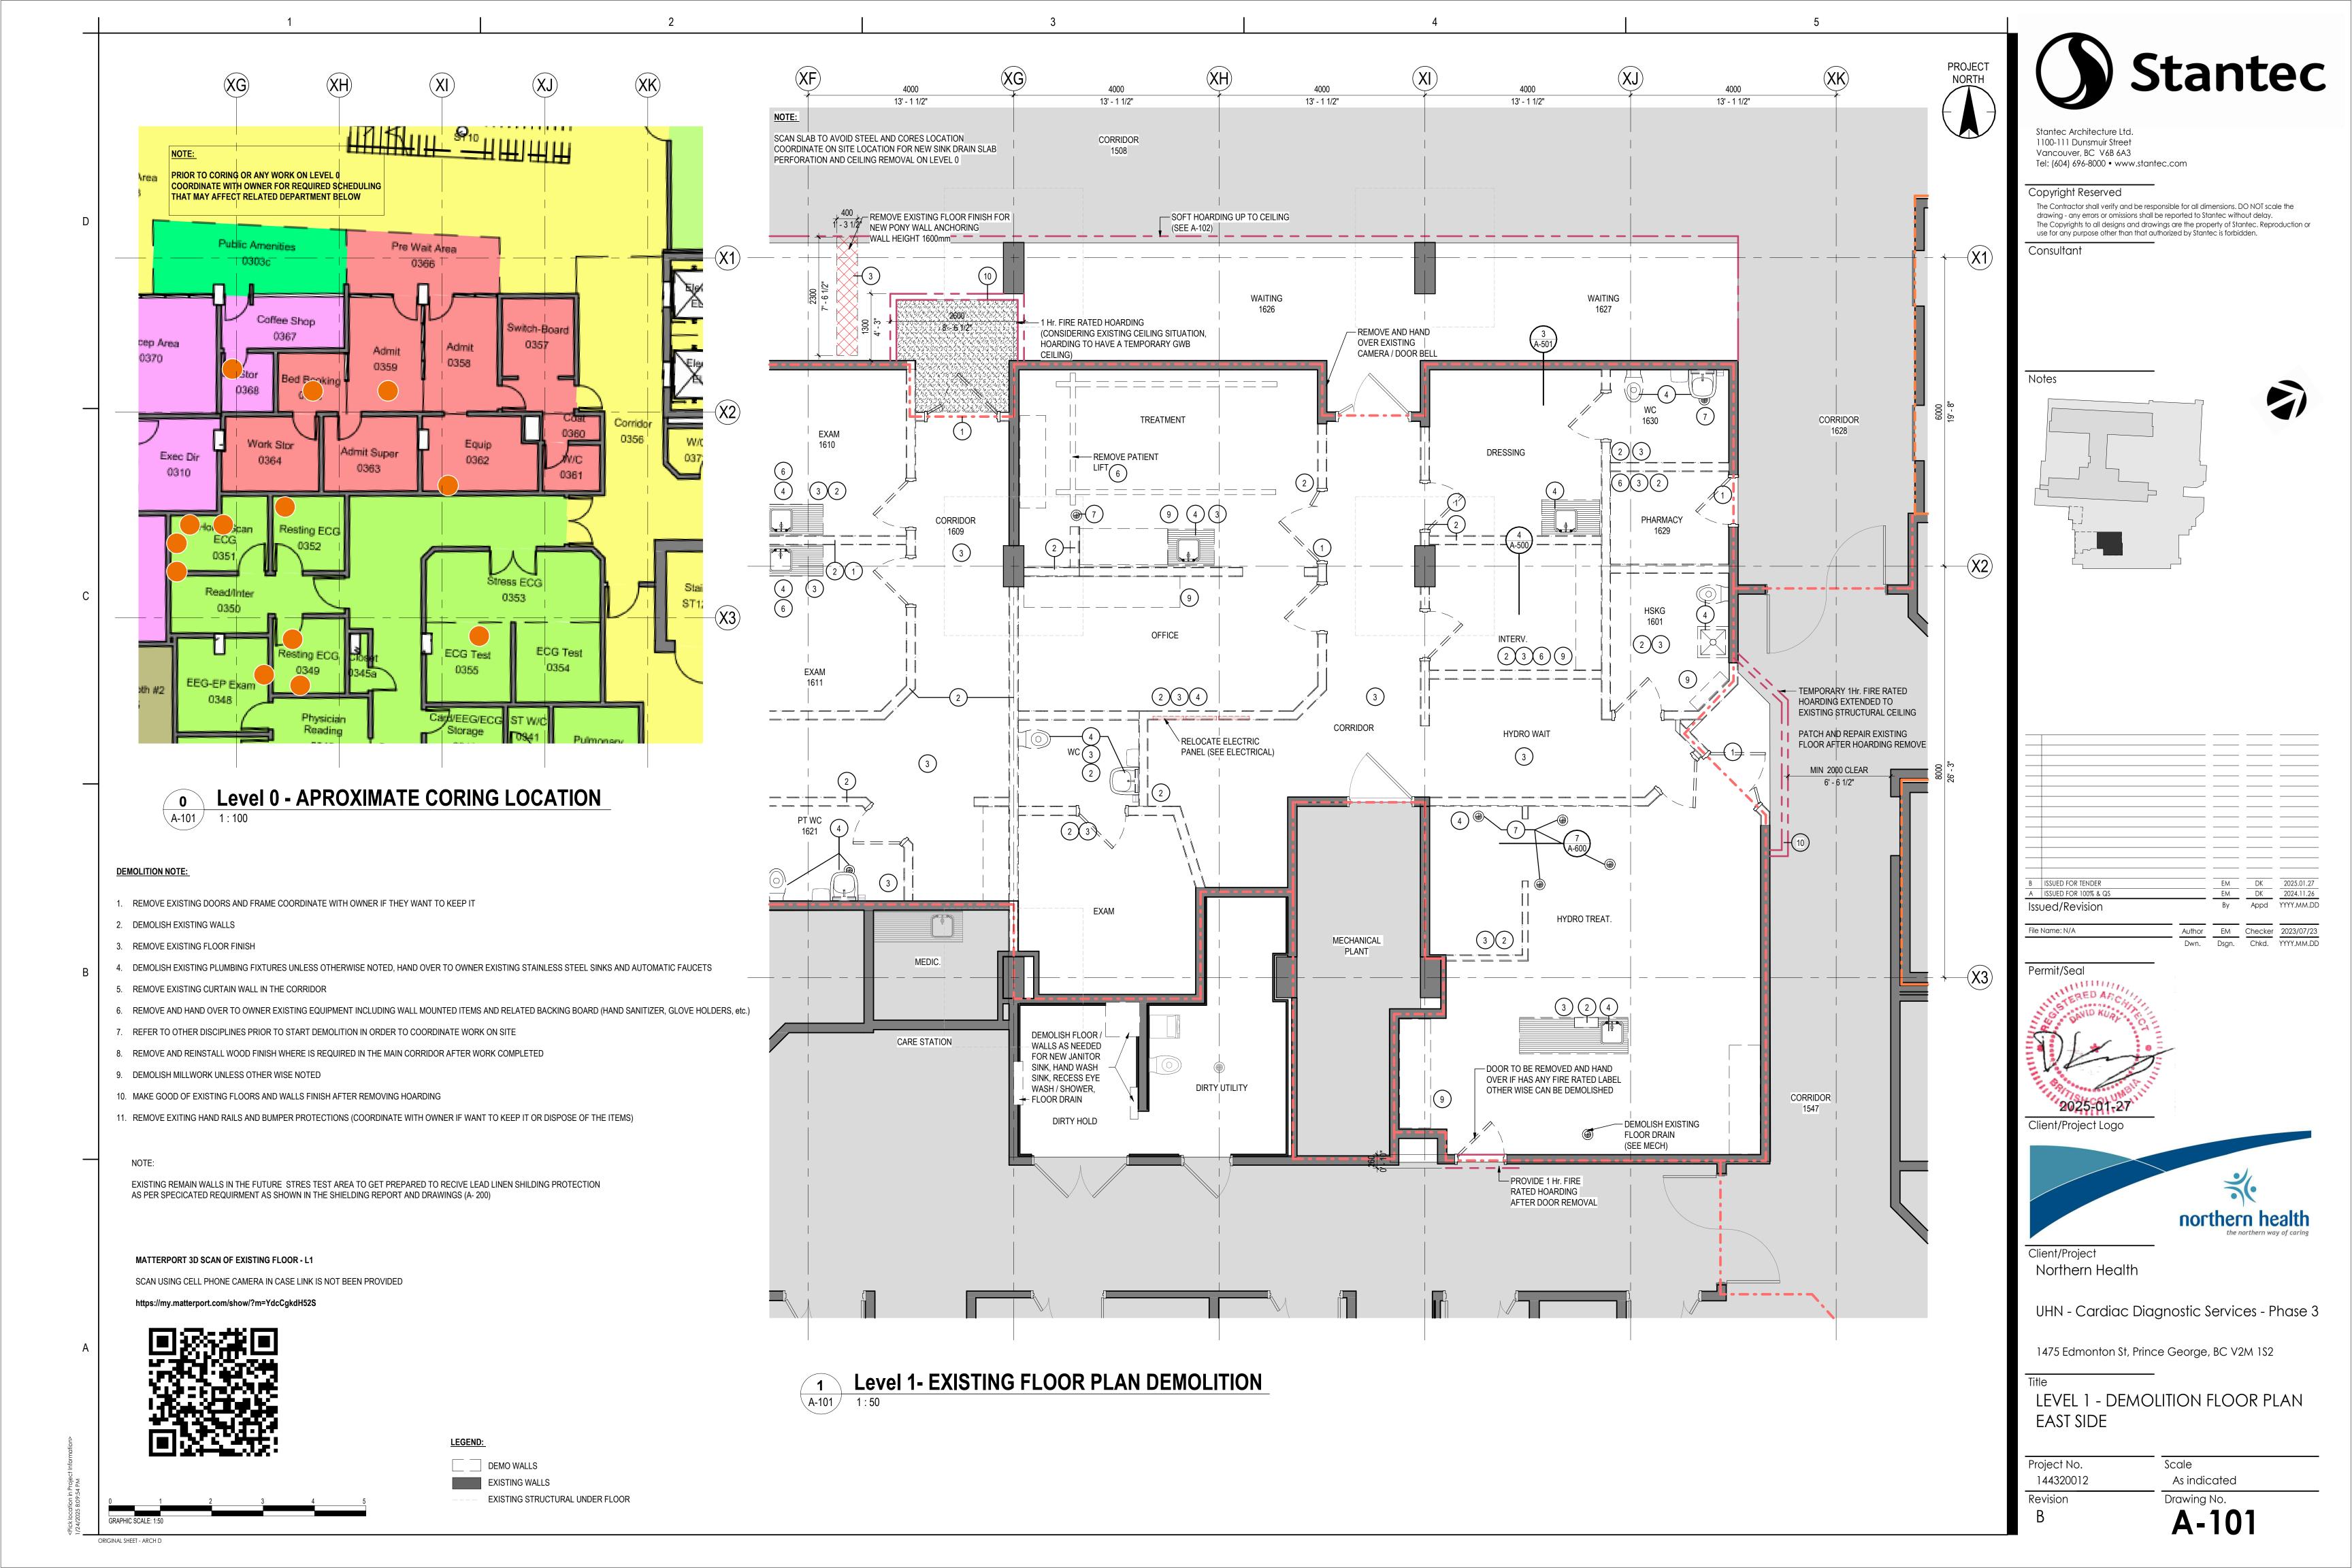


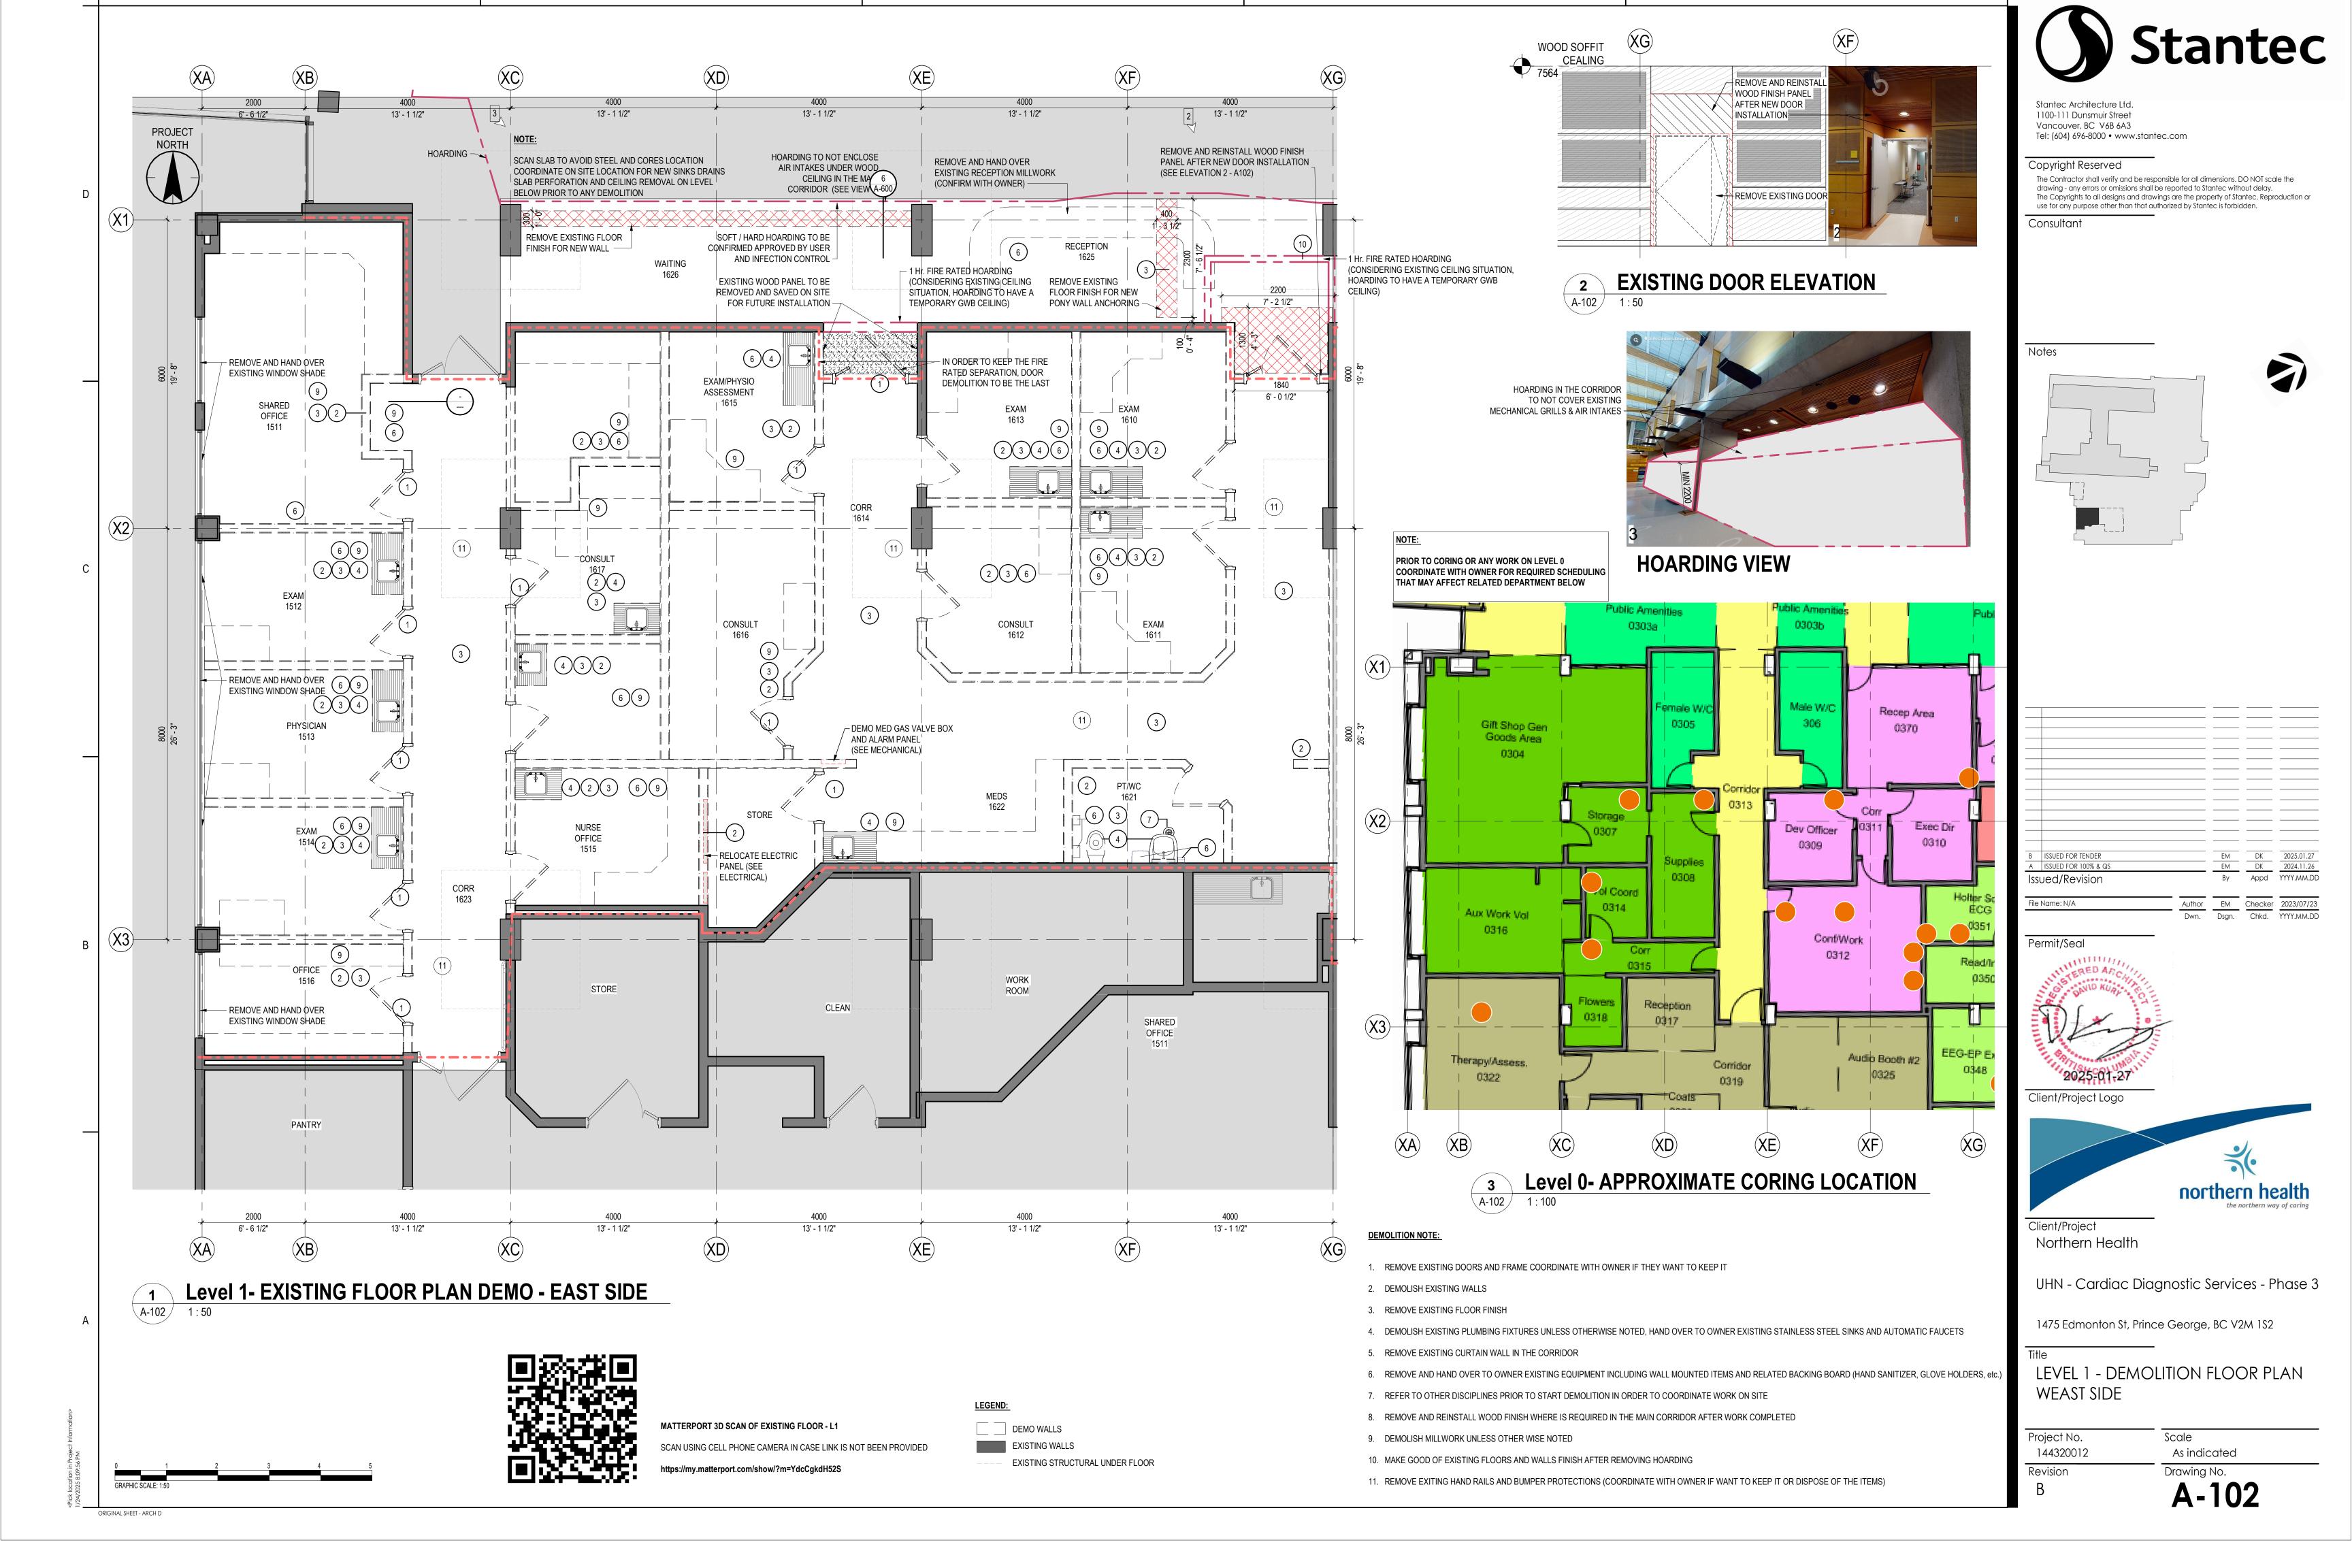
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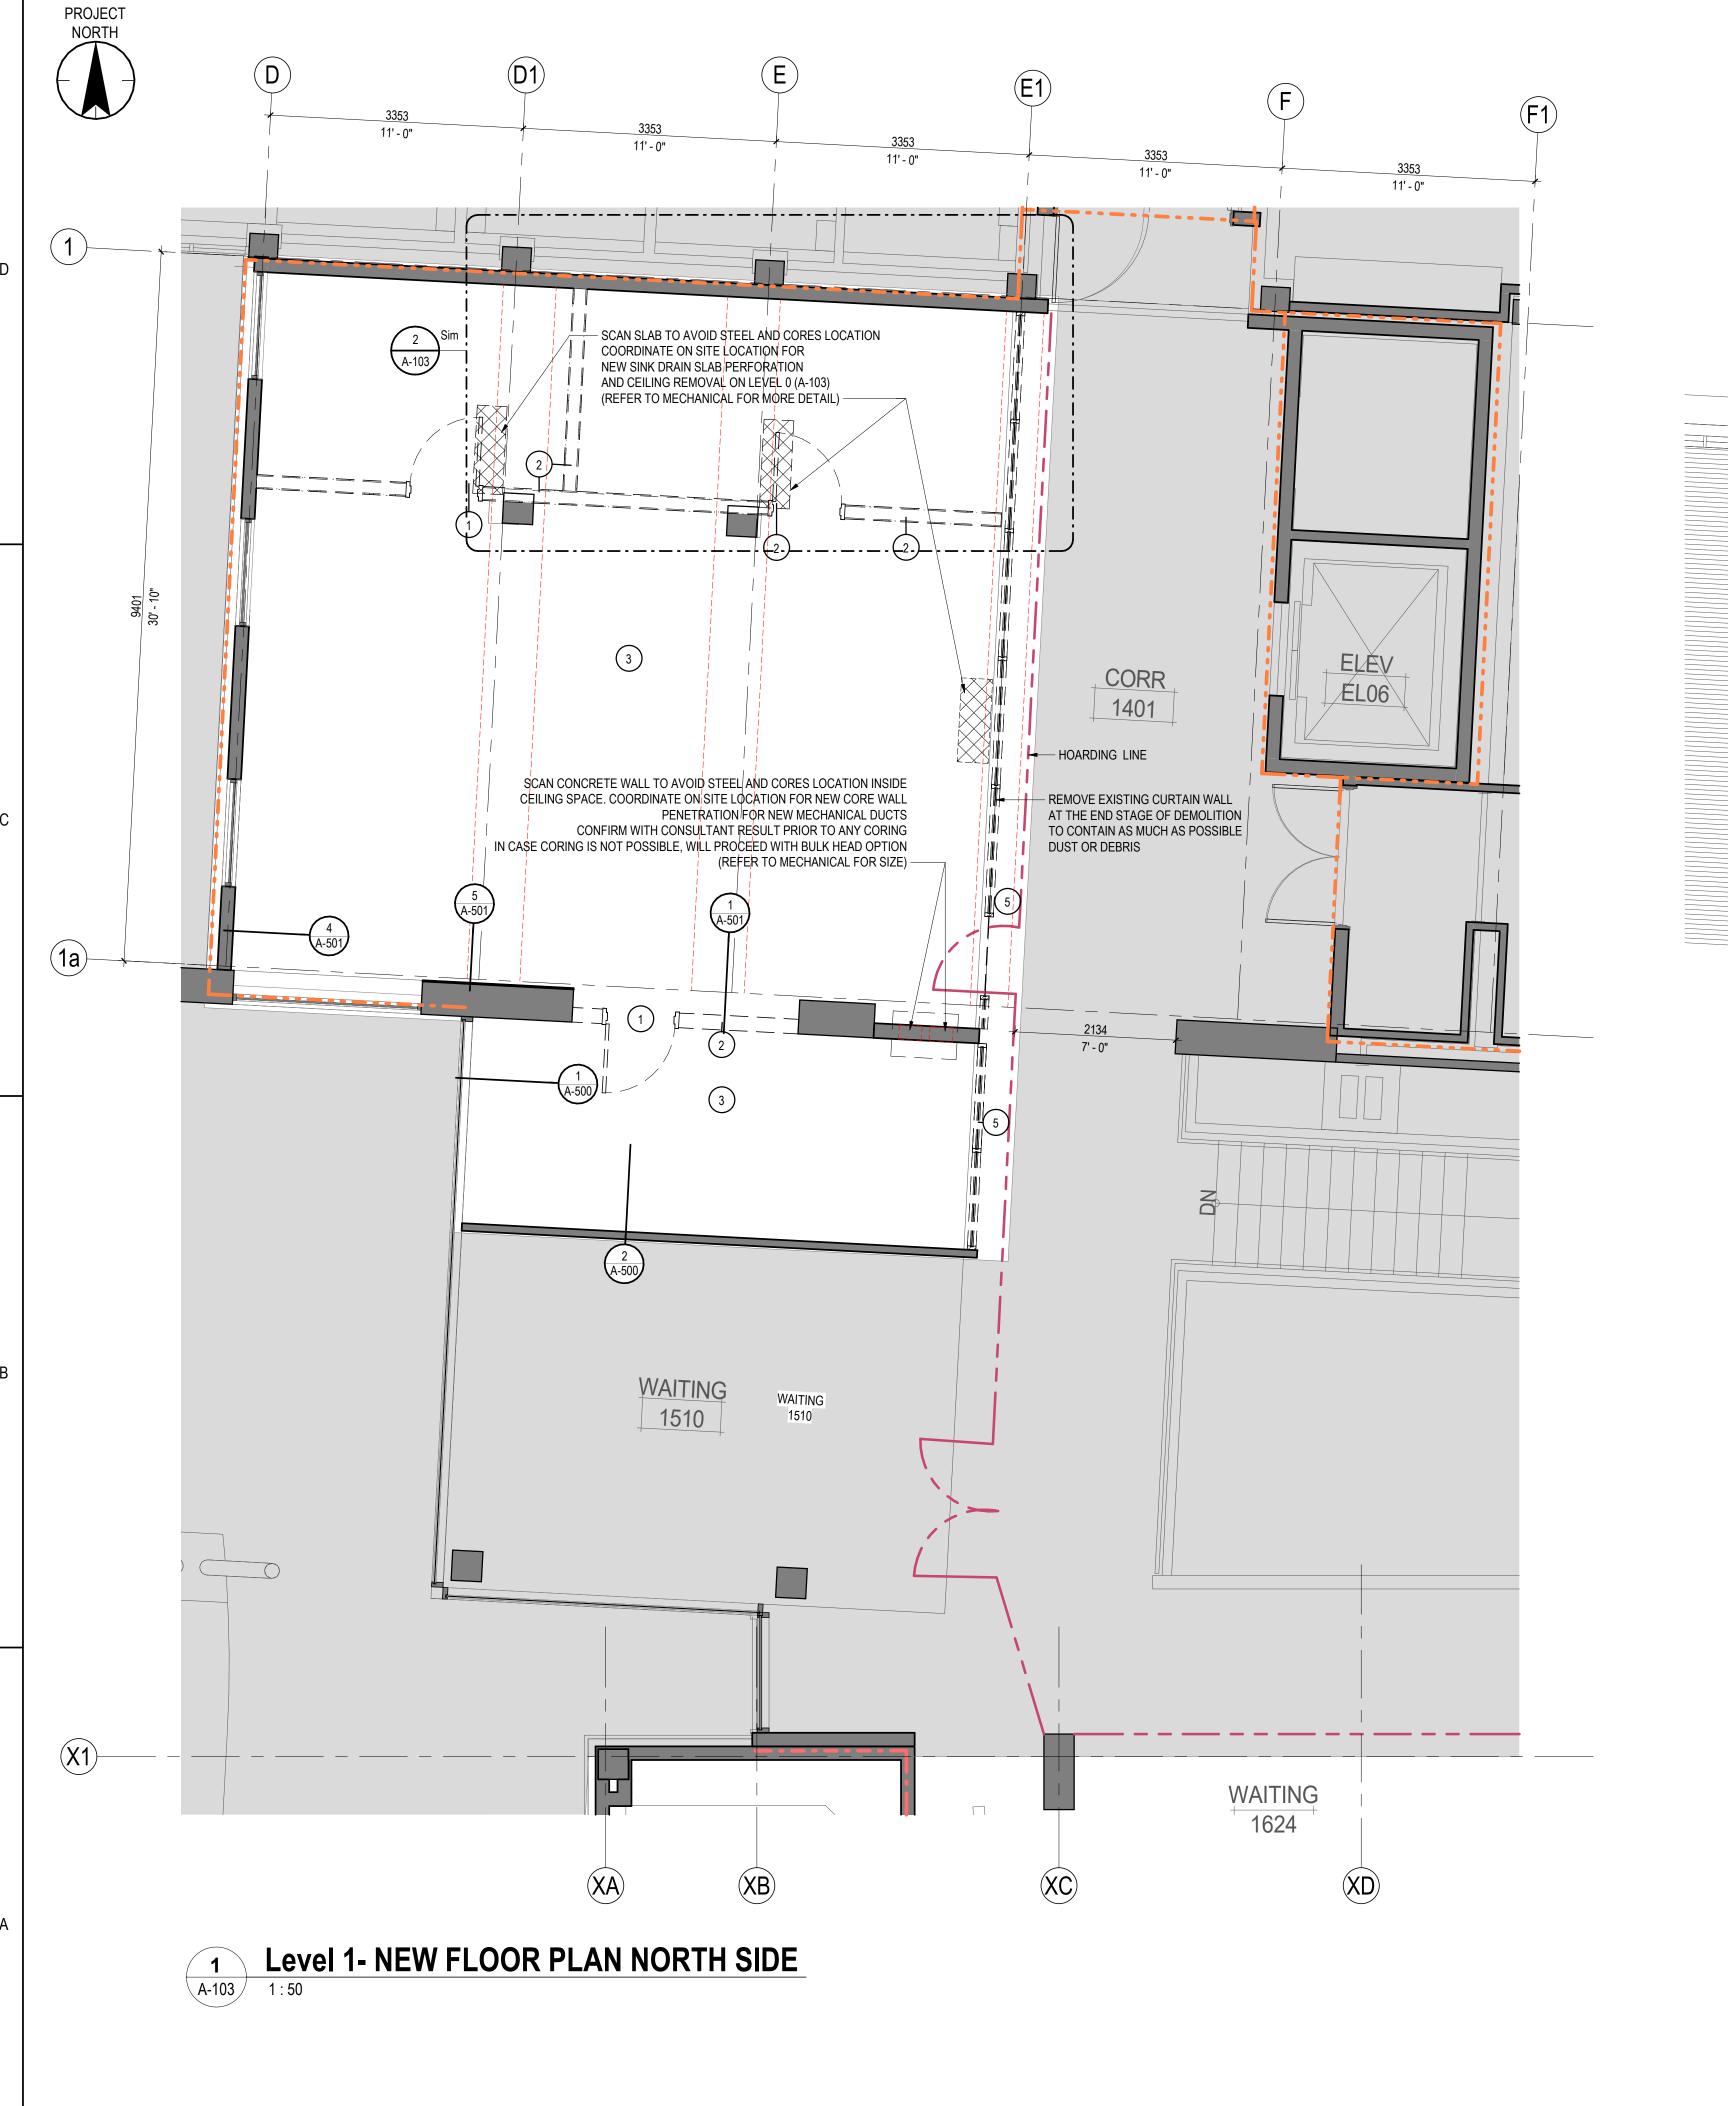
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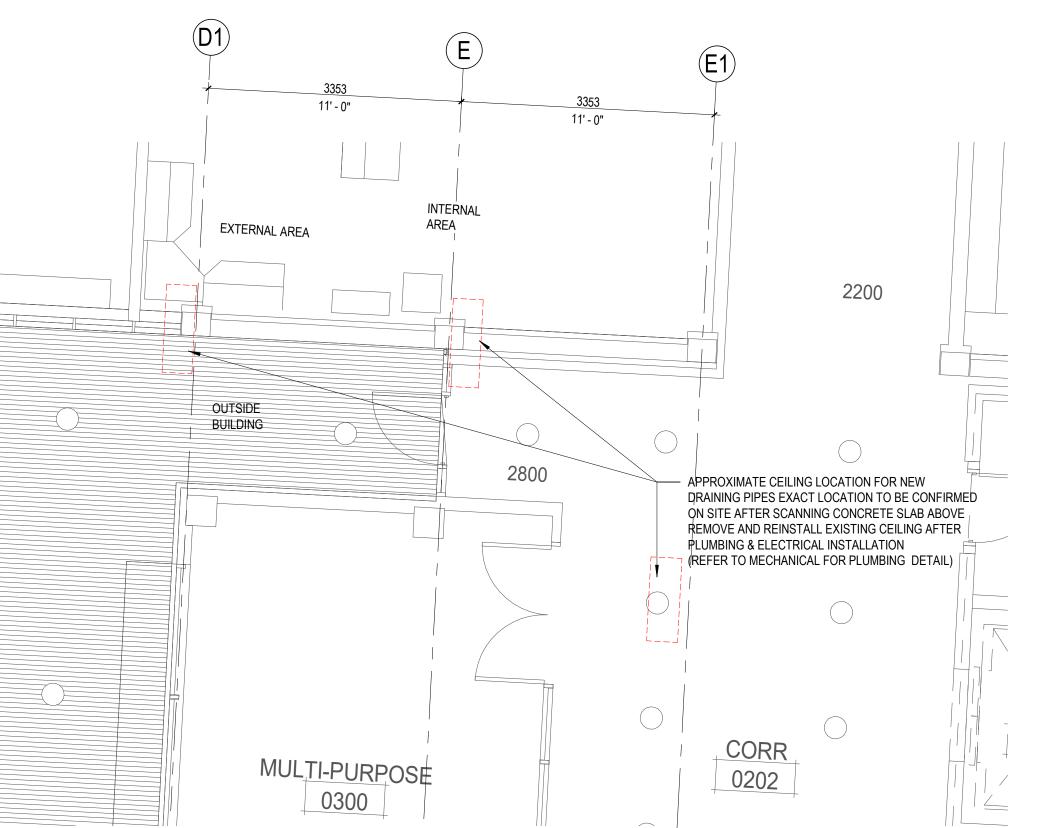
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ORIGINAL SHEET - ARCH D









Level 0 - APPROXIMATE CORING LOCATIONS A-103

LEGEND:

DEMO WALLS EXISTING WALLS

EXISTING STRUCTURAL UNDER FLOOR

DEMOLITION NOTE:

- 1. REMOVE EXISTING DOORS AND FRAME COORDINATE WITH OWNER IF THEY WANT TO KEEP IT
- 2. DEMOLISH EXISTING WALLS
- 3. REMOVE EXISTING FLOOR FINISH
- 4. DEMOLISH EXISTING PLUMBING FIXTURES UNLESS OTHERWISE NOTED, HAND OVER TO OWNER EXISTING STAINLESS STEEL SINKS AND AUTOMATIC FAUCETS
- 5. REMOVE EXISTING CURTAIN WALL IN THE CORRIDOR
- 6. REMOVE AND HAND OVER TO OWNER EXISTING EQUIPMENT INCLUDING WALL MOUNTED ITEMS AND RELATED BACKING BOARD (HAND SANITIZER, GLOVE HOLDERS, etc.)
- 7. REFER TO OTHER DISCIPLINES PRIOR TO START DEMOLITION IN ORDER TO COORDINATE WORK ON SITE
- 8. REMOVE AND REINSTALL WOOD FINISH WHERE IS REQUIRED IN THE MAIN CORRIDOR AFTER WORK COMPLETED
- 9. DEMOLISH MILLWORK UNLESS OTHER WISE NOTED
- 10. MAKE GOOD OF EXISTING FLOORS AND WALLS FINISH AFTER REMOVING HOARDING
- 11. REMOVE EXITING HAND RAILS AND BUMPER PROTECTIONS (COORDINATE WITH OWNER IF WANT TO KEEP IT OR DISPOSE OF THE ITEMS)

MATTERPORT 3D SCAN OF EXISTING FLOOR - L1

SCAN USING CELL PHONE CAMERA IN CASE LINK IS NOT BEEN PROVIDE



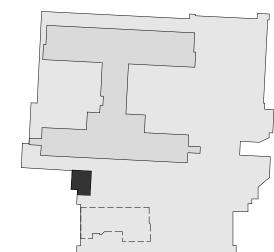


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File Name: N/A



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LEVEL 1 - DEMOLITION FLOOR PLAN NORTH SIDE

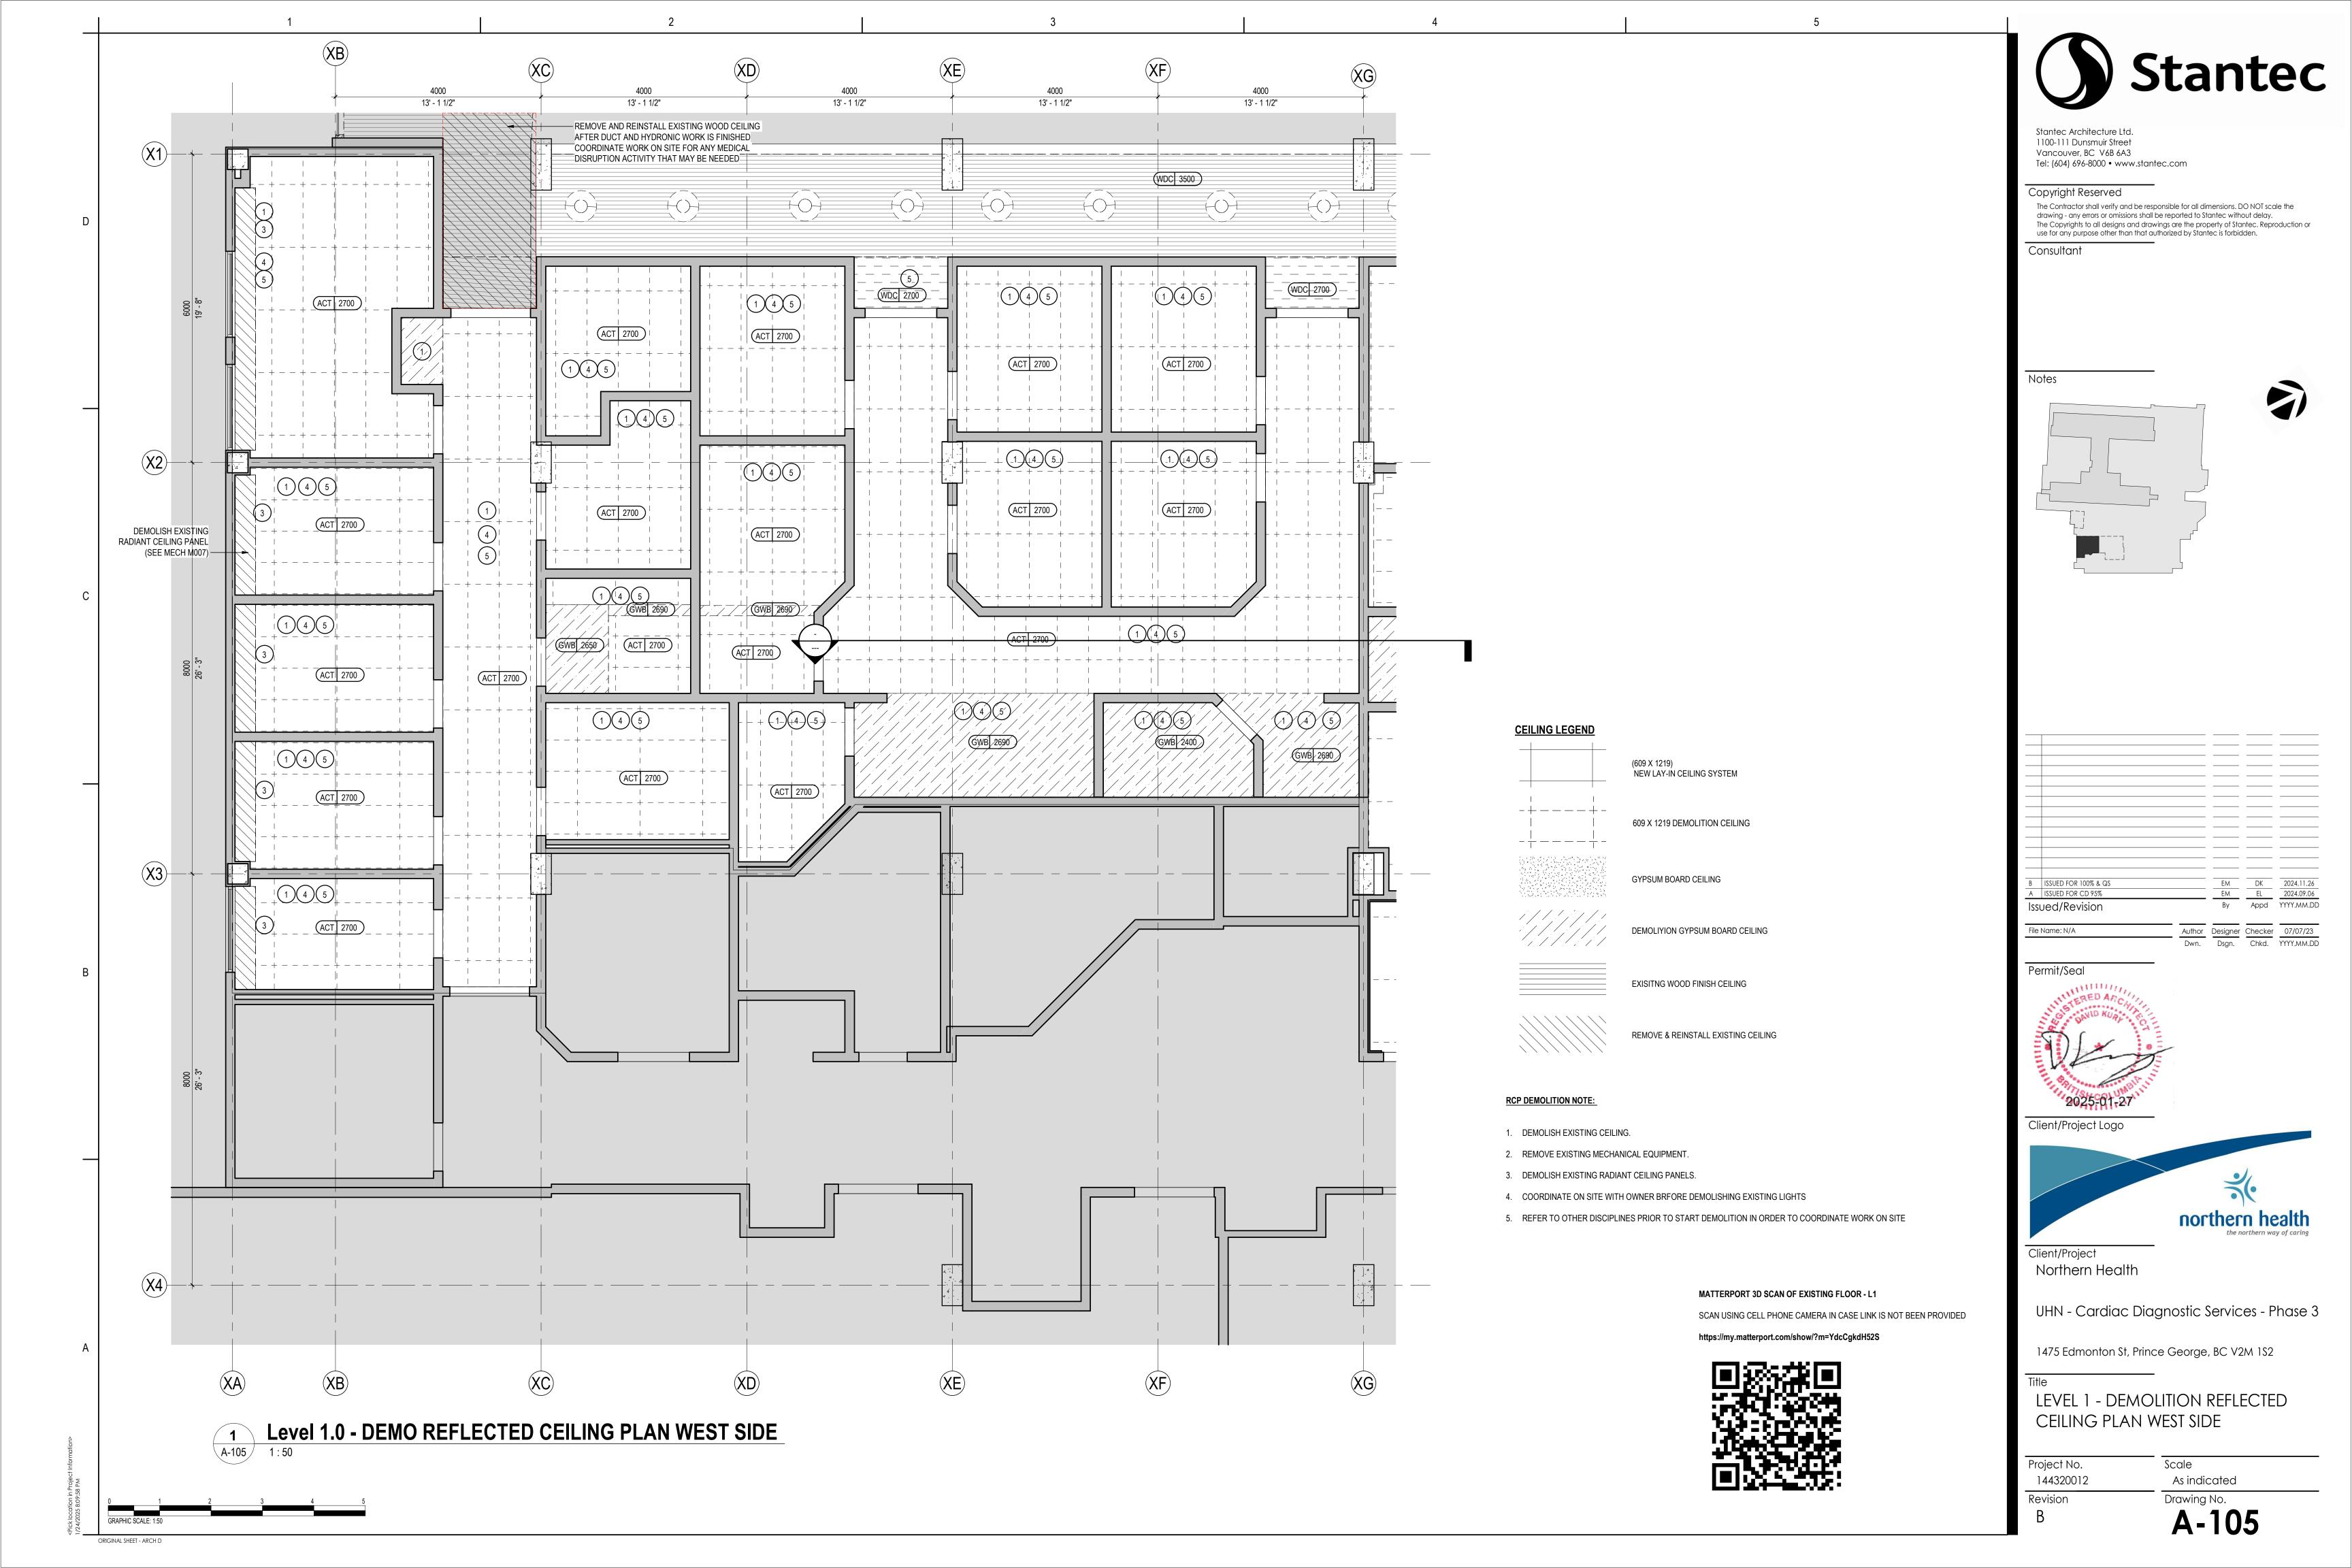
Project No. 144320012 Revision

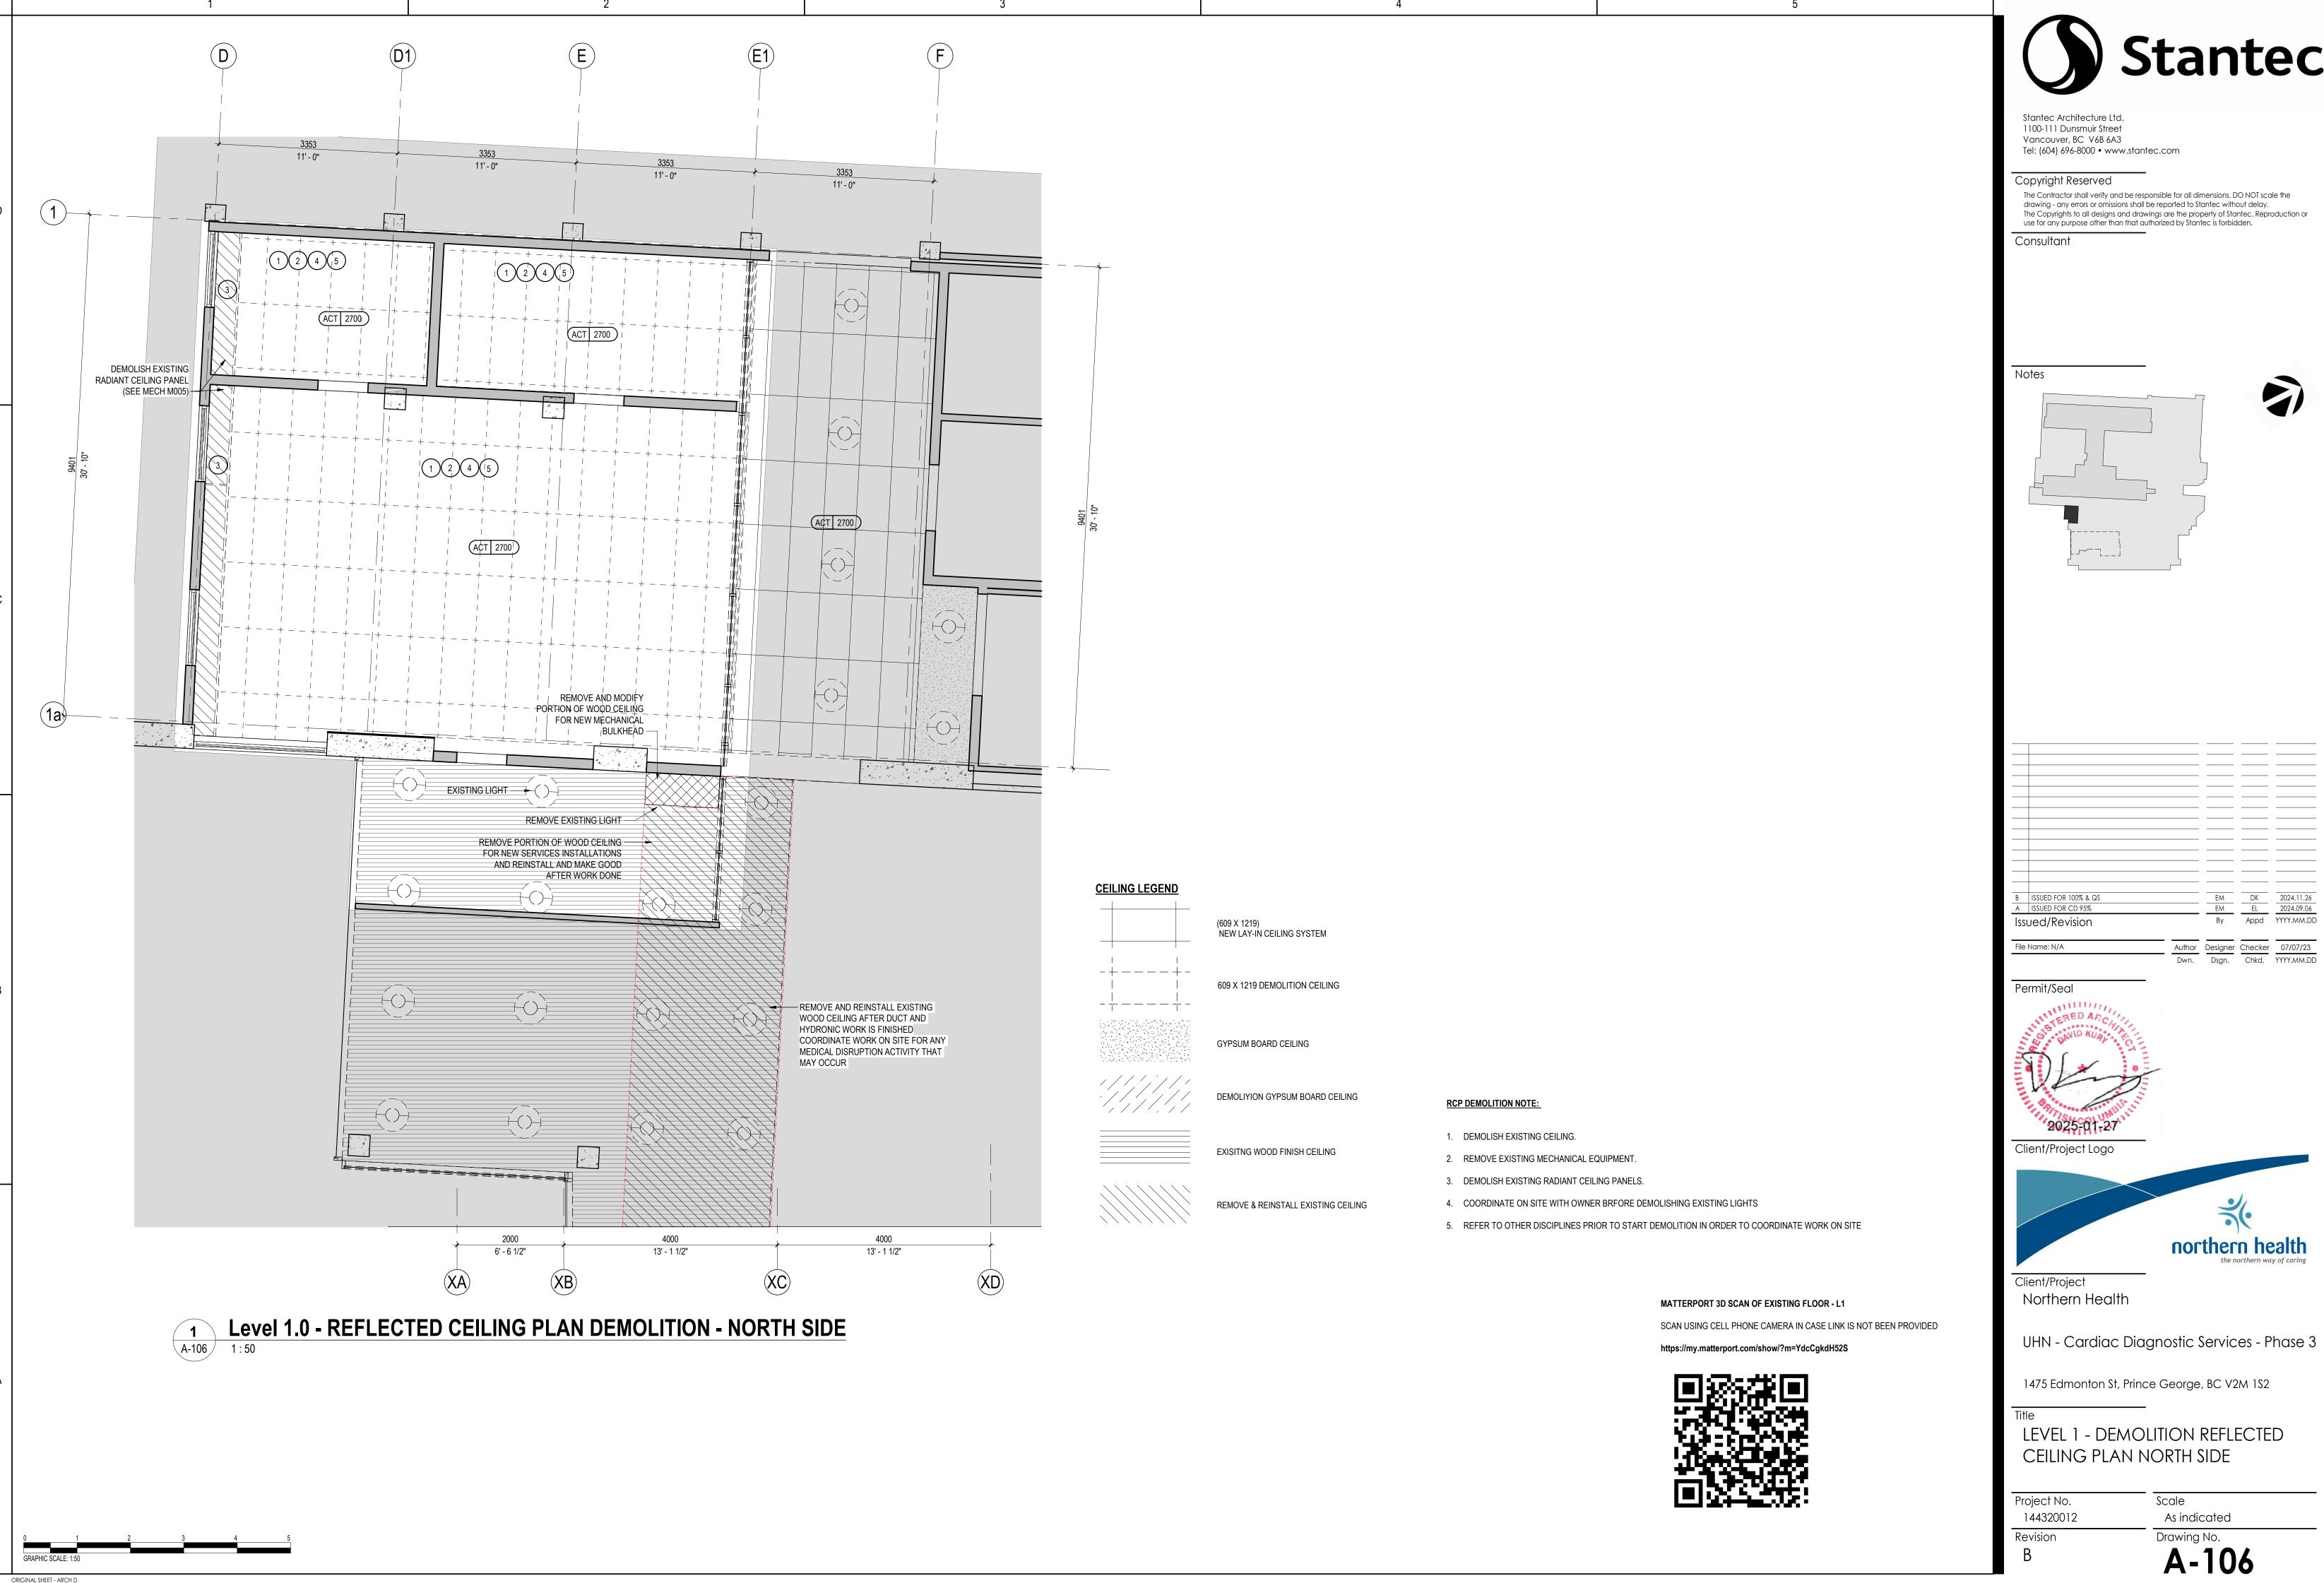
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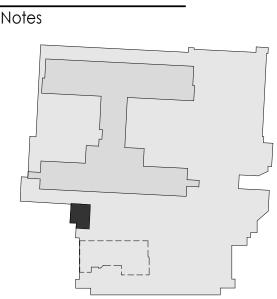








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LEVEL 1 - DEMOLITION REFLECTED

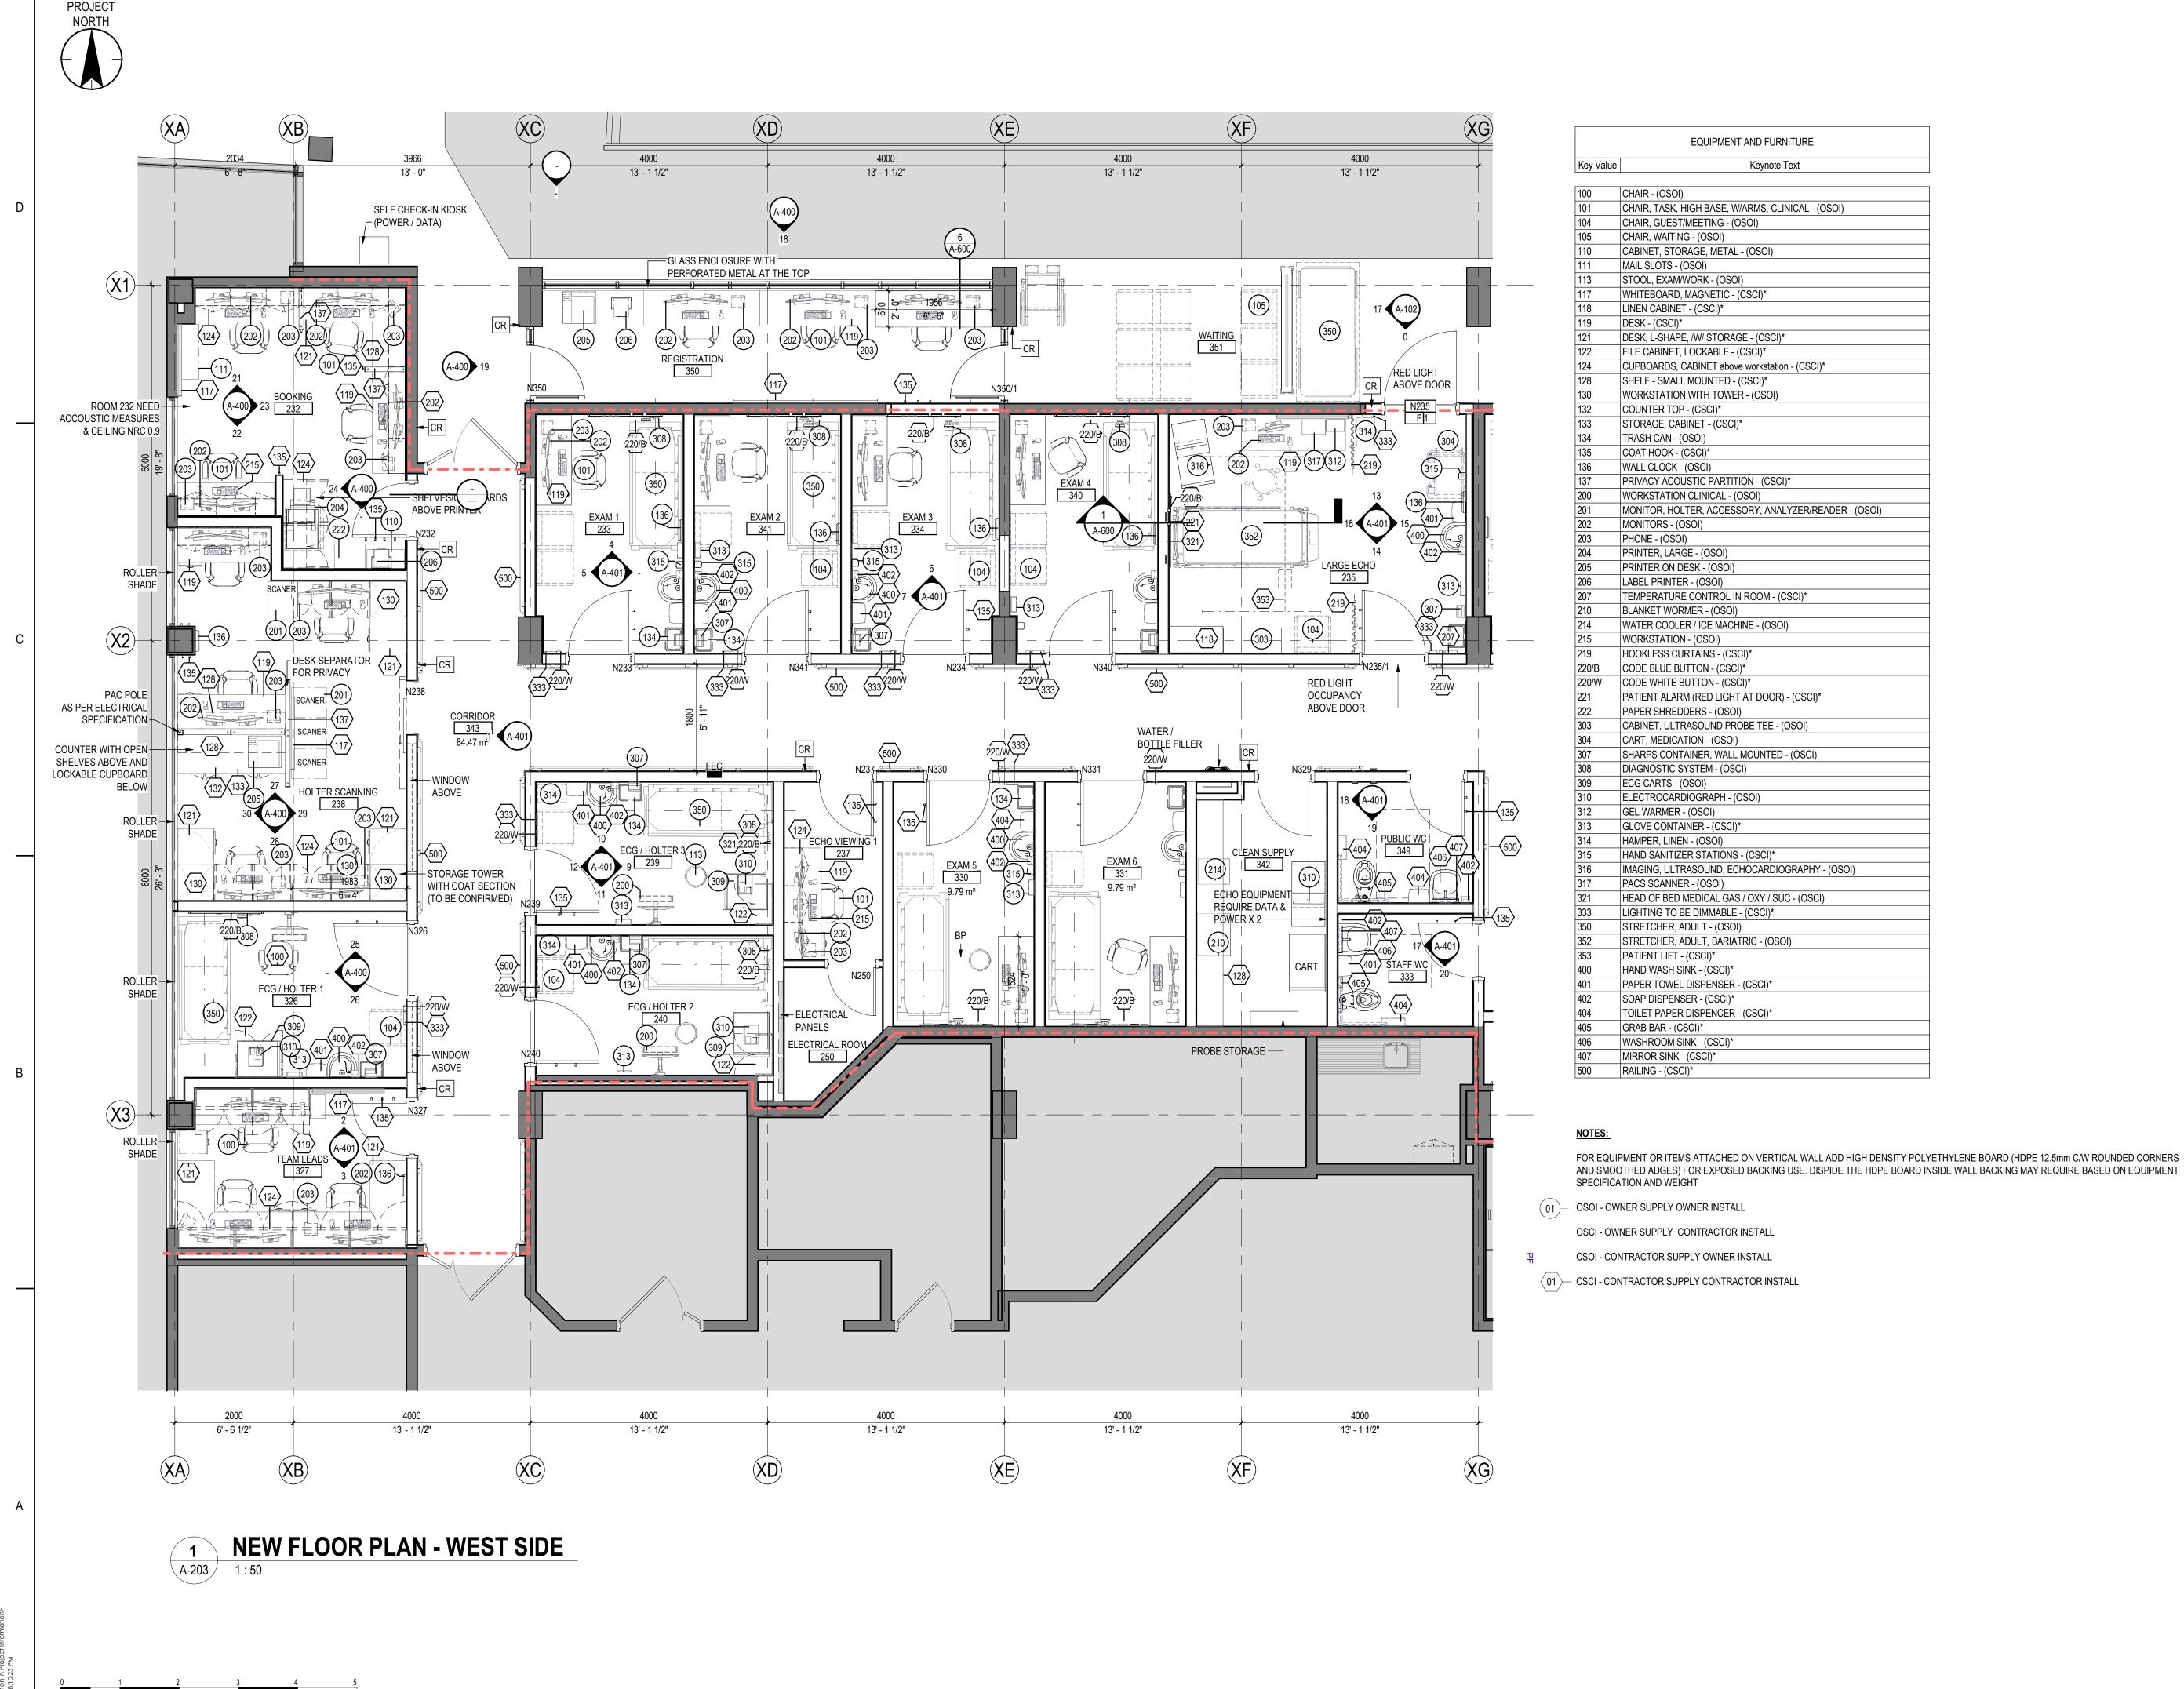
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Drawing No.











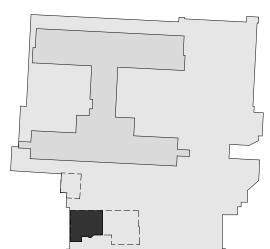
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Keynote Text



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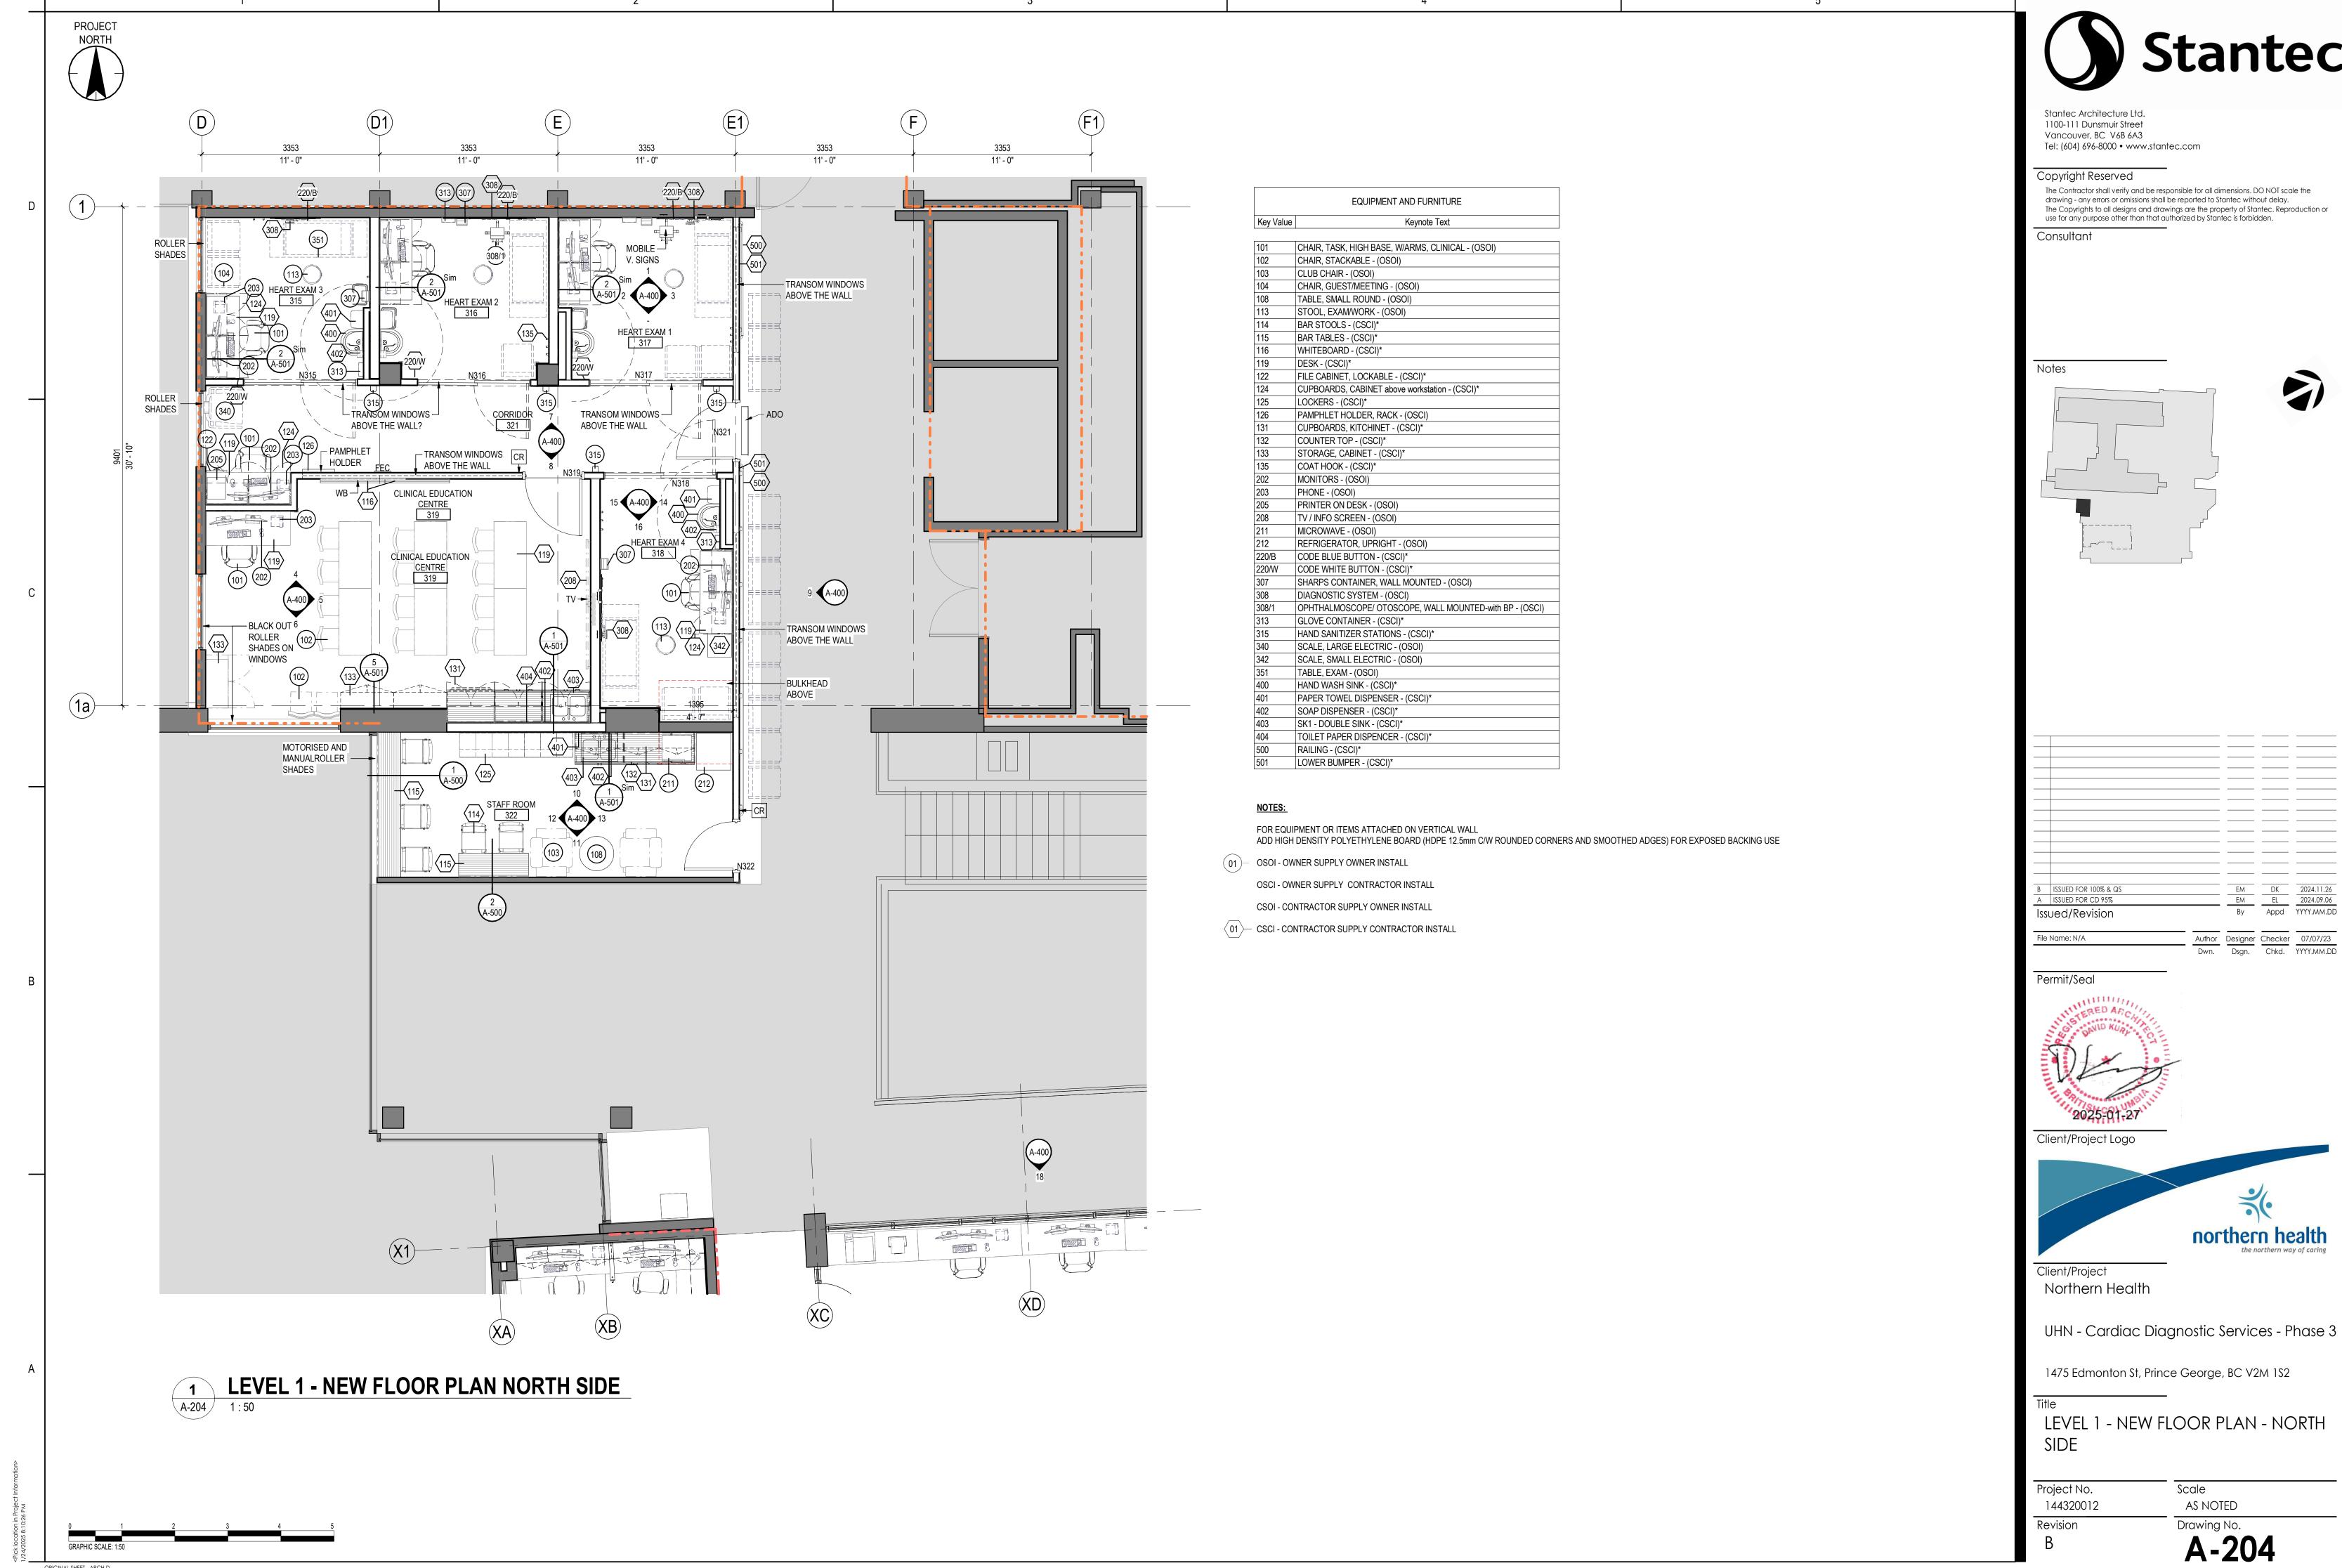
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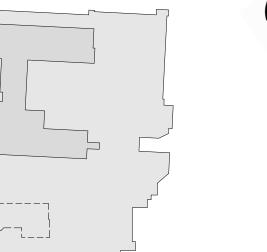
LEVEL 1 - NEW FLOOR PLAN - WEST SIDE

Project No. 144320012 Revision

Scale As indicated Drawing No. A-203



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LEVEL 1 - NEW FLOOR PLAN - NORTH

AS NOTED

A-204



4000 13' - 1 1/2" 13' - 1 1/2" 6' - 6 1/2" 13' - 1 1/2" 13' - 1 1/2" <u>X1</u>-_____ NEW RADIANT PANEL ACT 2700 (SEE MECH) ___+__ EXAM 3 234 233 ACT 2700 ACT 2700 ACT 2700 ACT 2700 PATIENT LIFT TO BE ATTACHED TO UNDERSIDE ACT 2700 STRUCTURE WITH UNISTRUT DELEGATED DESIGN (REFER TO A-600 DETAIL 1) (X2)— ACT 2700 ACT 2700 ECHO VIEWING ACT 2700 ACT 2700 ACT 2700 NEW LAY-IN CEILING SYSTEM ACT 2700 GYPSUM BOARD CEILING EXISITNG WOOD FINISH CEILING (X3)-— DEPENDING ON EXISTING AND NEW MECHANICAL CONDITION ACT 2700 ALLOW FOR A DROP DOWN CEILING TO A MAX HEIGHT OF 2400 OR A PORTION NEW REFLECTED CEILING PLAN NOTE: PART BULKHEAD IN ROOM 240 1. REFER TO MECHANICAL & ELECTRICAL FOR NEW HVAC EQUIPMENT AND LIGHTS 2. INSTALL TWO PATIENT LIFT IN ROOM 235 & 329 3. INSTALL NEW HOOKLESS CURTAIN TRACK FLUSH TO THE CEILING, TO NOT CONFLICT WITH THE LIFT TRACK REFER TO (A-300) SCHEDULE FINISH ACT2 - ACOUSTIC CEILING TILE ACT3 - ACOUSTIC CEILING TILE WITH R12 ACOUSTIC INSULATION BACKLOADED FOR SOUND PRIVACY NEW REFLECTED CEILING PLAN WEST SIDE

ORIGINAL SHEET - ARCH D



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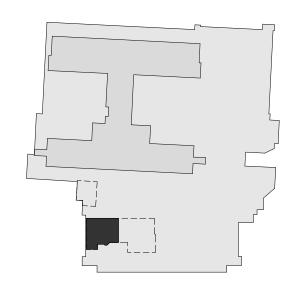
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Title

Revision

LEVEL 1 - NEW REFLECTED CEILING PLAN - WEAST SIDE

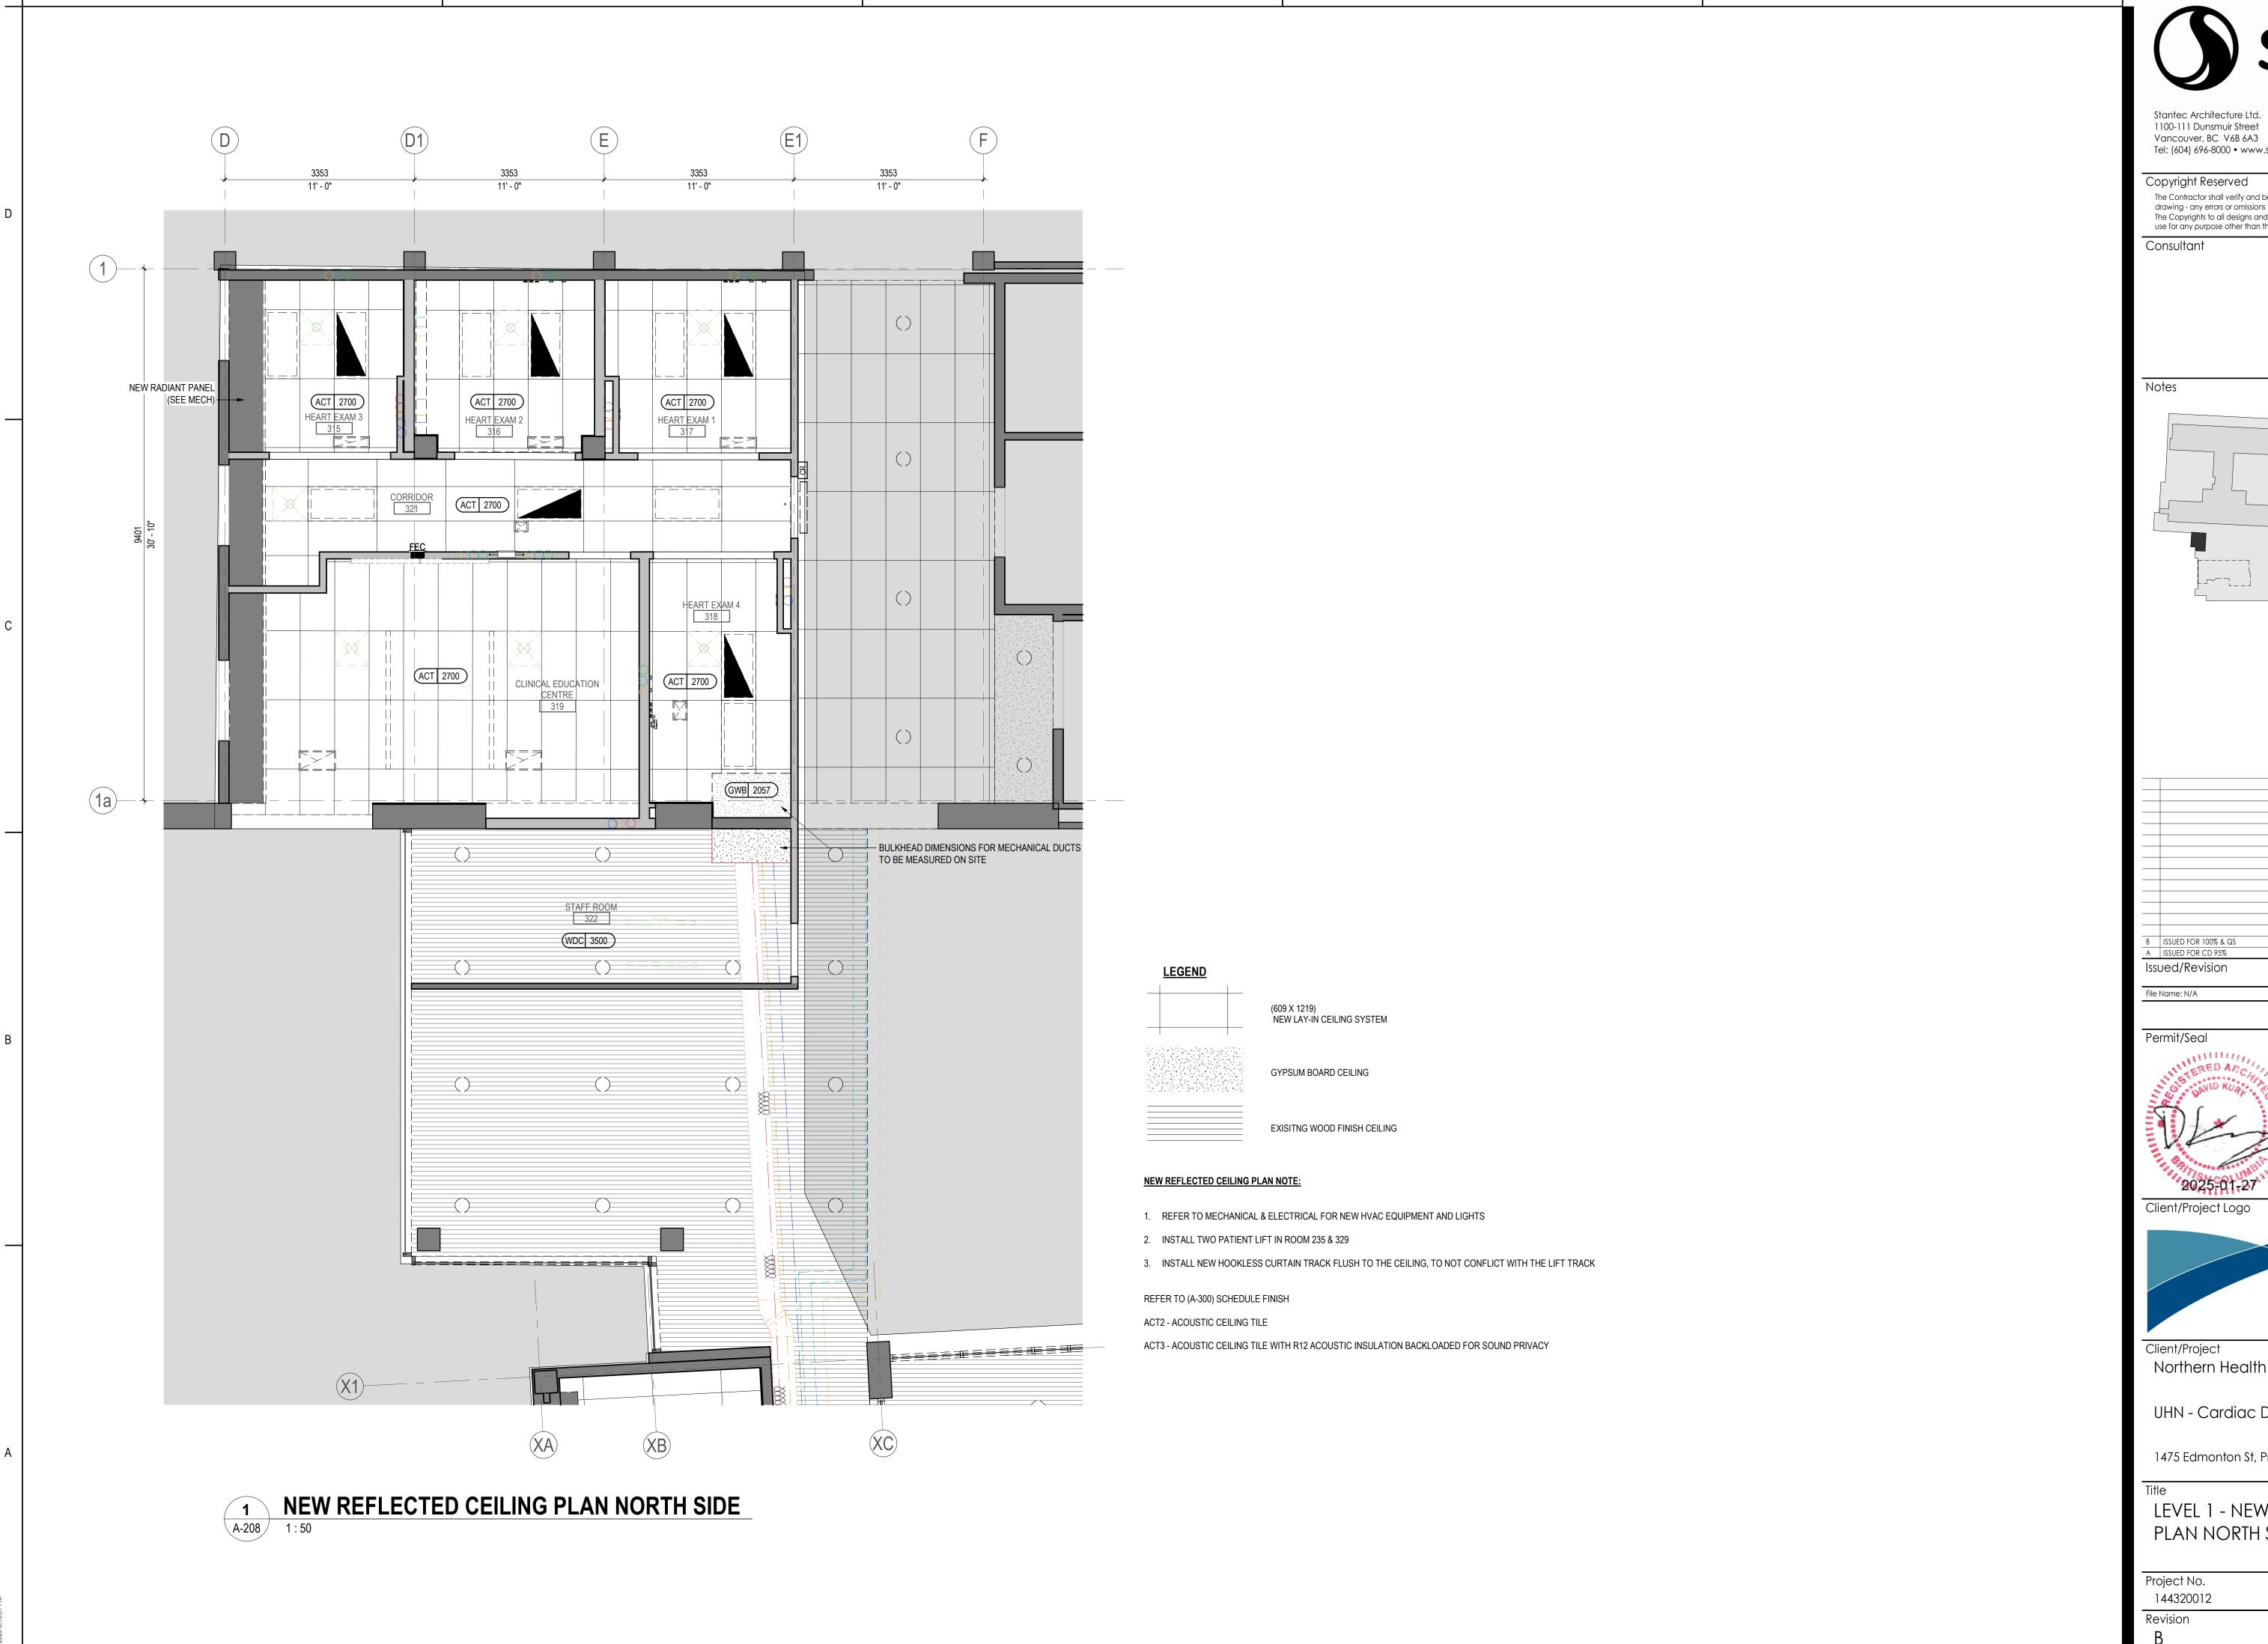
Project No. 144320012

As indicated

Drawing No.

Scale

Drawing No.
A-207

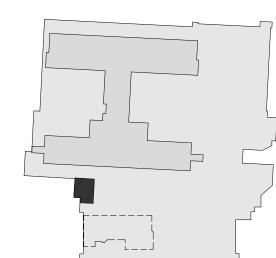


ORIGINAL SHEET - ARCH D

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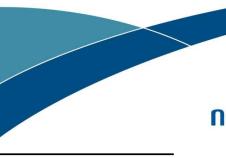
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 Author Designer Checker 07/07/23

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LEVEL 1 - NEW REFLECTED CEILING PLAN NORTH SIDE

> As indicated Drawing No.

Scale

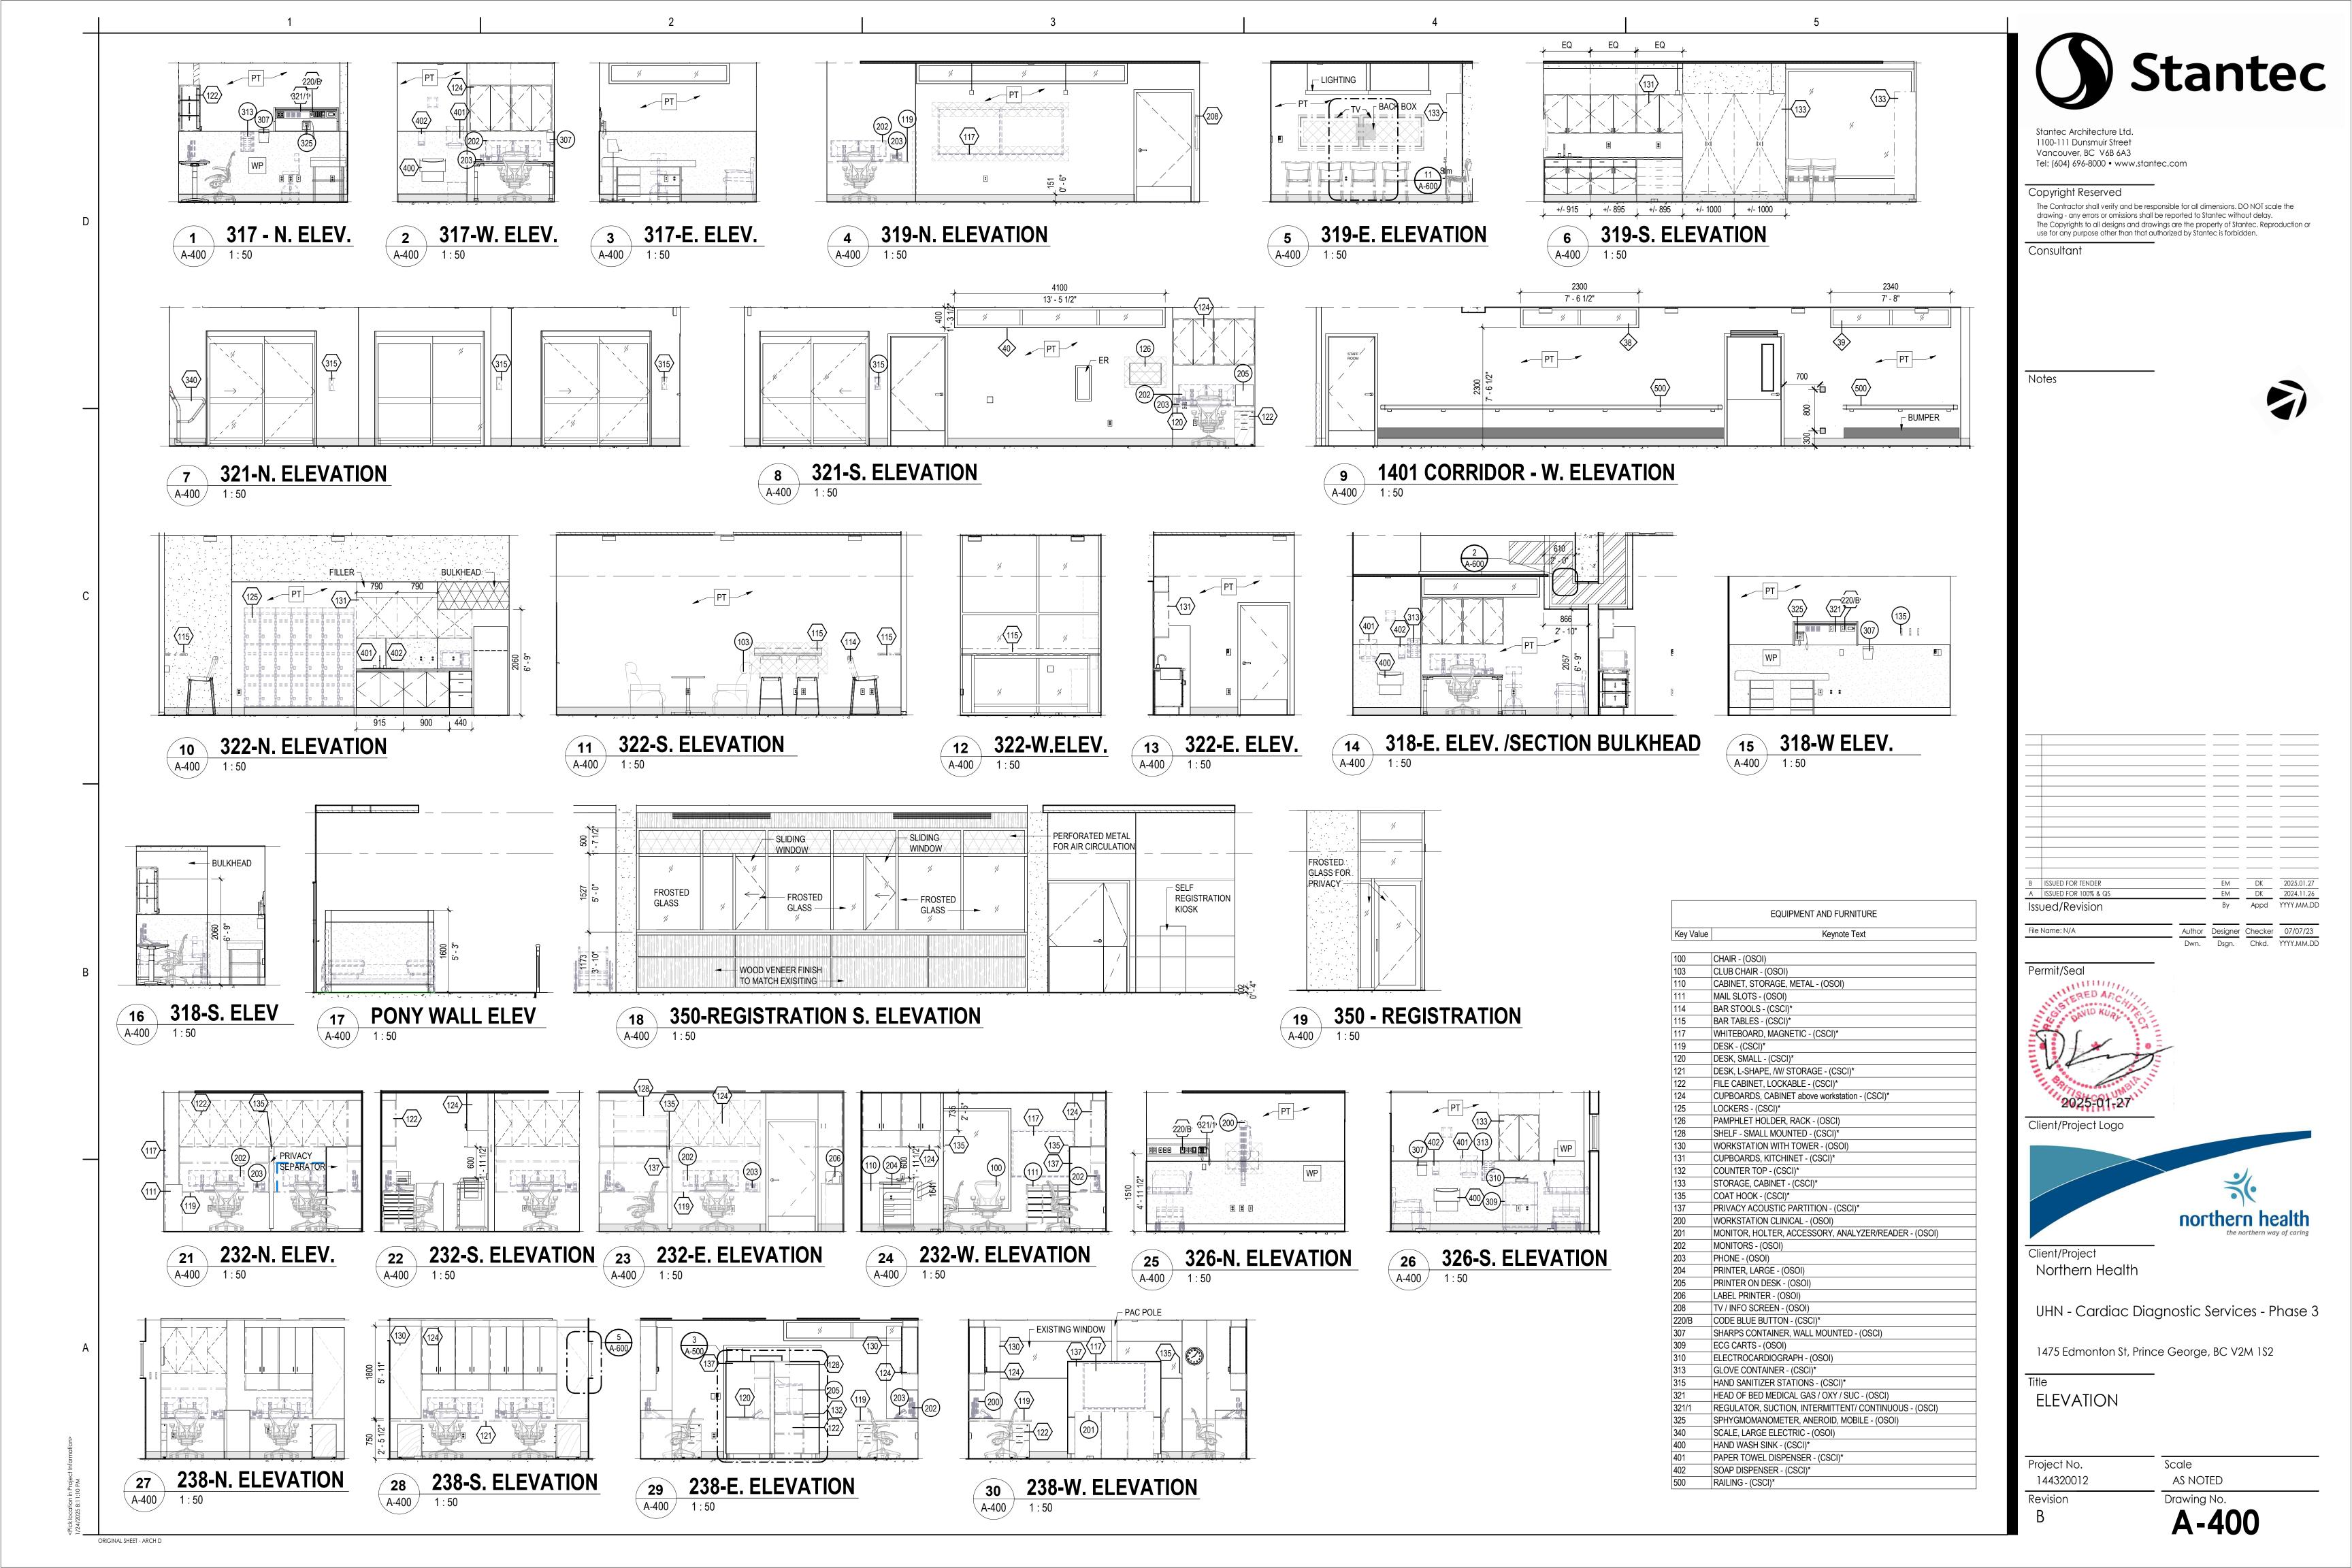


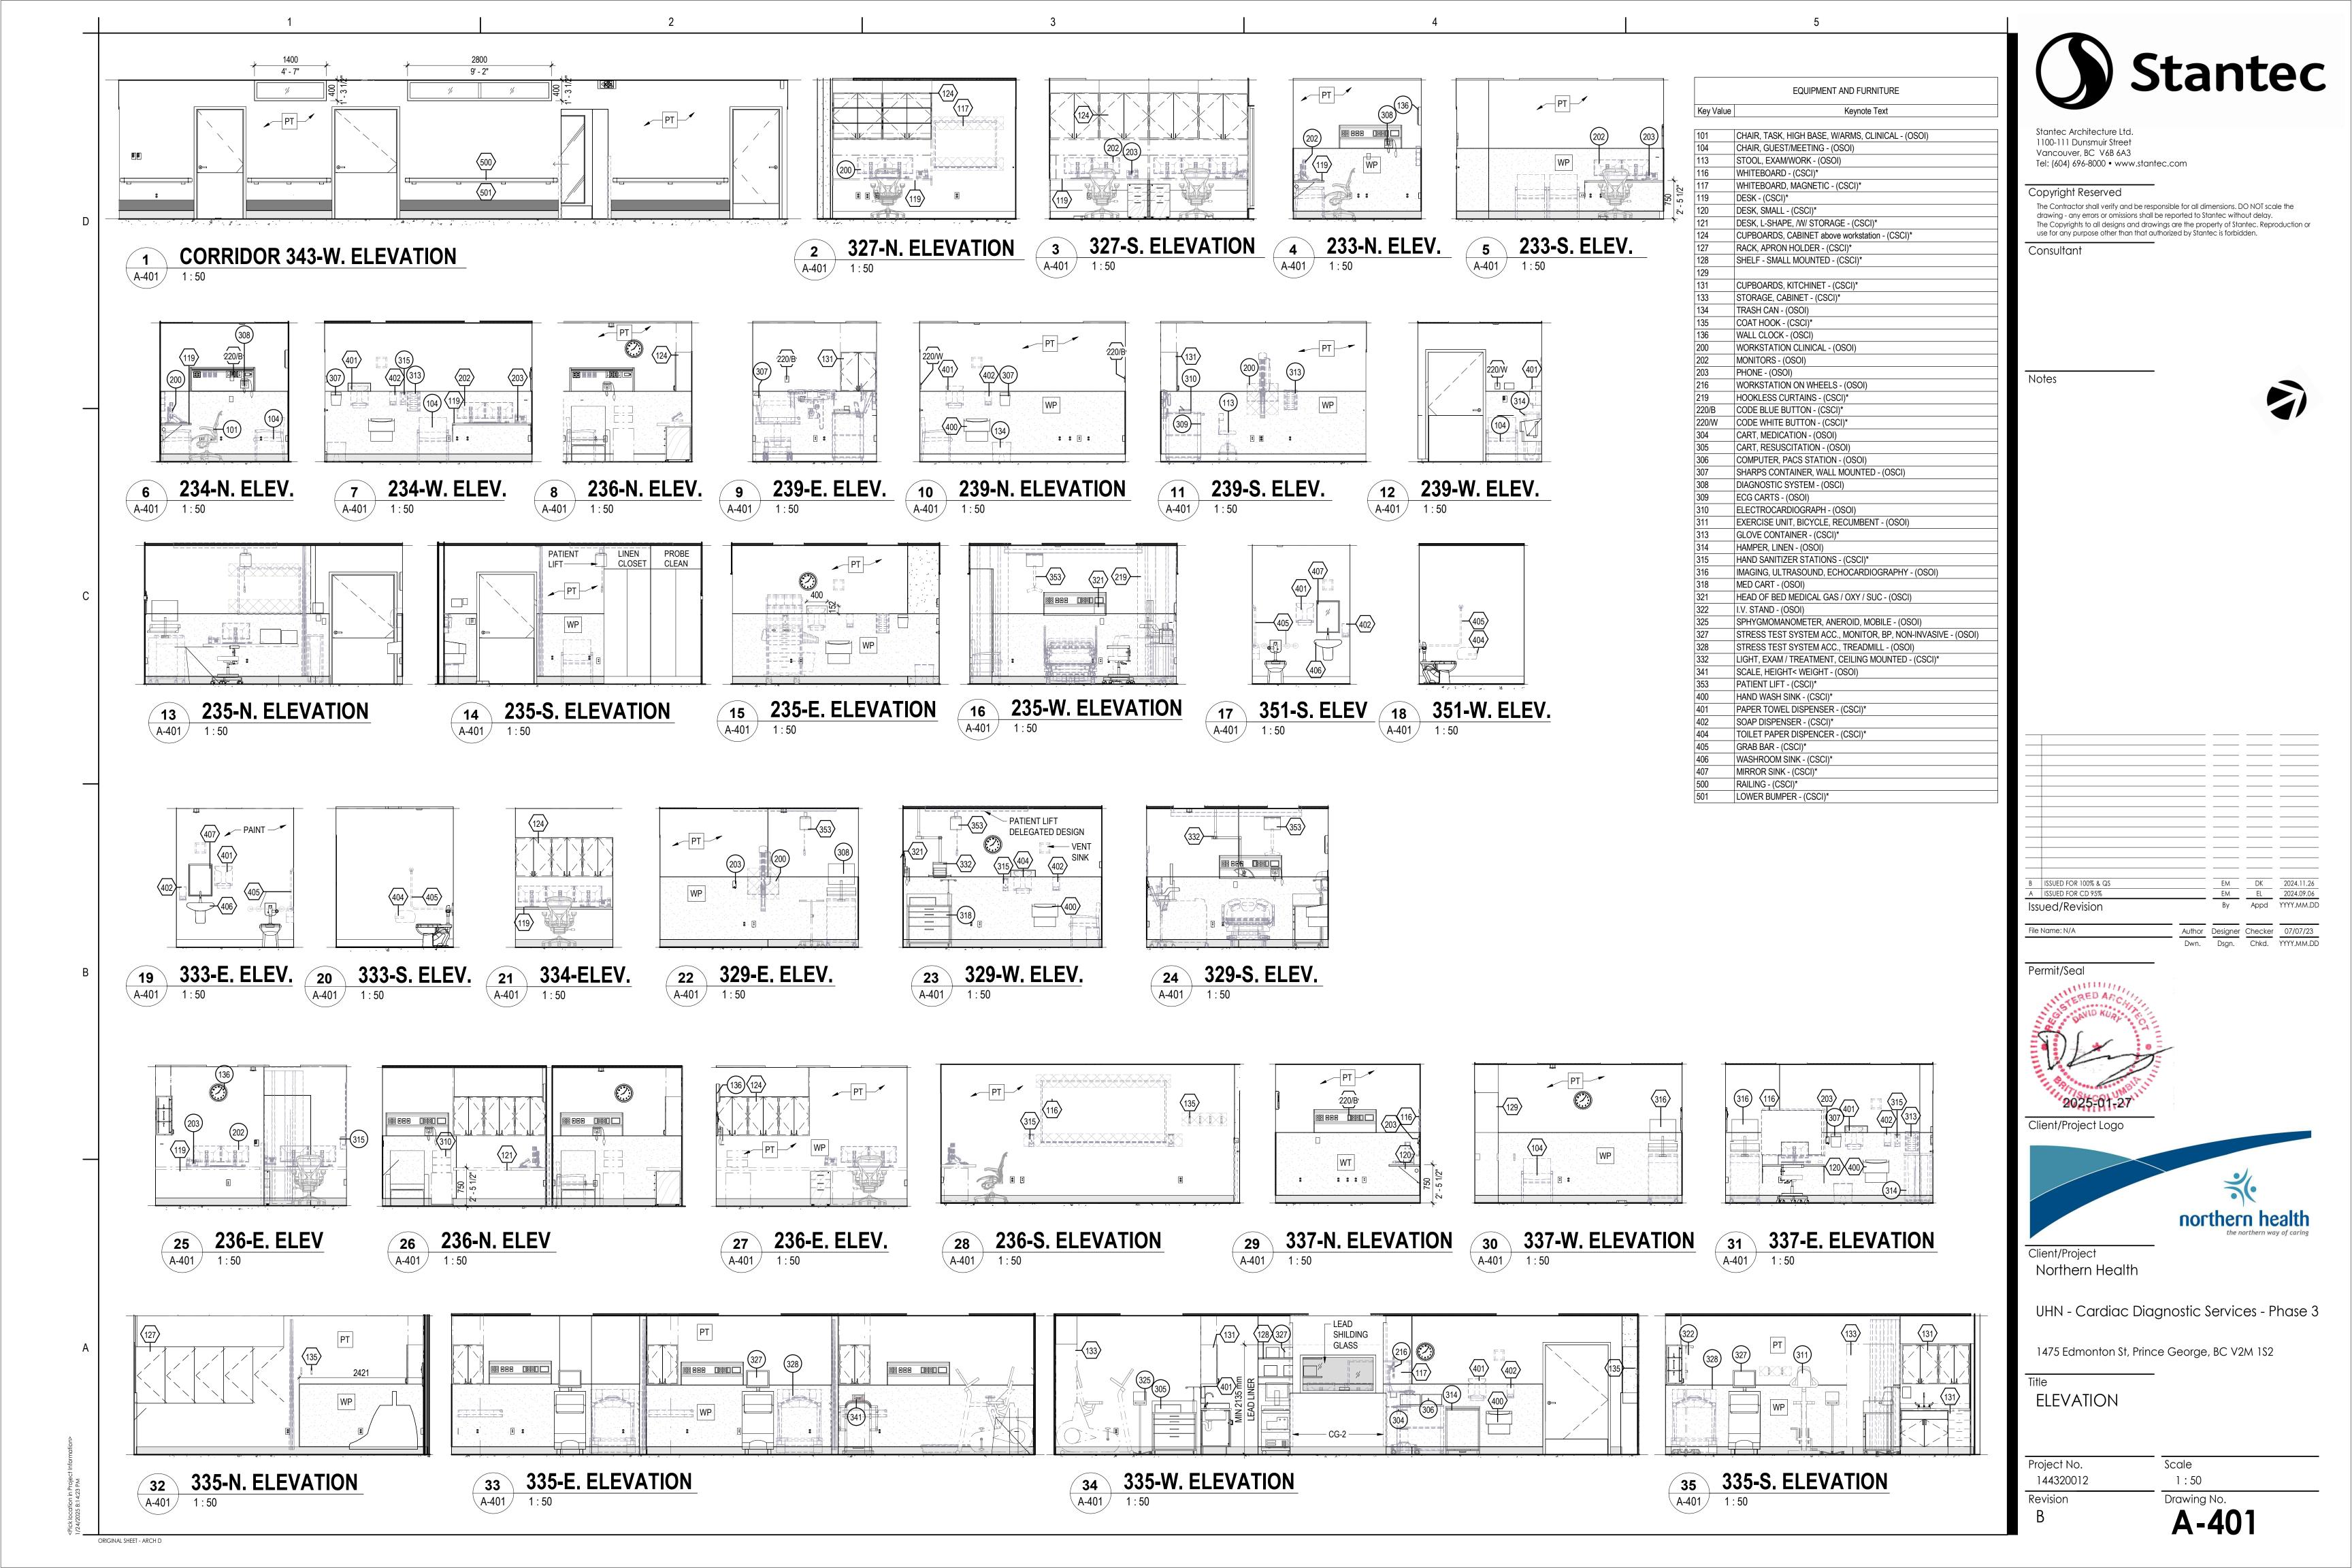
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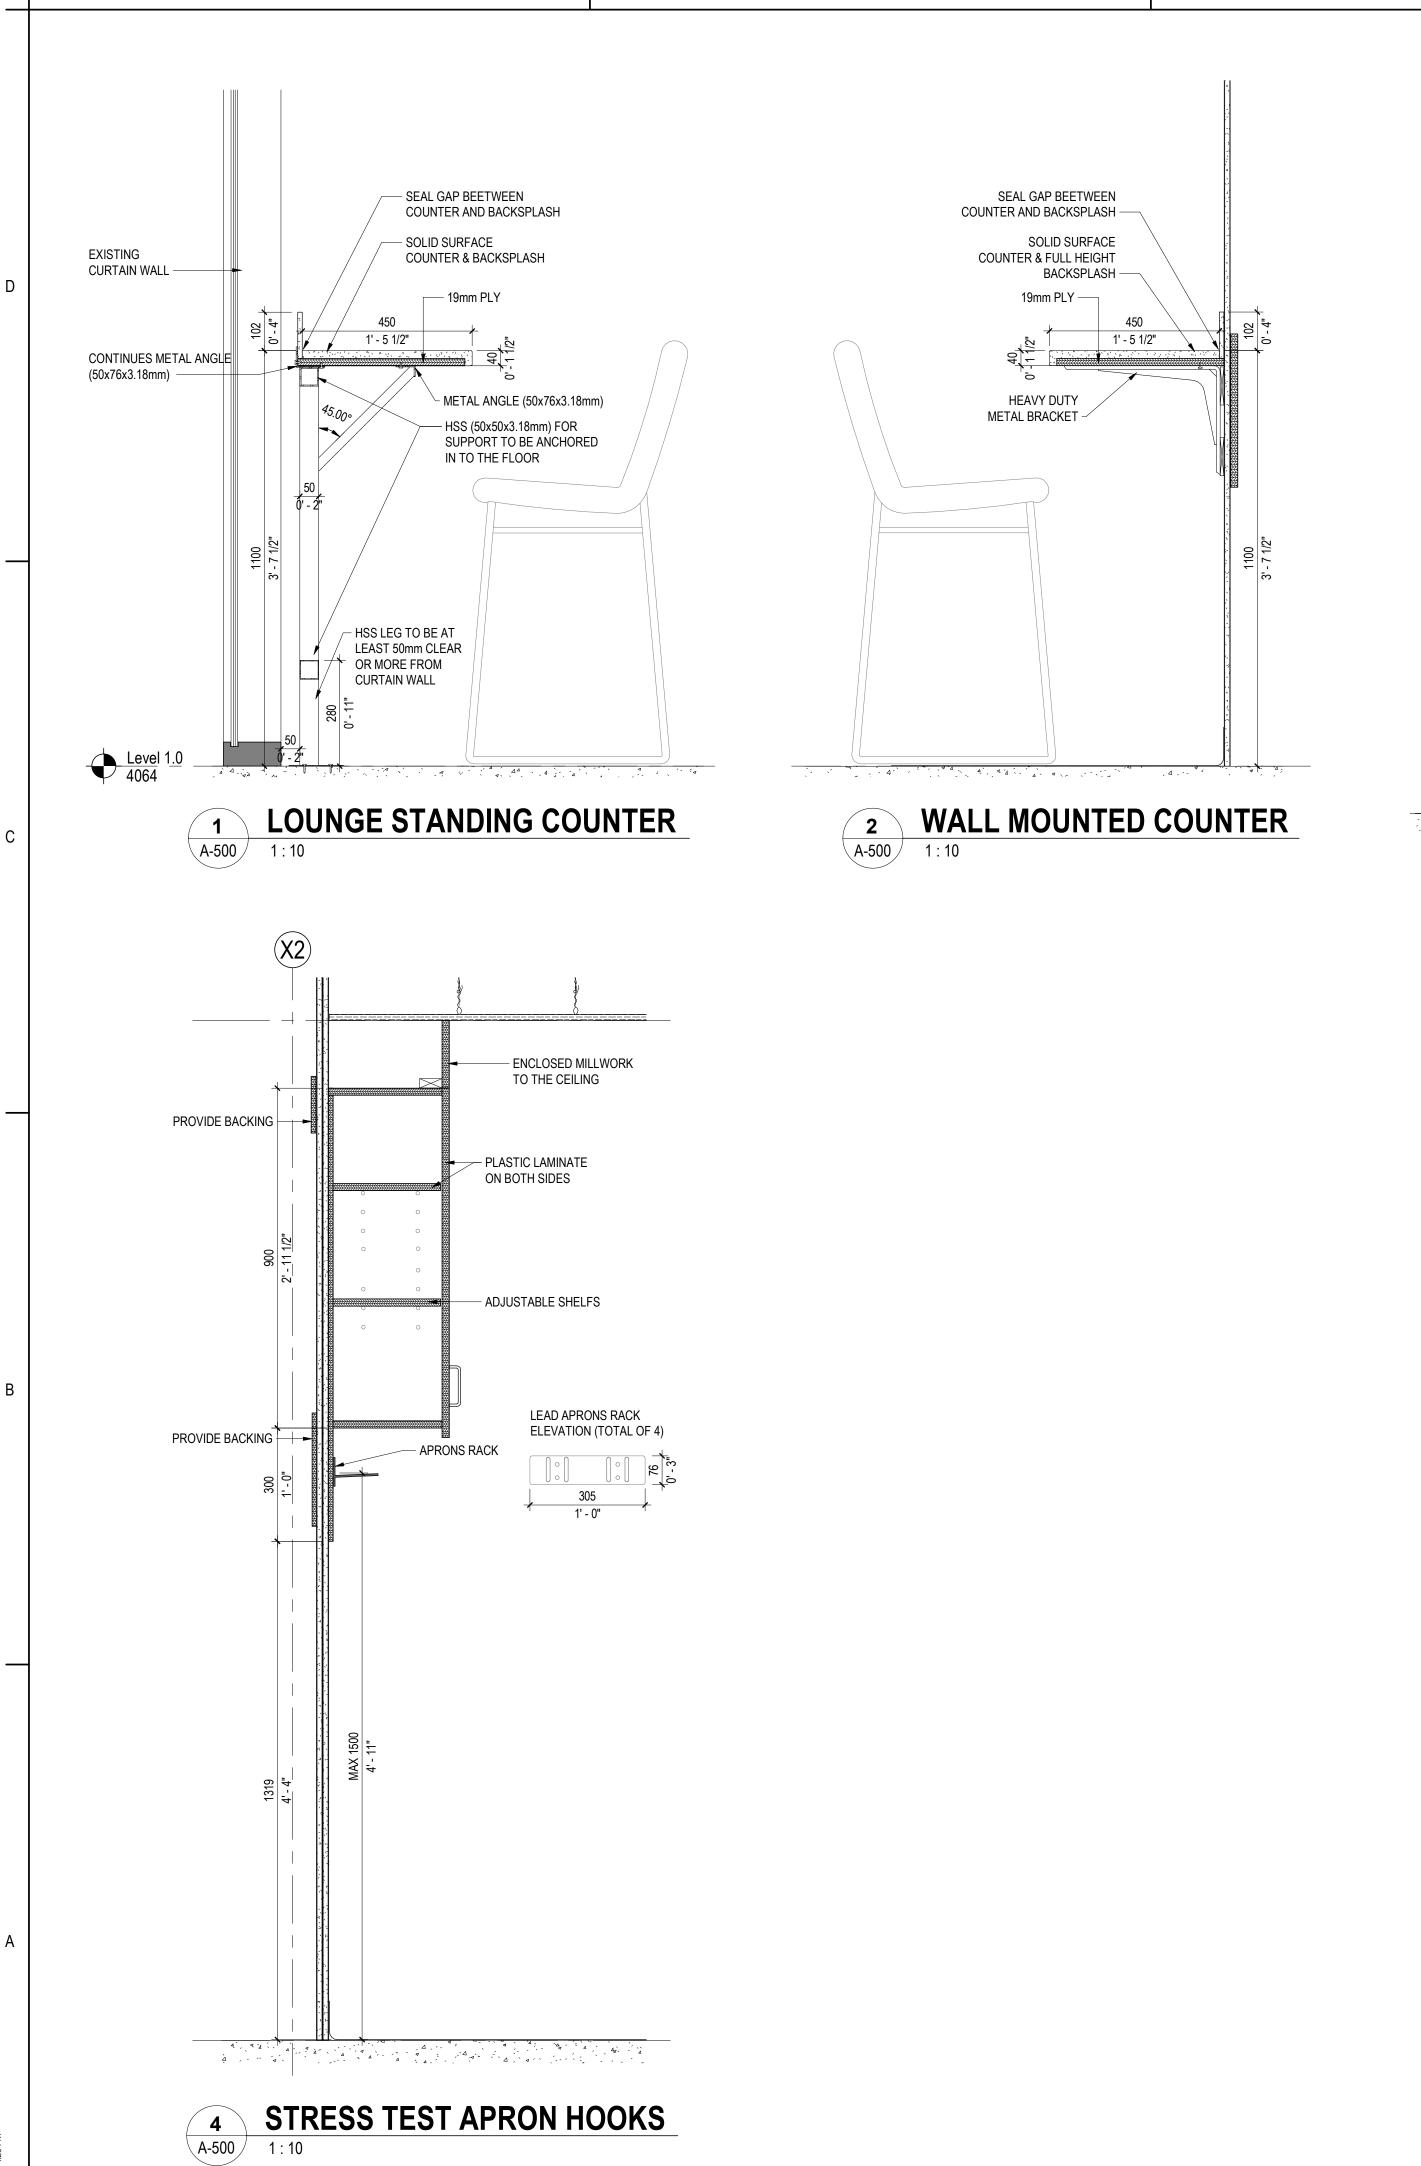
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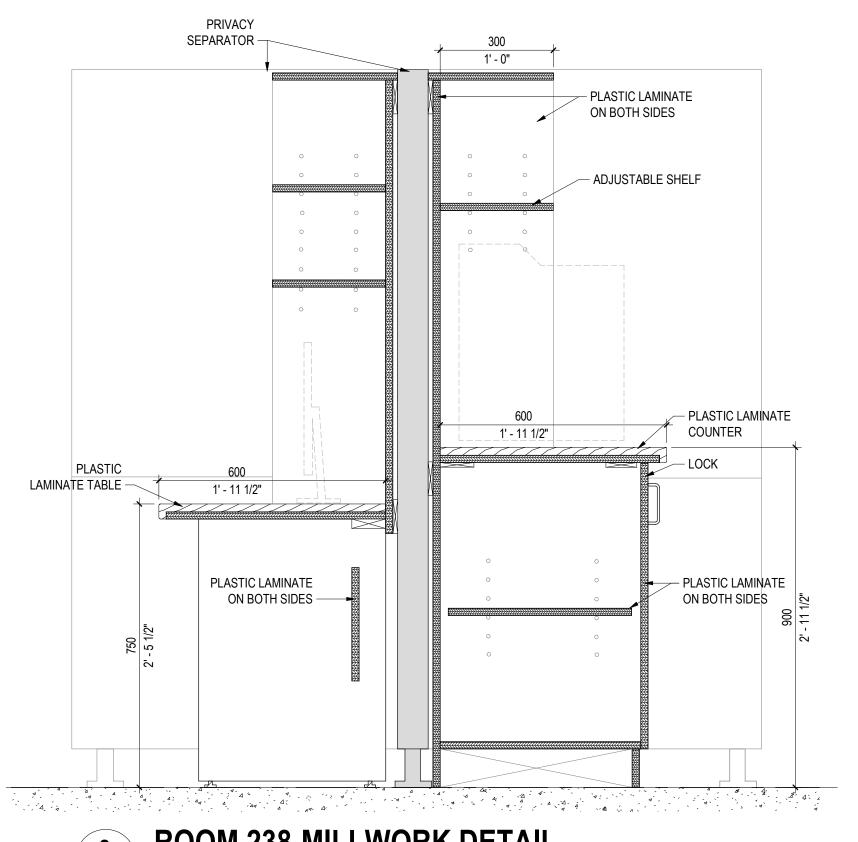
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ORIGINAL SHEET - ARCH D



3 ROOM 238-MILLWORK DETAIL A-500

LIST OF MILLWORK

	ROOM NAME	ROOM NUMBER	MILLWORK TYPE	MATERIAL	KEY VALUE	TOTAL	INDICATIV DIMENSIONS (DxLxH
	HEART EXAM ROOM	315, 316, 317, 318	DESK - WALL MOUNTED	PLASTIC LAMINATE	119	4	610 X 155
	HEART EXAMINOUM	315, 316, 317, 318	CUPBOBOARD CABINET - WITH LOCK	PLASTIC LAMINATE	124	8	300 X 800 X 90
	CORRIDOR	321	DESK - WALL MOUNTED	PLASTIC LAMINATE	119	1	610 X 159
	CORRIDOR	321	CUPBOBOARD CABINET ABOVE WORKSTATION - WITH LOCK	PLASTIC LAMINATE	124	2	300 X 800 X 90
		N 319	CUPBOARDS KITCHINET - WITH LOCK	PLASTIC LAMINATE	131	3	400 X 915 X 90
			DESK - WALL MOUNTED	PLASTIC LAMINATE	119	1	610 X 159
	OLINIONI EDUCATIONI		STORAGE CABINET	PLASTIC LAMINATE	133	1	400 X 1000 X 200
	CLINICAL EDUCATION		STORAGE CABINET	PLASTIC LAMINATE	133	2	300 X 1000 X 200
			COUNTER TOP & BACK SPLASH FULL HIGHT WITH SINK	CORIAN	132	1	610 X 2710 X 90
			DESK - WALL MOUNTED	PLASTIC LAMINATE	119	6	610 x 126
	STAFF ROOM	322	BAR HIGHT TABLE	CORIAN	115	1	450 X 2735 X 110
			BAR HIGHT TABLE	CORIAN	115	1	450 X 1315 X 110
			COUNTER TOP & BACK SPLASH FULL HIGHT WITH SINK	CORIAN	132	1	610 X 2255 X 90
			CUPBOARDS KITCHINET - WITH LOCK	PLASTIC LAMINATE	131	3	400 X 790 X 90
	REGISTRATION	350	DESK - WALL MOUNTED (CONFIRM ON SITE)	PLASTIC LAMINATE	119	1	610 X 760
			DESK - WALL MOUNTED	PLASTIC LAMINATE	119	3	610 X 175
	BOOKING ROOM	232	DESK - WALL MOUNTED L-SHAPE	PLASTIC LAMINATE	121	1	610 X 250
			CUPBOBOARD CABINET WITH OPEN SHELF ABOVE WORKSTATION - WITH LOCK	PLASTIC LAMINATE	124	12	300 X VARIUS X 90
			OPEN SHELVES ABOVE DESK	PLASTIC LAMINATE	128	4	300 X 100
			CUPBOBOARD CABINET WITH OPEN SHELF ABOVE PHOTOCOPY	PLASTIC LAMINATE	124	2	300 X 760 X 73
\dashv			DESK - WALL MOUNTED L-SHAPE	PLASTIC LAMINATE	121	3	610 X 254
			CUPBOBOARD CABINET WITH OPEN SHELF ABOVE WORKSTATION - WITH LOCK	PLASTIC LAMINATE	124	9	300 X VARIUS X 90
	HOLTER SCANNING	238	TOWER ABOVE DESK		130		
				PLASTIC LAMINATE		3	600 X 600 X 180
			DESK WITH LEGS /P-LAM SIDES	PLASTIC LAMINATE	119	1	610 X 180
			DESK - WALL MOUNTED	PLASTIC LAMINATE	119	1	610 X 157
			OPEN SHELVES ABOVE DESK	PLASTIC LAMINATE	128	4	300 X 180
			STORAGE CABINET UNDER COUNTER	PLASTIC LAMINATE	133	2	580 X 910 X 86
\dashv			COUNTER TOP	PLASTIC LAMINATE	132	1	610 X 180
	ECG HOLTER 1, 2, 3	326, 239, 240	FILE CABINET	PLASTIC LAMINATE	122	3	300 X 800 X 90
	TEAM LEADS		DESK - WALL MOUNTED L-SHAPE	PLASTIC LAMINATE	121	2	610 X 218
			IDECK WALL MOUNTED	PLASTIC LAMINATE	119	1	610 X 192
	TEAM LEADS	327	DESK - WALL MOUNTED		110		
	TEAM LEADS	327	CUPBOBOARD CABINET WITH OPEN SHELF ABOVE WORKSTATION - WITH LOCK	PLASTIC LAMINATE	124	6	
			CUPBOBOARD CABINET WITH OPEN SHELF ABOVE WORKSTATION - WITH LOCK DESK - WALL MOUNTED	PLASTIC LAMINATE PLASTIC LAMINATE	124 119	1	610 X 188
	ECHO VIEWING 1	237	CUPBOBOARD CABINET WITH OPEN SHELF ABOVE WORKSTATION - WITH LOCK DESK - WALL MOUNTED CUPBOBOARD CABINET WITH OPEN SHELF ABOVE WORKSTATION - WITH LOCK	PLASTIC LAMINATE PLASTIC LAMINATE PLASTIC LAMINATE	124 119 124	1 3	610 X 188 300 X 640 X 90
	ECHO VIEWING 1 EXAM 1,2,3,4,5,6		CUPBOBOARD CABINET WITH OPEN SHELF ABOVE WORKSTATION - WITH LOCK DESK - WALL MOUNTED CUPBOBOARD CABINET WITH OPEN SHELF ABOVE WORKSTATION - WITH LOCK DESK - WALL MOUNTED	PLASTIC LAMINATE PLASTIC LAMINATE PLASTIC LAMINATE PLASTIC LAMINATE	124 119	1	610 X 188 300 X 640 X 90 610 X 152
	ECHO VIEWING 1	237	CUPBOBOARD CABINET WITH OPEN SHELF ABOVE WORKSTATION - WITH LOCK DESK - WALL MOUNTED CUPBOBOARD CABINET WITH OPEN SHELF ABOVE WORKSTATION - WITH LOCK	PLASTIC LAMINATE PLASTIC LAMINATE PLASTIC LAMINATE PLASTIC LAMINATE PLASTIC LAMINATE / METAL	124 119 124 119 128	1 3	610 X 188 300 X 640 X 90 610 X 152 450 X 382
	ECHO VIEWING 1 EXAM 1,2,3,4,5,6 CLEAN SUPPLY	237 233,330,331,334,340,341, 342	CUPBOBOARD CABINET WITH OPEN SHELF ABOVE WORKSTATION - WITH LOCK DESK - WALL MOUNTED CUPBOBOARD CABINET WITH OPEN SHELF ABOVE WORKSTATION - WITH LOCK DESK - WALL MOUNTED OPEN SHELF WALL MOUNTED ON METAL BRACKET WITH ADJUSTABLE HEIGHT DESK WITH LEGS	PLASTIC LAMINATE PLASTIC LAMINATE PLASTIC LAMINATE PLASTIC LAMINATE	124 119 124 119	1 3 6	610 X 188 300 X 640 X 90 610 X 152 450 X 382 610 X 184
	ECHO VIEWING 1 EXAM 1,2,3,4,5,6	237 233,330,331,334,340,341,	CUPBOBOARD CABINET WITH OPEN SHELF ABOVE WORKSTATION - WITH LOCK DESK - WALL MOUNTED CUPBOBOARD CABINET WITH OPEN SHELF ABOVE WORKSTATION - WITH LOCK DESK - WALL MOUNTED OPEN SHELF WALL MOUNTED ON METAL BRACKET WITH ADJUSTABLE HEIGHT	PLASTIC LAMINATE PLASTIC LAMINATE PLASTIC LAMINATE PLASTIC LAMINATE PLASTIC LAMINATE / METAL	124 119 124 119 128	1 3 6 4	610 X 188 300 X 640 X 90 610 X 152 450 X 382 610 X 184
	ECHO VIEWING 1 EXAM 1,2,3,4,5,6 CLEAN SUPPLY	237 233,330,331,334,340,341, 342	CUPBOBOARD CABINET WITH OPEN SHELF ABOVE WORKSTATION - WITH LOCK DESK - WALL MOUNTED CUPBOBOARD CABINET WITH OPEN SHELF ABOVE WORKSTATION - WITH LOCK DESK - WALL MOUNTED OPEN SHELF WALL MOUNTED ON METAL BRACKET WITH ADJUSTABLE HEIGHT DESK WITH LEGS	PLASTIC LAMINATE PLASTIC LAMINATE PLASTIC LAMINATE PLASTIC LAMINATE PLASTIC LAMINATE / METAL PLASTIC LAMINATE	124 119 124 119 128 119	1 3 6 4 1	610 X 188 300 X 640 X 90 610 X 152 450 X 382 610 X 184 415 X 900 X 200
	ECHO VIEWING 1 EXAM 1,2,3,4,5,6 CLEAN SUPPLY LARGE ECHO ECHO 1, 2	237 233,330,331,334,340,341, 342 235 337,338	CUPBOBOARD CABINET WITH OPEN SHELF ABOVE WORKSTATION - WITH LOCK DESK - WALL MOUNTED CUPBOBOARD CABINET WITH OPEN SHELF ABOVE WORKSTATION - WITH LOCK DESK - WALL MOUNTED OPEN SHELF WALL MOUNTED ON METAL BRACKET WITH ADJUSTABLE HEIGHT DESK WITH LEGS LINEN CABINET	PLASTIC LAMINATE	124 119 124 119 128 119 129	1 3 6 4 1	610 X 188 300 X 640 X 90 610 X 152 450 X 382 610 X 184 415 X 900 X 200 610 X 120
	ECHO VIEWING 1 EXAM 1,2,3,4,5,6 CLEAN SUPPLY LARGE ECHO	237 233,330,331,334,340,341, 342 235	CUPBOBOARD CABINET WITH OPEN SHELF ABOVE WORKSTATION - WITH LOCK DESK - WALL MOUNTED CUPBOBOARD CABINET WITH OPEN SHELF ABOVE WORKSTATION - WITH LOCK DESK - WALL MOUNTED OPEN SHELF WALL MOUNTED ON METAL BRACKET WITH ADJUSTABLE HEIGHT DESK WITH LEGS LINEN CABINET DESK WITH LEGS	PLASTIC LAMINATE	124 119 124 119 128 119 129 120	1 3 6 4 1 1 2	610 X 188 300 X 640 X 90 610 X 152 450 X 382 610 X 184 415 X 900 X 200 610 X 120 610 X 190
	ECHO VIEWING 1 EXAM 1,2,3,4,5,6 CLEAN SUPPLY LARGE ECHO ECHO 1, 2	237 233,330,331,334,340,341, 342 235 337,338	CUPBOBOARD CABINET WITH OPEN SHELF ABOVE WORKSTATION - WITH LOCK DESK - WALL MOUNTED CUPBOBOARD CABINET WITH OPEN SHELF ABOVE WORKSTATION - WITH LOCK DESK - WALL MOUNTED OPEN SHELF WALL MOUNTED ON METAL BRACKET WITH ADJUSTABLE HEIGHT DESK WITH LEGS LINEN CABINET DESK WITH LEGS DESK - WALL MOUNTED	PLASTIC LAMINATE	124 119 124 119 128 119 129 120 119	1 3 6 4 1 1 2	610 X 188 300 X 640 X 90 610 X 152 450 X 382 610 X 184 415 X 900 X 200 610 X 120 610 X 190 300 X 600 X 90
	ECHO VIEWING 1 EXAM 1,2,3,4,5,6 CLEAN SUPPLY LARGE ECHO ECHO 1, 2	237 233,330,331,334,340,341, 342 235 337,338	CUPBOBOARD CABINET WITH OPEN SHELF ABOVE WORKSTATION - WITH LOCK DESK - WALL MOUNTED CUPBOBOARD CABINET WITH OPEN SHELF ABOVE WORKSTATION - WITH LOCK DESK - WALL MOUNTED OPEN SHELF WALL MOUNTED ON METAL BRACKET WITH ADJUSTABLE HEIGHT DESK WITH LEGS LINEN CABINET DESK WITH LEGS DESK - WALL MOUNTED CUPBOBOARD CABINET WITH OPEN SHELF ABOVE WORKSTATION - WITH LOCK	PLASTIC LAMINATE	124 119 124 119 128 119 129 120 119 124	1 3 6 4 1 1 2 1 3	610 X 188 300 X 640 X 90 610 X 152 450 X 382 610 X 184 415 X 900 X 200 610 X 120 610 X 190 300 X 600 X 90 610 X 321
	ECHO VIEWING 1 EXAM 1,2,3,4,5,6 CLEAN SUPPLY LARGE ECHO ECHO 1, 2 ECHO VIEWING 2	237 233,330,331,334,340,341, 342 235 337, 338 334	CUPBOBOARD CABINET WITH OPEN SHELF ABOVE WORKSTATION - WITH LOCK DESK - WALL MOUNTED CUPBOBOARD CABINET WITH OPEN SHELF ABOVE WORKSTATION - WITH LOCK DESK - WALL MOUNTED OPEN SHELF WALL MOUNTED ON METAL BRACKET WITH ADJUSTABLE HEIGHT DESK WITH LEGS LINEN CABINET DESK WITH LEGS DESK - WALL MOUNTED CUPBOBOARD CABINET WITH OPEN SHELF ABOVE WORKSTATION - WITH LOCK DESK - WALL MOUNTED L-SHAPE	PLASTIC LAMINATE	124 119 124 119 128 119 129 120 119 124 121	1 3 6 4 1 1 2 1 3 1	610 X 188 300 X 640 X 90 610 X 152 450 X 382 610 X 184 415 X 900 X 200 610 X 120 610 X 190 300 X 600 X 90 610 X 321 610 X 370
	ECHO VIEWING 1 EXAM 1,2,3,4,5,6 CLEAN SUPPLY LARGE ECHO ECHO 1, 2 ECHO VIEWING 2	237 233,330,331,334,340,341, 342 235 337, 338 334	CUPBOBOARD CABINET WITH OPEN SHELF ABOVE WORKSTATION - WITH LOCK DESK - WALL MOUNTED CUPBOBOARD CABINET WITH OPEN SHELF ABOVE WORKSTATION - WITH LOCK DESK - WALL MOUNTED OPEN SHELF WALL MOUNTED ON METAL BRACKET WITH ADJUSTABLE HEIGHT DESK WITH LEGS LINEN CABINET DESK WITH LEGS DESK - WALL MOUNTED CUPBOBOARD CABINET WITH OPEN SHELF ABOVE WORKSTATION - WITH LOCK DESK - WALL MOUNTED L-SHAPE DESK - WALL MOUNTED	PLASTIC LAMINATE	124 119 124 119 128 119 129 120 119 124 121 119	1 3 6 4 1 1 2 1 3 1	610 X 188 300 X 640 X 90 610 X 152 450 X 382 610 X 184 415 X 900 X 200 610 X 120 610 X 190 300 X 600 X 90 610 X 321 610 X 370 300 X 600 X 90
	ECHO VIEWING 1 EXAM 1,2,3,4,5,6 CLEAN SUPPLY LARGE ECHO ECHO 1, 2 ECHO VIEWING 2	237 233,330,331,334,340,341, 342 235 337, 338 334	CUPBOBOARD CABINET WITH OPEN SHELF ABOVE WORKSTATION - WITH LOCK DESK - WALL MOUNTED CUPBOBOARD CABINET WITH OPEN SHELF ABOVE WORKSTATION - WITH LOCK DESK - WALL MOUNTED OPEN SHELF WALL MOUNTED ON METAL BRACKET WITH ADJUSTABLE HEIGHT DESK WITH LEGS LINEN CABINET DESK WITH LEGS DESK - WALL MOUNTED CUPBOBOARD CABINET WITH OPEN SHELF ABOVE WORKSTATION - WITH LOCK DESK - WALL MOUNTED L-SHAPE DESK - WALL MOUNTED CUPBOBOARD CABINET WITH OPEN SHELF ABOVE WORKSTATION - WITH LOCK	PLASTIC LAMINATE	124 119 124 119 128 119 129 120 119 124 121 119 122	1 3 6 4 1 1 2 1 3 1 1 6	610 X 188 300 X 640 X 90 610 X 152 450 X 382 610 X 184 415 X 900 X 200 610 X 190 300 X 600 X 90 610 X 321 610 X 370 300 X 600 X 90 300 X 570 X 110
	ECHO VIEWING 1 EXAM 1,2,3,4,5,6 CLEAN SUPPLY LARGE ECHO ECHO 1, 2 ECHO VIEWING 2	237 233,330,331,334,340,341, 342 235 337, 338 334	CUPBOBOARD CABINET WITH OPEN SHELF ABOVE WORKSTATION - WITH LOCK DESK - WALL MOUNTED CUPBOBOARD CABINET WITH OPEN SHELF ABOVE WORKSTATION - WITH LOCK DESK - WALL MOUNTED OPEN SHELF WALL MOUNTED ON METAL BRACKET WITH ADJUSTABLE HEIGHT DESK WITH LEGS LINEN CABINET DESK WITH LEGS DESK - WALL MOUNTED CUPBOBOARD CABINET WITH OPEN SHELF ABOVE WORKSTATION - WITH LOCK DESK - WALL MOUNTED L-SHAPE DESK - WALL MOUNTED CUPBOBOARD CABINET WITH OPEN SHELF ABOVE WORKSTATION - WITH LOCK CUPBOBOARD CABINET WITH OPEN SHELF ABOVE WORKSTATION - WITH LOCK	PLASTIC LAMINATE	124 119 124 119 128 119 129 120 119 124 121 119 122 127	1 3 6 4 1 1 2 1 3 1 1 6 5	610 X 188 300 X 640 X 90 610 X 152 450 X 382 610 X 184 415 X 900 X 200 610 X 120 610 X 190 300 X 600 X 90 610 X 321 610 X 370 300 X 600 X 90 300 X 570 X 110 300 X 125
	ECHO VIEWING 1 EXAM 1,2,3,4,5,6 CLEAN SUPPLY LARGE ECHO ECHO 1, 2 ECHO VIEWING 2 HEART RYTHEM DEVICE	237 233,330,331,334,340,341, 342 235 337, 338 334 236	CUPBOBOARD CABINET WITH OPEN SHELF ABOVE WORKSTATION - WITH LOCK DESK - WALL MOUNTED CUPBOBOARD CABINET WITH OPEN SHELF ABOVE WORKSTATION - WITH LOCK DESK - WALL MOUNTED OPEN SHELF WALL MOUNTED ON METAL BRACKET WITH ADJUSTABLE HEIGHT DESK WITH LEGS LINEN CABINET DESK WITH LEGS DESK - WALL MOUNTED CUPBOBOARD CABINET WITH OPEN SHELF ABOVE WORKSTATION - WITH LOCK DESK - WALL MOUNTED L-SHAPE DESK - WALL MOUNTED CUPBOBOARD CABINET WITH OPEN SHELF ABOVE WORKSTATION - WITH LOCK CUPBOBOARD CABINET WITH OPEN SHELF ABOVE WORKSTATION - WITH LOCK CUPBOARD CABINET ABOVE RACK APRON HOLDER WALL MOUNTED (HEAVY DUTY) OPEN SHELF WALL MOUNTED ON METAL BRACKET	PLASTIC LAMINATE	124 119 124 119 128 119 129 120 119 124 121 119 122 127 128	1 3 6 4 1 1 2 1 3 1 1 6 5 2	300 X 965 X 90 610 X 188 300 X 640 X 90 610 X 152 450 X 382 610 X 184 415 X 900 X 200 610 X 120 610 X 190 300 X 600 X 90 610 X 321 610 X 370 300 X 600 X 90 300 X 570 X 110 300 X 125 610 X 161 610 X 141



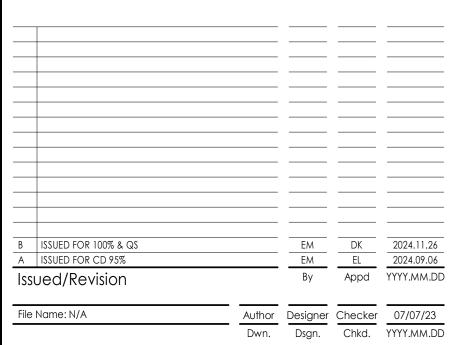
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UHN - Cardiac Diagnostic Services - Phase 3

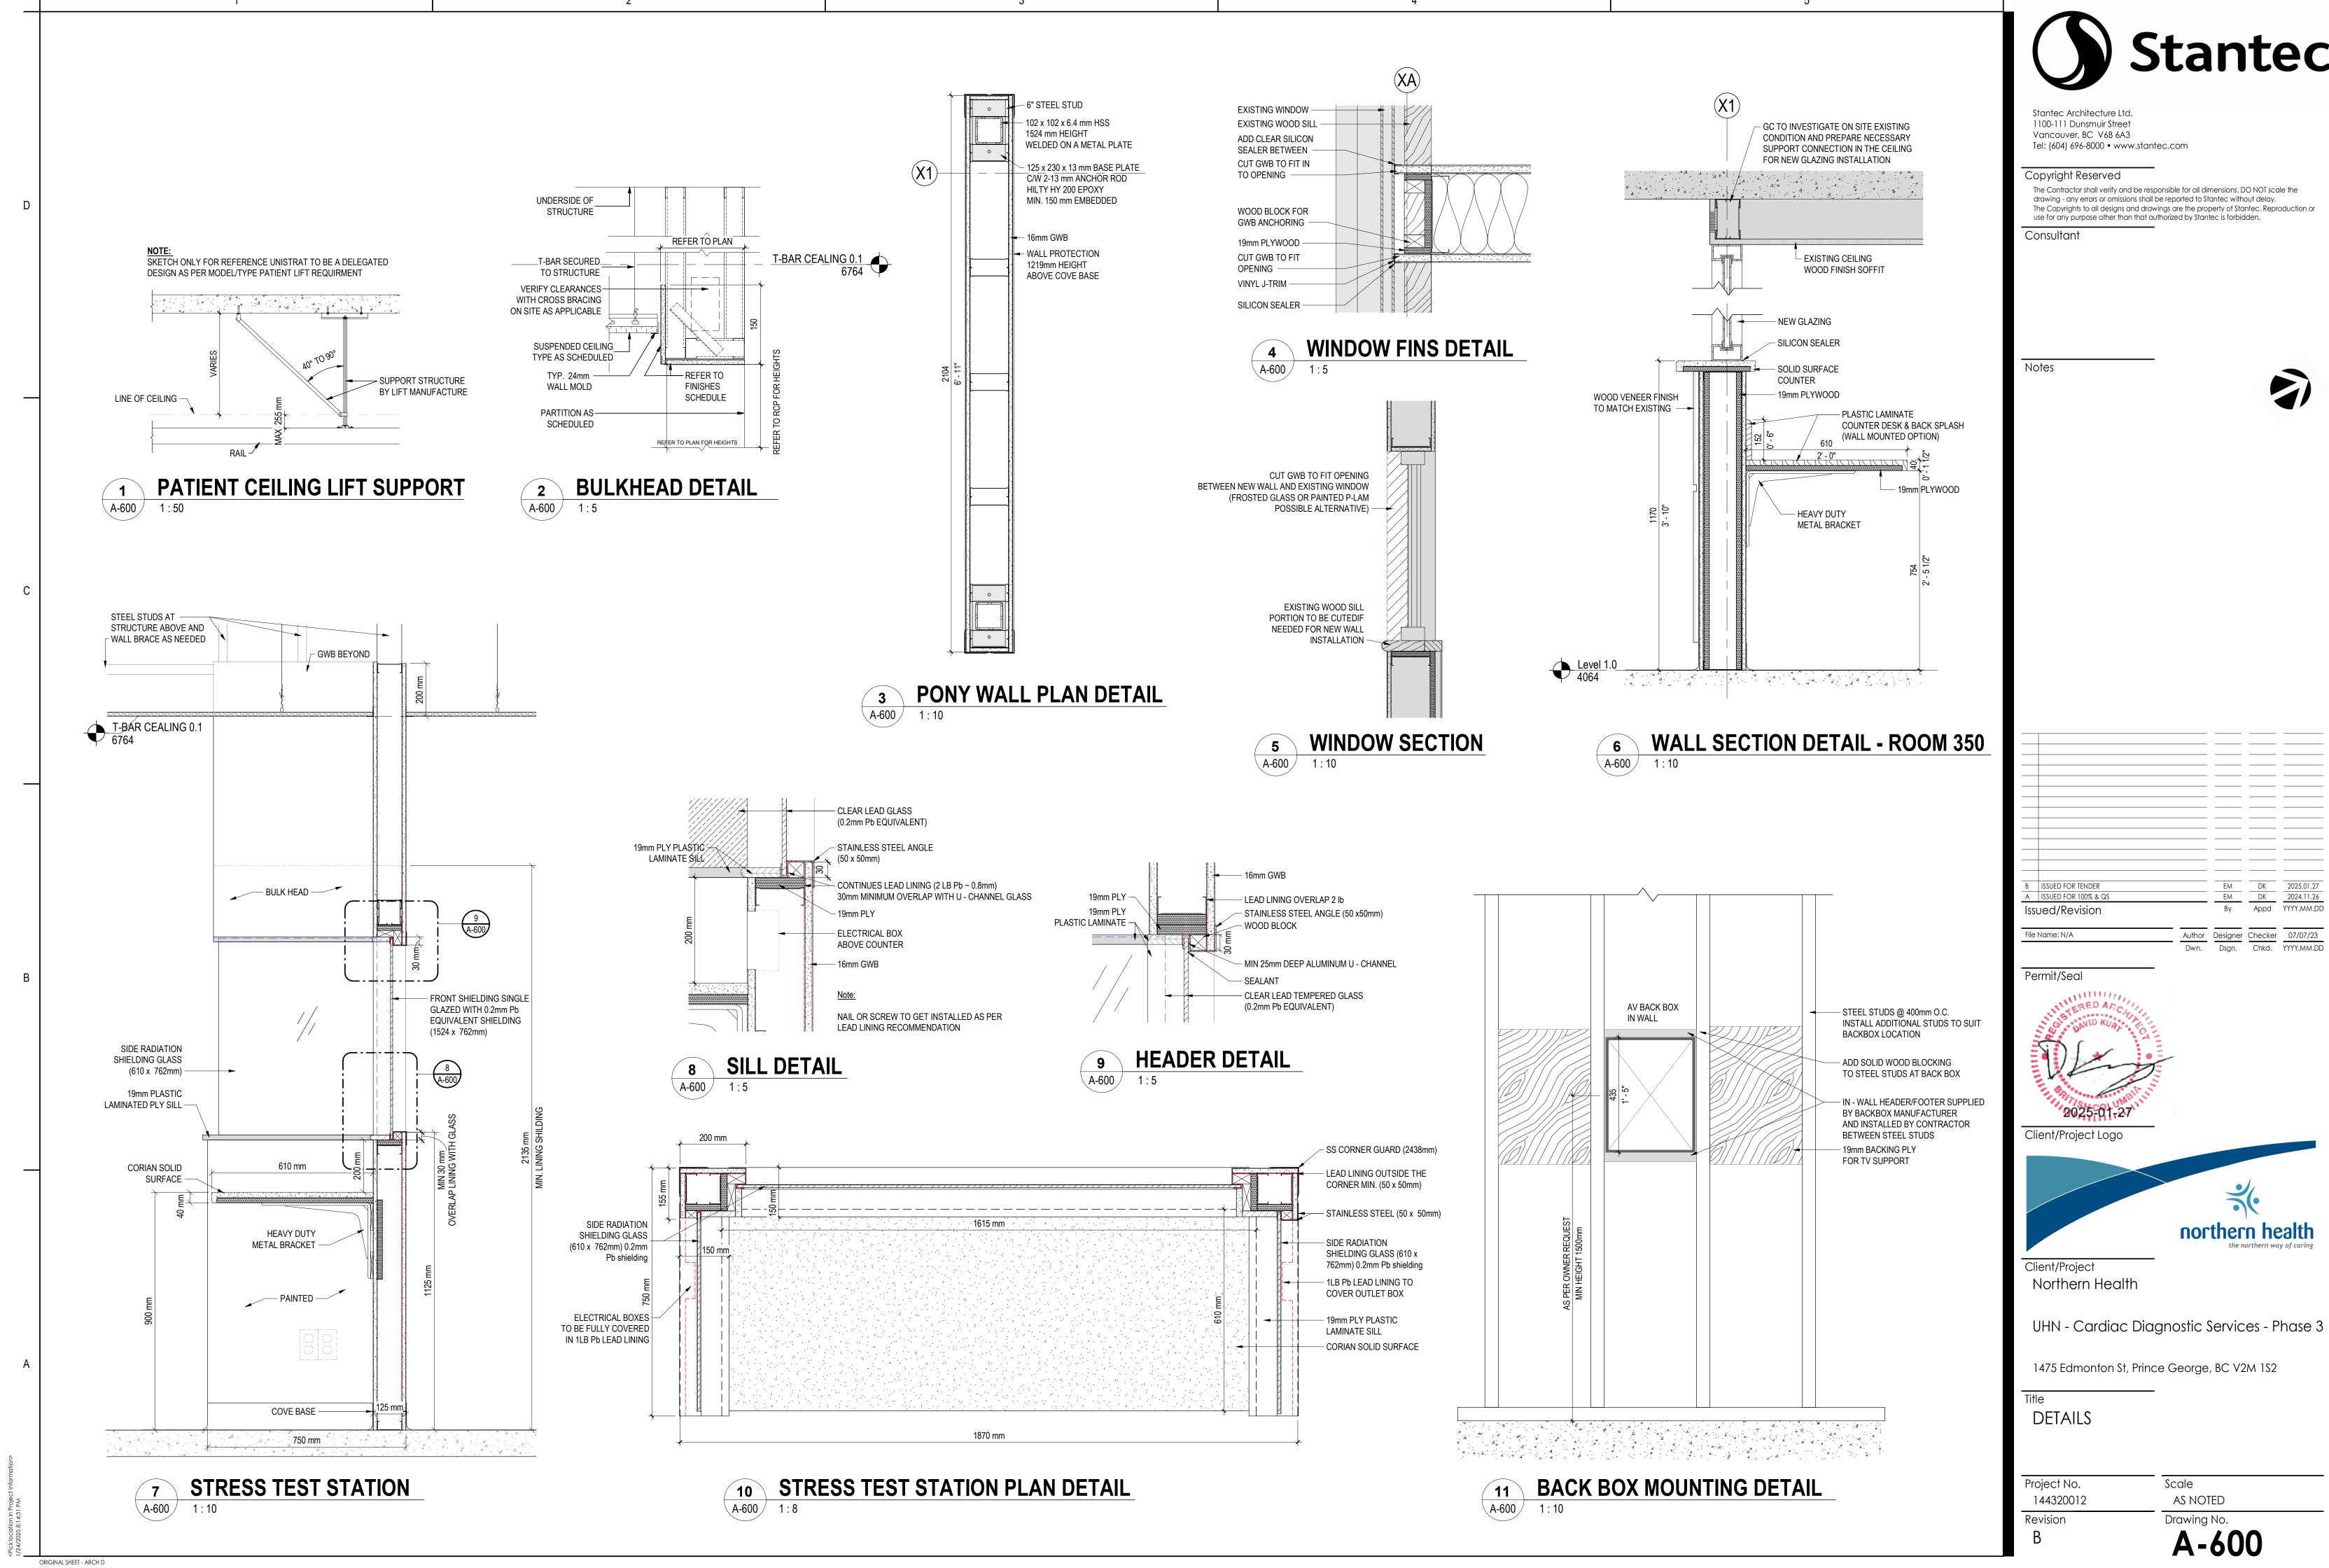
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Project No.	Scale
144320012	AS NOTED
Revision	Drawing No.

Drawing No.
A-500





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